
Exhibit B

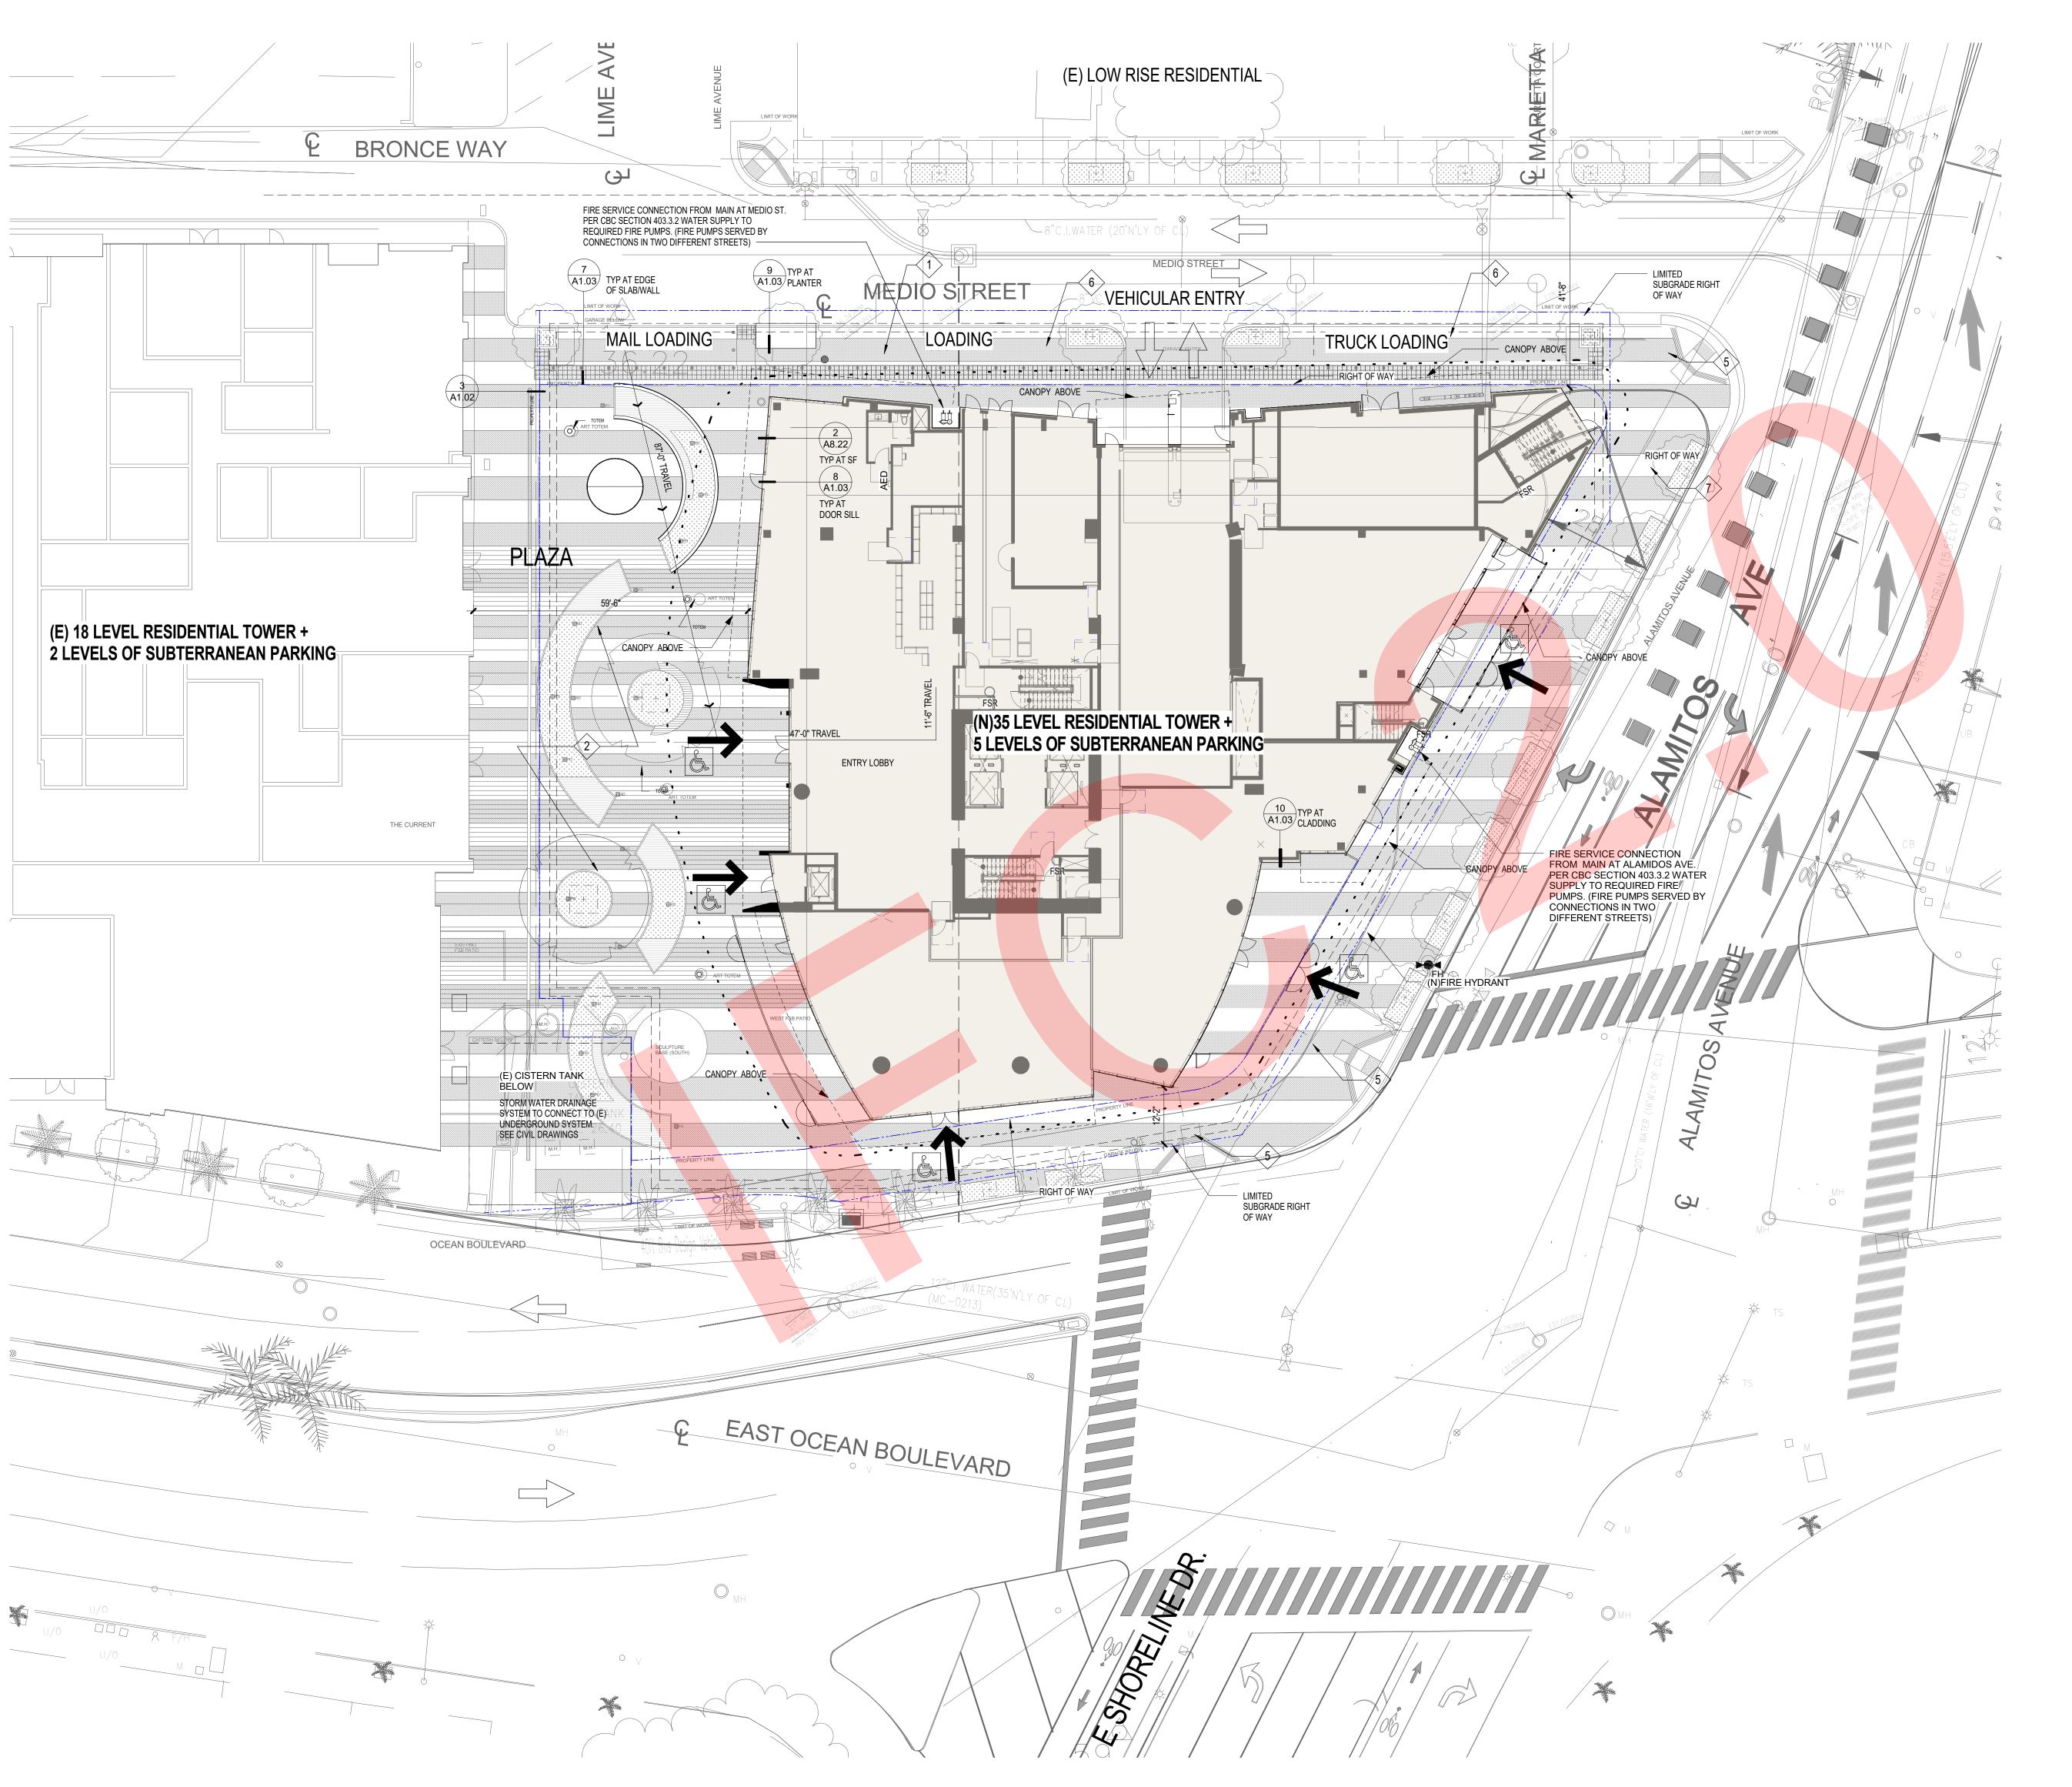

SITE PLAN GENERAL NOTES

<u>HORIZONTAL CONTROL/GRADING:</u> REFER TO CIVIL DRAWINGS FOR HORIZONTAL CONTROL AND FINE GRADING INFORMATION.

<u>PEDESTRIAN PAVING:</u>
REFER TO LANDSCAPE DRAWINGS FOR PEDESTRIAN PAVING TYPES AND FINISHES.

EXPANSION JOINTS: PROVIDE 1/2" WIDE EXPA COLOR TO MATCH ADJAC	NSION JOINTS WITH SEALANT WHERE PAVING ABUTS BUILDINGS, COLUMNS, OR OTHER STEENT PAVING COLOR.	RUCTURES. SEA	LANT		Carrierjohnson + architecture + environments + brand	suite 1650, los ange
	SITE KEYNOTES	DETAIL	SPEC SECTION		johns(environments	street, su
1 ACCESSIBL	E DROP OFF SIGNAGE	-	05 50 00		Carrier architecture +	s figueroa street,
2 COMMON P	LAZA PER LANDSCAPE PLANS	-	04 22 00		C2	725 s t
3 BIKE RACK		-	12 93 00	-		
4 AREA DRAII	N	-	DIV 22			
5 CURB RAM	P, PER CIVIL & LANDSCAPE PLANS		-	+		
6 ROLLED CU	RB			_		
7 STREET TR	EES SEE LANDSCAPE PLANS			_		
8 TRANSFOR	MER HATCH					
9 FENCE/ENC	LOSURE			_		
				_	¥	
				_	∑	vd., 802
				_	ÄT	an Bly A 90
ACCESS	SIBILITY AND SITE PLAN LEGEND	DETAIL	SPEC SECTION	_	SHORELINE GATEWAY	777 East Ocean Blvd., ong Beach, CA 90802
	FIRE HYDRANT LOCATED 6' FROM FACE OF CURB W/ BLUE		DIV 21			777 East Oc -ong Beach,
►●◀ FH	REFLECTIVE PAVEMENT MARKER, CFC 901.4.3, CFC 903.4 (PROVIDE 3'-0" DIA. MIN. CLEAR AREA, CFC 1001.7.2)		-	+		777 Lon
P.A.	PLANTER AREA	-	32 93 00	_	ည	
	ACCESSIBLE ENTRY			_		
	DIRECTIONAL ARROW			_		
	▶ PROPERTY LINE			02/20/2020	IFC 2.0	
	TRAVEL DISTANCE FROM MAIL DELIVERY					
	ACCESSIBILITY PATH OF TRAVEL PER CBC 11B PATH OF TRAVEL (POT) AS INDICATED IS A BARRIER FREE ACCESS ROUTE WITHOUT					
	ANY ABRUPT VERTICAL CHANGES EXCEEDING 1/2" BEVELED AT 1:2 MAXIMUM SLOPE, EXCEPT THAT VERTICAL CHANGES DO NOT EXCEED 1/4" VERTICAL AND IS AT LEAST 48" WIDE. SURFACE IS SLIP RESISTANT (MEDIUM BROOM FINISH WITH AMPLITUDE OF 1/16" TO 1/32"), STABLE, FIRM AND SMOOTH. CROSS SLOPE DOES NOT EXCEED 2%			07/26/2019	Full Permi	t Resubmittal
	AND SLOPE IN THE DIRECTION OF TRAVEL IS NOT MORE THAN 5% UNLESS OTHERWISE INDICATED. POT SHALL BE MAINTAINED FREE OF OVERHANGING OBSTRUCTIONS TO 80"MINIMUM ABD PRORUDING OBJECTS GREATER THAN 4"					
	PROJECTION FROM WALL AND ABOVE 27" AND LESS THAN 80" CONTRACTOR TO VERIFY THAT THERE ARE NO BARRIERS IN THE POT, AND THE POT COMPLIES WITH CBC 11B-403, 405.			06/7/2019	Full Permi	t Resubmittal
	ACCESSIBLE BUILDING ENTRANCE - PROVIDE INTERNATIONAL SYMBOL OF ACCESSIBILITY ENTRANCE SIGN (6"X6" DECAL MOUNTED BETWEEN 4'-0" TO 5'-0"		-			
	A.F.F, CENTERED ON SINGLE DOORS, CENTERED ON RIGHT PANEL OF DOUBLE DOORS) PER CBC 11B-404			03/09/2019	LBFD	
+ + + + +	TREE PLANTERS			02/07/2019	ASI-011/\	/E TIER 3
				01/24/2019		
					7.01 000/	, E HEIKE
				11/07/2018	FOUNDA	TION ONLY
				04/20/2018		
				03/12/2018	75% BID S	SET SUBMITTAL
				10/16/20 08/10/2017	100% DD 5	SUBMITTAL UBMITTAL
			-	DATE:	SED ARC CLAUDIA C-2763 5-31-2	ISSUE CHITCHE A C. 1
				PROJECT 5727.00	OF CAL	IFORTH!

CULTURA

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ARCHITECTURAL ON SITE PLAN

A1.00

1 SITE PLAN 1/16" = 1'-0"

	BOMA GROSS AREA	
Not Placed AMENITY	0 SF	RESIDE
CORE+BOH	0 SF	LEVEL
RESIDENTIAL UNIT	0 SF	CORE+
LEVEL B5		CORRII RESIDE
CORE+BOH	4,919 SF	
PARKING	30,161 SF	LEVEL :
LEVEL B4	4 F00 CF	CORRIE
CORE+BOH PARKING	1,582 SF 30,555 SF	RESIDE
EVEL D0		LEVEL 2
LEVEL B3 CORE+BOH	2,258 SF	CORE+
PARKING	29,874 SF	RESIDE
LEVEL B2		LEVEL 2
CORE+BOH PARKING	2,341 SF 29,766 SF	CORE+
AMMING	29,700 31	RESIDE
LEVEL B1 CORE+BOH	4,202 SF	LEVEL 2
PARKING	27,824 SF	CORE+
LEVEL 1		CORRIE
AMENITY	2,226 SF	
CORE+BOH LEASING OFFICE + LOBBY	5,489 SF 2,011 SF	LEVEL 2
RETAIL	6,431 SF	CORRIE
LEVEL 2		RESIDE
AMENITY	4,000 SF	LEVEL 2
CORE+BOH CORRIDOR	1,616 SF 1,507 SF	CORE+I
RESIDENTIAL UNIT	10,299 SF	RESIDE
_EVEL 3		LEVEL 2
AMENITY	4,033 SF	CORE+I
CORE+BOH CORRIDOR	1,243 SF 773 SF	CORRIE RESIDE
RESIDENTIAL UNIT	6,640 SF	
_EVEL 4		LEVEL 2 CORE+I
CORE+BOH	940 SF	CORRIE
CORRIDOR RESIDENTIAL UNIT	1,060 SF 10,476 SF	RESIDE
_EVEL 5		LEVEL 2
CORE+BOH	940 SF	CORRIE
CORRIDOR RESIDENTIAL UNIT	1,067 SF 10,471 SF	RESIDE
	· · · · · · · · · · · · · · · · · · ·	LEVEL 2
LEVEL 6 CORE+BOH	940 SF	CORE+
CORRIDOR	1,061 SF	RESIDE
RESIDENTIAL UNIT	10,481 SF	 LEVEL :
LEVEL 7	040.05	CORE+
CORE+BOH CORRIDOR	940 SF 1,061 SF	CORRIE RESIDE
RESIDENTIAL UNIT	10,485 SF	LEVEL
LEVEL 8		CORE+I
CORE+BOH CORRIDOR	1,014 SF 1,061 SF	CORRIE
RESIDENTIAL UNIT	10,399 SF	
_EVEL 9		LEVEL 3
CORE+BOH	940 SF	CORRIE
CORRIDOR RESIDENTIAL UNIT	1,060 SF 10,467 SF	RESIDE
	,	LEVEL
LEVEL 10 CORE+BOH	940 SF	CORE+I
CORRIDOR	1,060 SF	RESIDE
RESIDENTIAL UNIT	10,468 SF	LEVEL 3
EVEL 11		AMENIT
CORE+BOH CORRIDOR	939 SF 1,060 SF	CORE+
RESIDENTIAL UNIT	10,492 SF	RESIDE
_EVEL 12		LEVEL :
CORE+BOH	940 SF	AMENIT
CORRIDOR RESIDENTIAL UNIT	1,060 SF 10,492 SF	CORE+
		RESIDE
LEVEL 13 CORE+BOH	940 SF	ROOF
CORRIDOR	1,060 SF	CORE+
RESIDENTIAL UNIT	10,489 SF	 ELEVAT
LEVEL 14	4.000.05	CORE+
CORE+BOH CORRIDOR	1,006 SF 1,054 SF	TOTAL
RESIDENTIAL UNIT	10,404 SF	
_EVEL 15		
CORE+BOH	946 SF	
CORRIDOR RESIDENTIAL UNIT	1,010 SF 10,514 SF	
LEVEL 16 CORE+BOH	946 SF	
000	1,010 SF	
	10,513 SF	
CORRIDOR RESIDENTIAL UNIT		
RESIDENTIAL UNIT	030 SE	
RESIDENTIAL UNIT	930 SF 1,011 SF	
RESIDENTIAL UNIT LEVEL 17 CORE+BOH		
RESIDENTIAL UNIT LEVEL 17 CORE+BOH CORRIDOR	1,011 SF	

GN	ROSS AREA - LEVEL
WT	BOMA GROSS AREA
RESIDENTIAL UNIT	10,556 SF
LEVEL 19	
CORE+BOH	945 SF
CORRIDOR RESIDENTIAL UNIT	1,011 SF 10,534 SF
RESIDENTIAL UNIT	10,334 3F
LEVEL 20	
CORE+BOH	1,018 SF
CORRIDOR RESIDENTIAL UNIT	1,010 SF 10,444 SF
LEVEL 21	040.05
CORE+BOH CORRIDOR	946 SF 1,010 SF
RESIDENTIAL UNIT	10,509 SF
LEVEL 22 CORE+BOH	946 SF
CORRIDOR	1,010 SF
RESIDENTIAL UNIT	10,507 SF
E\/E 22	
LEVEL 23 CORE+BOH	946 SF
CORRIDOR	1,010 SF
RESIDENTIAL UNIT	10,503 SF
LEVEL 24	
CORE+BOH	945 SF
CORRIDOR	1,011 SF
RESIDENTIAL UNIT	10,501 SF
LEVEL 25	
CORE+BOH	945 SF
CORRIDOR	1,011 SF
RESIDENTIAL UNIT	10,499 SF
LEVEL 26	
CORE+BOH	1,011 SF
CORRIDOR	1,012 SF
RESIDENTIAL UNIT	10,429 SF
LEVEL 27	
CORE+BOH	948 SF
CORRIDOR	1,012 SF
RESIDENTIAL UNIT	10,490 SF
LEVEL 28	
CORE+BOH	924 SF
CORRIDOR RESIDENTIAL UNIT	1,012 SF
RESIDENTIAL UNIT	10,558 SF
LEVEL 29	
CORE+BOH	943 SF
CORRIDOR RESIDENTIAL UNIT	1,009 SF 10,544 SF
RESIDENTIAL UNIT	10,344 3F
LEVEL 30	
CORE+BOH	945 SF
CORRIDOR RESIDENTIAL UNIT	1,009 SF 10,551 SF
LEVEL 31	
CORE+BOH CORRIDOR	943 SF 1,009 SF
RESIDENTIAL UNIT	1,009 SF 10,564 SF
LEVEL 32	1.004.05
CORE+BOH CORRIDOR	1,004 SF 981 SF
RESIDENTIAL UNIT	9,631 SF
LEVEL 33	020 SE
CORE+BOH CORRIDOR	928 SF 943 SF
RESIDENTIAL UNIT	9,543 SF
	
LEVEL 34	2 400 CF
AMENITY CORE+BOH	2,180 SF 1,089 SF
CORRIDOR	981 SF
RESIDENTIAL UNIT	6,582 SF
LEVEL 35	
AMENITY	738 SF
CORE+BOH	1,085 SF
CORRIDOR	661 SF
RESIDENTIAL UNIT	3,396 SF
ROOF	
CORE+BOH	1,253 SF
	
ELEVATOR MECHANICAL	4.000.05
CORE+BOH	1,268 SF
TOTAL	601,421 SF

noreline tower - UNIT MIX reas per BOMA standards)																								COUNT	% of TYPE	% of TOTAL	1 4 5 4 1 1 1 1 1 1 1 1 1 1 1 1 1 1 1 1	MA S AREAS	BOMA NET ARE
UDIOS	2 3	4	5 6	6 7	8	9 10	11	12 1	3 14	15	16 17	18	19 2	0 21	22 2	3 24	25 2	6 27	28	29 3	0 31	32	33 34	17	100%	5%	GSF	TOTAL GSF	ASF
		1	1 1	1 1	1	1 1	1																	8	47%	2.5%	597.0 sf	4,776 sf	5,558 s
(new studio)	1	1	1 1	1 1	1	1 1	1																	8	47% 6%	2.5% 0.3%	588.0 sf 616.0 sf	4,704 sf 616 sf	5,494 s 575 sf
STUDIO totals	1 0	2	2 2	2	2	2 2	2	0	0 0	0	0 0	0	0 (0 0	0 (0 0	0	0 0	0	0	0 0	0	0 0	17	0/6	5%	594 sf	10,096 sf	11,627
Jiobio Idiais		THE REAL PROPERTY.	-	-	-		-		• •	_	•	-		0				0 0	_		.	_	•	R 11500 B	8	0/0	37+31	10,070 31	11,027
SEDROOM/1 BATH									_										+				_	88	51%	28%			
-1a	1 1	1	1 1	1 1	1	1 1	1	1	1 1	1	1 1	1	1	1 1	1	1 1	1	1 1	1	1	1 1			30	17%	9.5%	830.0 sf	24,900 sf	23,271
-1b	1	1	1 1	1 1	1	1 1	1	1	1 1	1	1 1	1	1	1 1	1	1 1	1	1 1	1	1	1 1			29	17%	9.2%	830.0 sf	24,070 sf	22,576
A-2 A-3		1	1 1	1 1	1	1 1	1	1	1 1	1	1 1	1	1	1 1	1	1 1	1	1 1	1					25	14%	7.9% 1.3%	855.0 sf 1,076.8 sf	21,375 sf 4,307 sf	20,000 4,045 s
BEDROOM/1.5 BATH					2.5													•						26	15%	8%	1,07 0.0 31	4,007 31	4,045 .
-1	1 1	1	1 1	1 1		1 1	1	1	1	1	1 1	1	1	1	1	1 1	1	1	1	1	1 1			26	15%	8.3%	1,134.3 sf	29,493 sf	27,880
BEDROOM/1 BATH/DEN																							7	60	34%	19%		Oppochagnar	
G-1 G-2		1	1 1	1 1	1	1 1	1	1	1 1	1	1 1	1	1	1 1	1	1 1	1	1 1	1	1	1 1	1		29	17% 1%	9.2% 0.3%	1,081.0 sf 1,058.0 sf	31,349 sf 1,058 sf	30,015 1,016
2-2 2-3		1	1 1	1 1	1	1 1	1	1	1 1	1	1 1	1	1	1 1	1	1 1	1	1 1	1	1	1 1	1		28	16%	8.9%	1,036.0 sf	28,280 sf	26,847
3-4	1																							1	1%	0.3%	1,910.0 sf	1,910 sf	1,878 s
C-5 (new 1 bedroom)	1														0.00					_				1	1%	0.3%	1,987.0 sf	1,987 sf	1,935 s
1 BEDROOM totals	4 3	6	6 6	6	6	6 6	6	6	6 6	6	6 6	6	6 (6	6	6	6	6 6	6	5	5 5	2	0 0	174		55%	970 sf	168,729 sf	159,463
BEDROOM/2 BATH																			-			-		105	85%	33%	1,316.0 sf	1 214 -4	1,260 s
-1 -2a	1 1	1	1 1	1 1			1	1	1		1	1	1								1			13	10%	0.3% 4.1%	1,273.0 sf	1,316 sf 16,549 sf	15,758
-2b	. 70	10			1	1 1			1	1	1			1 1	1	1 1	1	1 1	1	1	1			17	14%	5.4%	1,241.0 sf	21,097 sf	20,070
-3		5	728 E	e 1 7/201	36	125 32	20	1	1 1	1	1 1	1	1	1 1	1	1 1	1	1 1	1	1	1 1			20	16%	6.3%	1,184.0 sf	23,680 sf	22,920
A-4 A-5a		1	1 1	1 1	1	1 1	1	1	1 1	1	1 1	1	1	1 1	1	1 1	1	1 1	1					25	20% 9%	7.9% 3.5%	1,256.0 sf 1,181.0 sf	31,400 sf 12,991 sf	29,825 12,391
A-5b					•			•		1	1 1	1	1	1 1	1	1 1	1	1 1	1					14	11%	4.4%	1,227.0 sf	17,178 sf	16,450
4-6	1																							1	1%	0.3%	1,257.0 sf	1,257 sf	1,203 s
A-7	1 1																							2	2% 1%	0.6%	1,298.0 sf	2,596 sf	2,449 s
A-8 BEDROOM/2.5 BATH	-																		-					2	2%	0.3%	1,391.0 sf	1,391 sf	1,303 s
-1																						1		1	1%	0.3%	1,502.0 sf	1,502 sf	1,440 s
-2																						1		1	1%	0.3%	1,570.0 sf	1,570 sf	1,509 s
BEDROOM/2 BATH/DEN																								8	6%	3%	1 701 0 -6	£ 102 -4	4.000 -
C-1 C-2																				1	1 1			3	2% 2%	1.0%	1,701.0 sf 1,650.0 sf	5,103 sf 4,950 sf	4,900 s 4,755 s
2-3																						1		1	1%	0.3%	1,589.0 sf	1,589 sf	1,510 s
-4																						1		1	1%	0.3%	1,575.0 sf	1,575 sf	1,515 s
BEDROOM/2.5 BATH PENTHOUSE																							1	3	2%	0.3%	1,836.0 sf	1,836 sf	1,762 s
1-4 1-5																							i	1	1%	0.3%	1,754.0 sf	1,030 si 1,754 sf	1,762 s
1-8																							1	1	1%	0.3%	1,933.0 sf	1,933 sf	1.784 s
BEDROOM/2.5 BATH/DEN PENTHOUSE																								6	5%	2%			
-1 -2																							1	1	1%	0.3%	2,484.0 sf 2,679.0 sf	2,484 sf 2,679 sf	2,247 s 2,587 s
-3																							1	1	1%	0.3%	2,452.0 sf	2,452 sf	2,400 s
-6																							1	1	1%	0.3%	2,410.5 sf	2,411 sf	2,341 s
																							1	1	1% 1%	0.3%	2,355.0 sf	2,355 sf	2,255
1-7							- 72			- 12		100	20 1					A A	1	1	4 4	E	1 2	124	170	0.3% 39%		2,115 sf 165,763 sf	2,044 :
-7 -9	3 3	3	3 3	3 3	3	3 3	3	4	4 4	4	4 4	4	4	4 4	4	4	4	4 4				Market Street				The second of th			
	3 3	3									4 4	4	4	4 4		4								315		37/0	1,000.037	344,588 sf	

BOMA GROS	S AREA - PARKING LEVEL						
AMENITY	0 SF						
CORE+BOH	15,302 SF						
PARKING	148,180 SF						
RESIDENTIAL UNIT	0 SF						
GRAND TOTAL	163,481 SF						
BOMA GROSS AREA - ABOVE GRADE							
AMENITY	13,177 SF						
AMENITY CORE+BOH							
	13,177 SF						
CORE+BOH	13,177 SF 41,606 SF						
CORE+BOH CORRIDOR	13,177 SF 41,606 SF 34,689 SF						
CORE+BOH CORRIDOR LEASING OFFICE + LOBBY	13,177 SF 41,606 SF 34,689 SF 2,011 SF						

BOMA NET AREA								
RESIDENTIAL UNIT	317,469 SF							
LEASING OFFICE + LOBBY	2,004 SF							
RETAIL	6,643 SF							
AMENITY	8,601 SF							
CORRIDOR	34,399 SF							

SCHOOL FEE RESIDENTIAL AREA: 437,277 SF

Carrieriphnson + CULTUR3

architecture + environments + brand strategy + graphics
725 s figueroa street, suite 1650, los angeles, ca 90017

HORELINE GATEWAY

S

02/20/2020 IFC 2.0 08/29/2019 ASI 021.2 07/26/2019 Full Permit Resubmittal 07/5/2019 ASI 021.1 06/7/2019 ASI 021 06/7/2019 Full Permit Resubmittal 03/09/2019 LBFD 01/24/2019 2ND BUILDING SUB. 11/21/2018 ASI-003 11/07/2018 FOUNDATION ONLY 09/14/2018 2ND PLANNING SUB. 04/20/2018 1ST CITY SUBMITTAL 04/03/2018 ADDENDUM A 03/12/2018 75% BID SET 02/21/2018 50% CD SUBMITTAL 10/16/20 100% DD SUBMITTAL 08/10/2017 50% DD SUBMITTAL DATE:



PROJECT NO: 5727.00

FILE NAME:
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(I.E. P:\0000.000\BIM\Central File\0000.00-central.rvt)


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CNL Checker


TITLE:

AREA

WING NO:

0.11

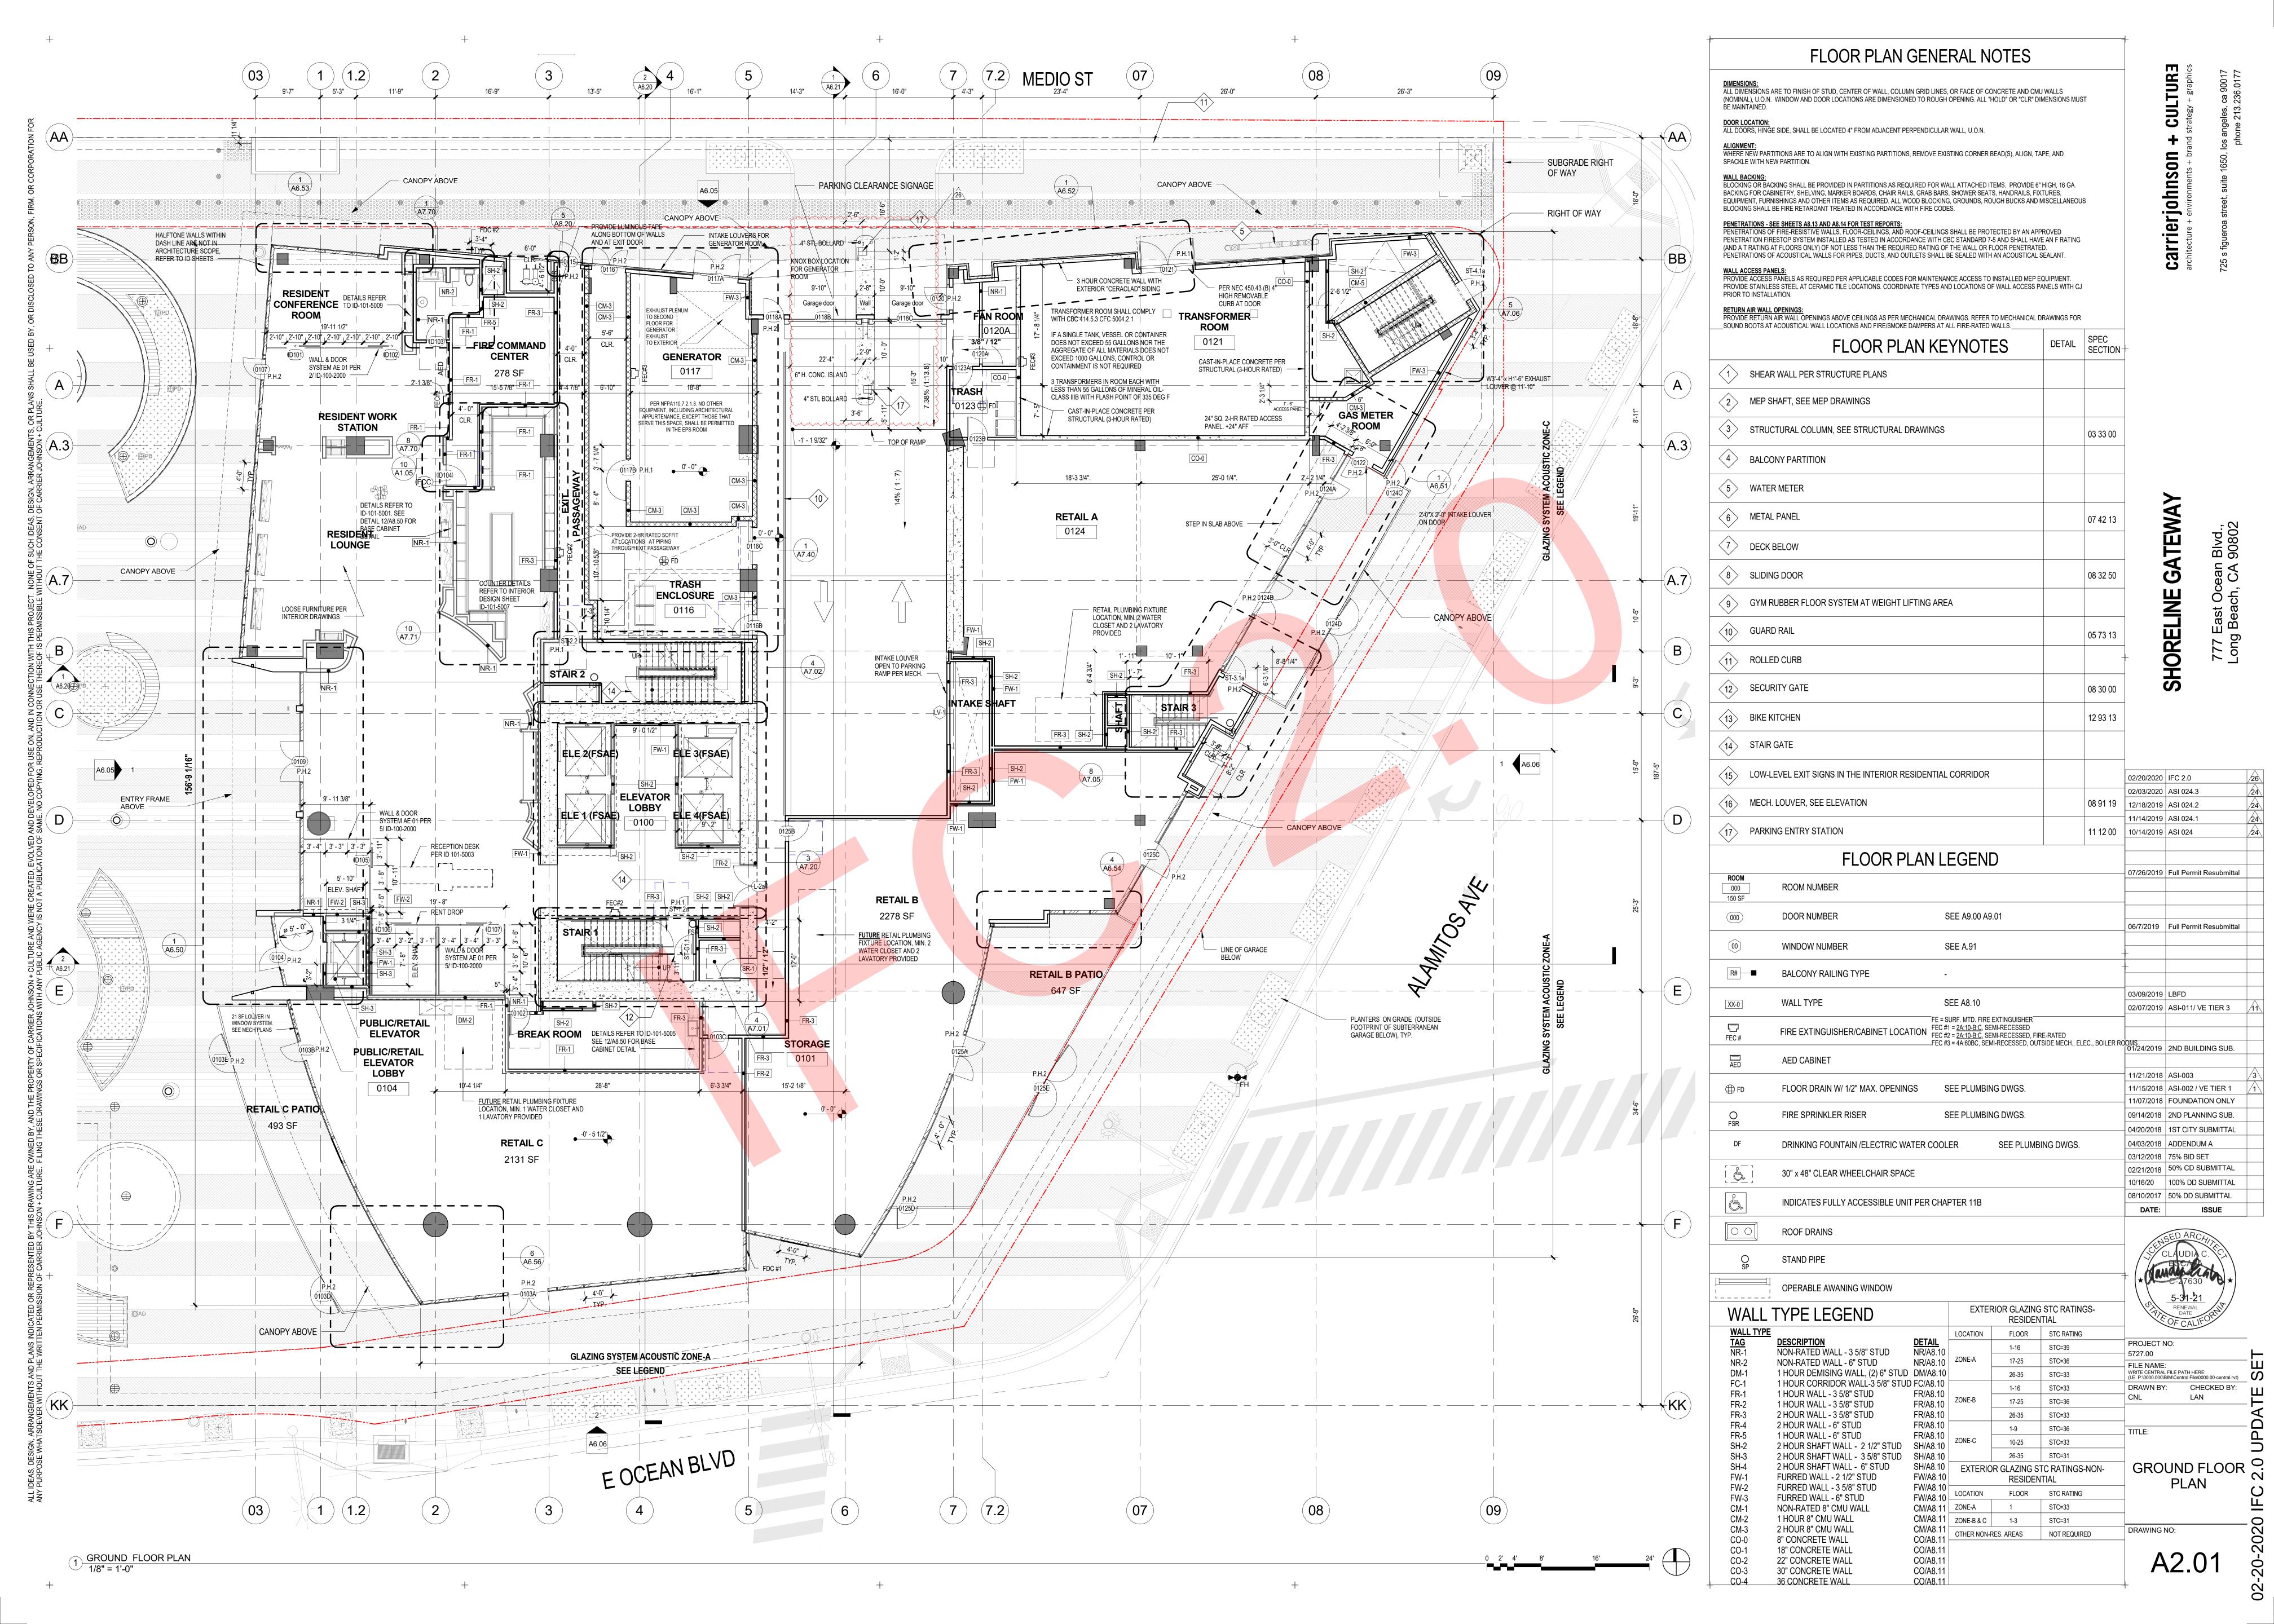

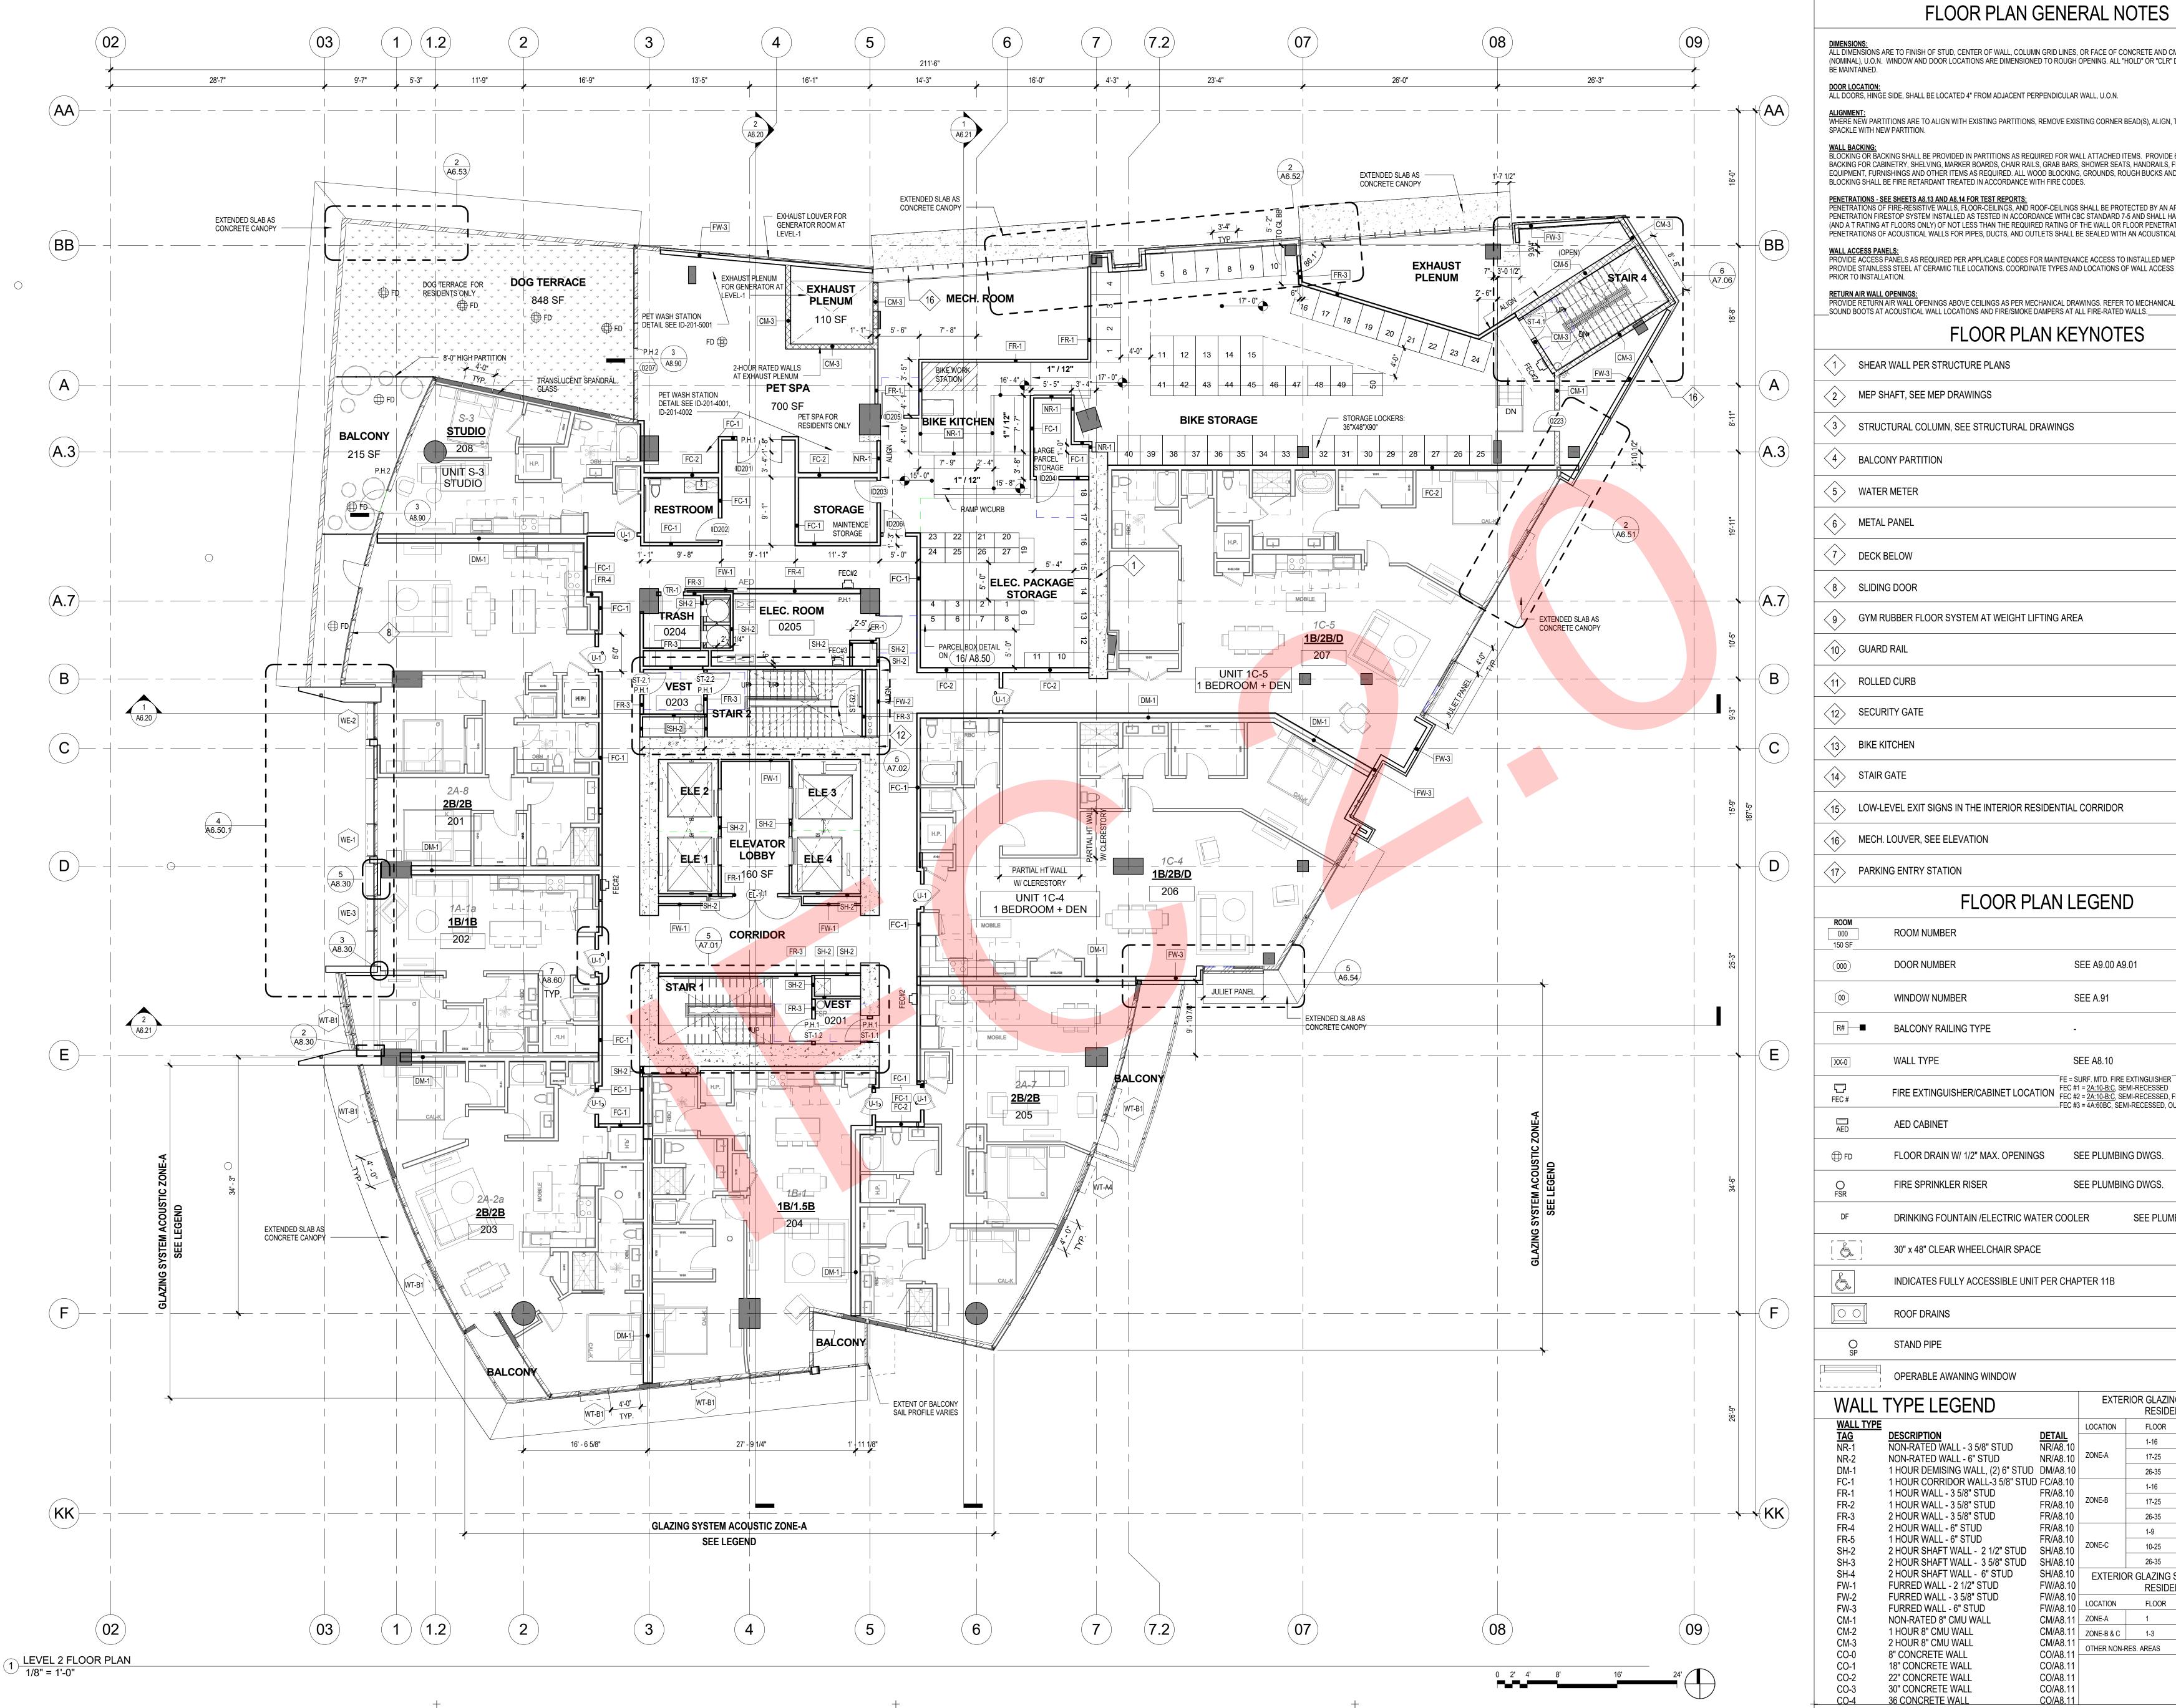

CULTURA ALL DIMENSIONS ARE TO FINISH OF STUD, CENTER OF WALL, COLUMN GRID LINES, OR FACE OF CONCRETE AND CMU WALLS (NOMINAL), U.O.N. WINDOW AND DOOR LOCATIONS ARE DIMENSIONED TO ROUGH OPENING, ALL "HOLD" OR "CLR" DIMENSIONS MUST <u>DOOR LOCATION:</u>
ALL DOORS, HINGE SIDE, SHALL BE LOCATED 4" FROM ADJACENT PERPENDICULAR WALL, U.O.N. ALIGNMENT:
WHERE NEW PARTITIONS ARE TO ALIGN WITH EXISTING PARTITIONS, REMOVE EXISTING CORNER BEAD(S), ALIGN, TAPE, AND carrierjohnson WALL BACKING:
BLOCKING OR BACKING SHALL BE PROVIDED IN PARTITIONS AS REQUIRED FOR WALL ATTACHED ITEMS. PROVIDE 6" HIGH, 16 GA. BACKING FOR CABINETRY, SHELVING, MARKER BOARDS, CHAIR RAILS, GRAB BARS, SHOWER SEATS, HANDRAILS, FIXTURES. EQUIPMENT, FURNISHINGS AND OTHER ITEMS AS REQUIRED, ALL WOOD BLOCKING, GROUNDS, ROUGH BUCKS AND MISCELLANEOUS BLOCKING SHALL BE FIRE RETARDANT TREATED IN ACCORDANCE WITH FIRE CODES. PENETRATION FIRESTOP SYSTEM INSTALLED AS TESTED IN ACCORDANCE WITH CBC STANDARD 7-5 AND SHALL HAVE AN F RATING (AND A T RATING AT FLOORS ONLY) OF NOT LESS THAN THE REQUIRED RATING OF THE WALL OR FLOOR PENETRATED. PENETRATIONS OF ACOUSTICAL WALLS FOR PIPES, DUCTS, AND OUTLETS SHALL BE SEALED WITH AN ACOUSTICAL SEALANT. WALL ACCESS PANELS:
PROVIDE ACCESS PANELS AS REQUIRED PER APPLICABLE CODES FOR MAINTENANCE ACCESS TO INSTALLED MEP EQUIPMENT. RETURN AIR WALL OPENINGS:
PROVIDE RETURN AIR WALL OPENINGS ABOVE CEILINGS AS PER MECHANICAL DRAWINGS. REFER TO MECHANICAL DRAWINGS FOR SOUND BOOTS AT ACOUSTICAL WALL LOCATIONS AND FIRE/SMOKE DAMPERS AT ALL FIRE-RATED WALLS. FLOOR PLAN KEYNOTES SHEAR WALL PER STRUCTURE PLANS MEP SHAFT, SEE MEP DRAWINGS STRUCTURAL COLUMN, SEE STRUCTURAL DRAWINGS 03 33 00 BALCONY PARTITION 9 GYM RUBBER FLOOR SYSTEM AT WEIGHT LIFTING AREA S SECURITY GATE BIKE KITCHEN 12 93 13 (15) LOW-LEVEL EXIT SIGNS IN THE INTERIOR RESIDENTIAL CORRIDOR 02/20/2020 | IFC 2.0 02/03/2020 ASI 024.3 16 MECH. LOUVER, SEE ELEVATION 08 91 19 | 12/18/2019 | ASI 024.2 1/14/2019 ASI 024.1 17 PARKING ENTRY STATION 11 12 00 | 10/14/2019 | ASI 024 FLOOR PLAN LEGEND 08/29/2019 | ASI 021.2 07/26/2019 Full Permit Resubmitta 07/5/2019 | ASI 021.1 **ROOM NUMBER** 06/7/2019 ASI 021 DOOR NUMBER SEE A9.00 A9.01 06/7/2019 Full Permit Resubmittal WINDOW NUMBER SEE A.91 BALCONY RAILING TYPE 03/09/2019 LBFD WALL TYPE SEE A8.10 FE = SURF. MTD. FIRE EXTINGUISHER FIRE EXTINGUISHER/CABINET LOCATION FEC #1 = $\frac{2A:10-B:C}{EC}$, SEMI-RECESSED FEC #2 = $\frac{2A:10-B:C}{EC}$, SEMI-RECESSED, FIRE-RATED _FEC #3 = 4A:60BC, SEMI-RECESSED, OUTSIDE MECH., ELEC., BOILER ROOMS AED CABINET FLOOR DRAIN W/ 1/2" MAX. OPENINGS SEE PLUMBING DWGS. FIRE SPRINKLER RISER SEE PLUMBING DWGS. 04/20/2018 | 1ST CITY SUBMITT. 04/03/2018 | ADDENDUM A DRINKING FOUNTAIN /ELECTRIC WATER COOLER SEE PLUMBING DWGS. 03/12/2018 | 75% BID SET 02/21/2018 \mid 50% CD SUBMITTAL 30" x 48" CLEAR WHEELCHAIR SPACE 10/16/20 | 100% DD SUBMITTAL 08/10/2017 | 50% DD SUBMITTAL INDICATES FULLY ACCESSIBLE UNIT PER CHAPTER 11B ROOF DRAINS STAND PIPE OPERABLE AWANING WINDOW EXTERIOR GLAZING STC RATINGS-WALL TYPE LEGEND RESIDENTIAL FLOOR STC RATING DETAIL NR/A8.10 PROJECT NO: NON-RATED WALL - 3 5/8" STUD 5727.00 NR/A8.10 ZONE-A 17-25 STC=36 NON-RATED WALL - 6" STUD FILE NAME:
WRITE CENTRAL FILE PATH HERE:
(I.E. P:\00000.000\BIM\Central File\0000.00-central.rvt) 1 HOUR DEMISING WALL, (2) 6" STUD DM/A8.10 26-35 STC=33

DRAWN BY:

DRAWING NO:

1-16 STC=33

17-25 STC=36

26-35 STC=33

10-25 STC=33

26-35 STC=31

RESIDENTIAL

OTHER NON-RES. AREAS NOT REQUIRED

FLOOR STC RATING

STC=36

1-9____

SH/A8.10 EXTERIOR GLAZING STC RATINGS-NON-

CM/A8.11 | ZONE-B & C | 1-3 STC=31

FR/A8.10

FR/A8.10

FR/A8.10

FR/A8.10

FW/A8.10

FW/A8.10

FW/A8.10 -

CO/A8.11

CO/A8.11

CO/A8.11

CM/A8.11 ZONE-A


FR/A8.10 ZONE-B


CHECKED BY:

LEVEL 2 FLOOR

PLANS

A2.02

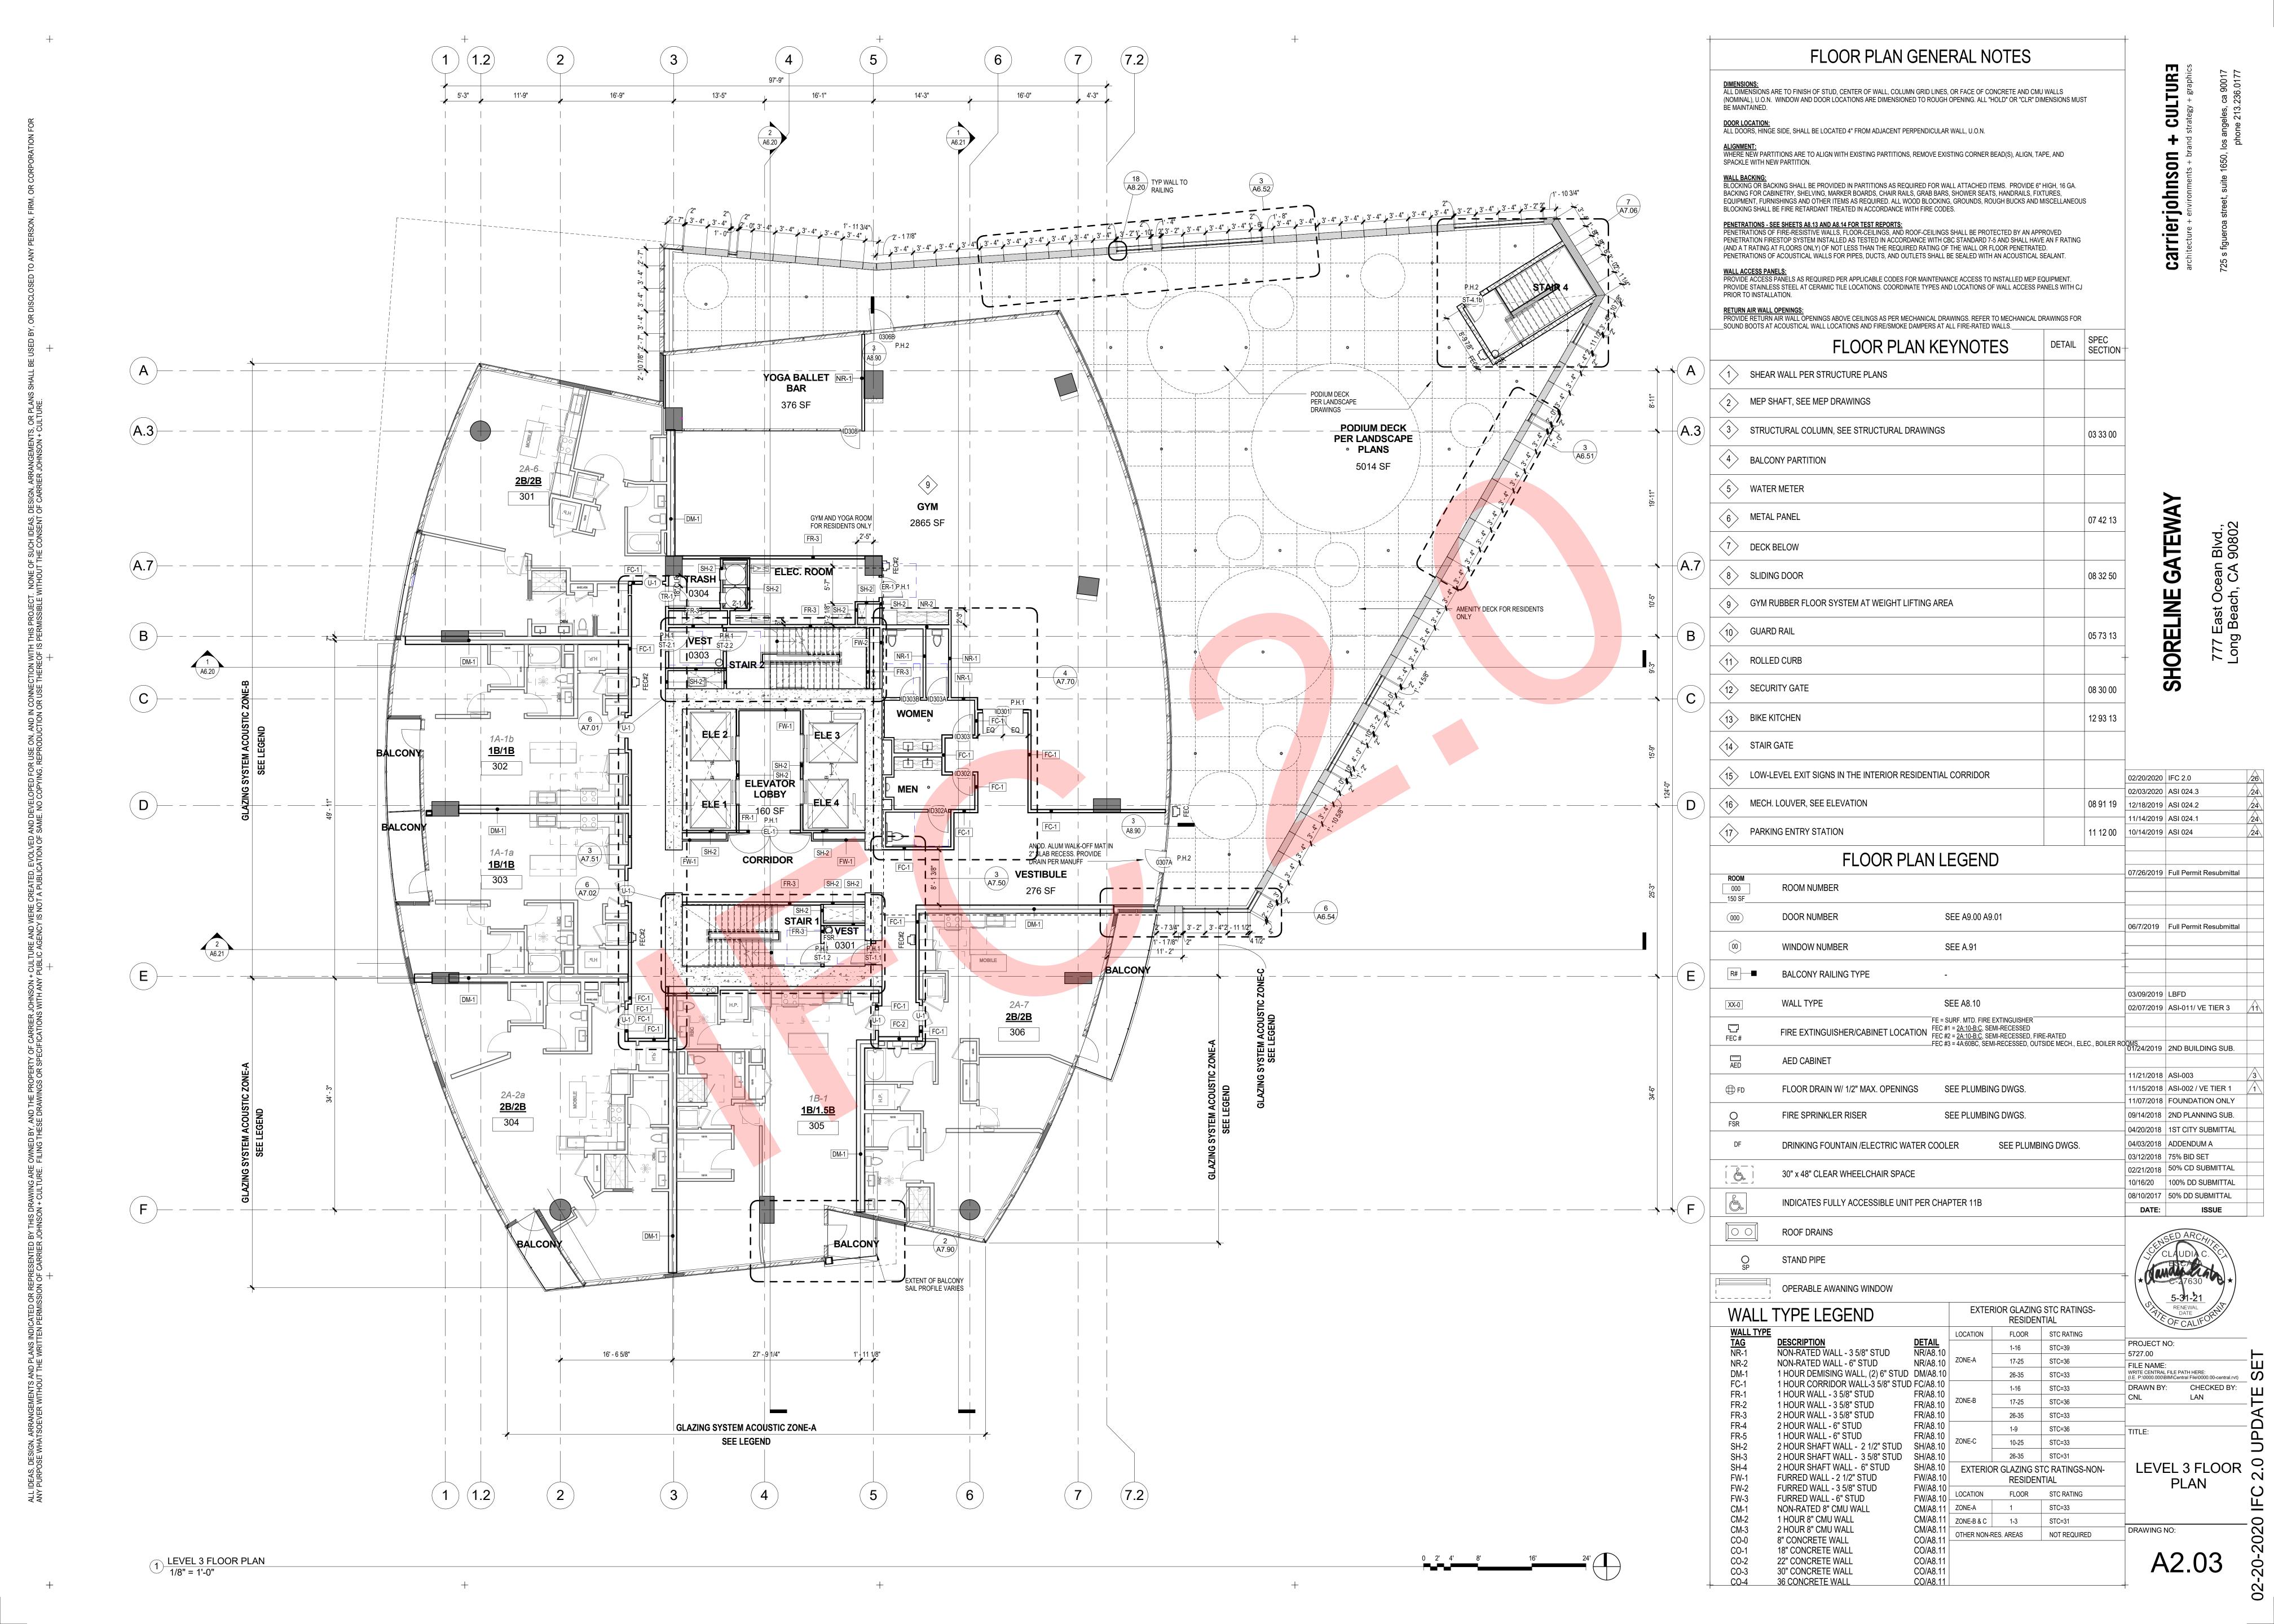

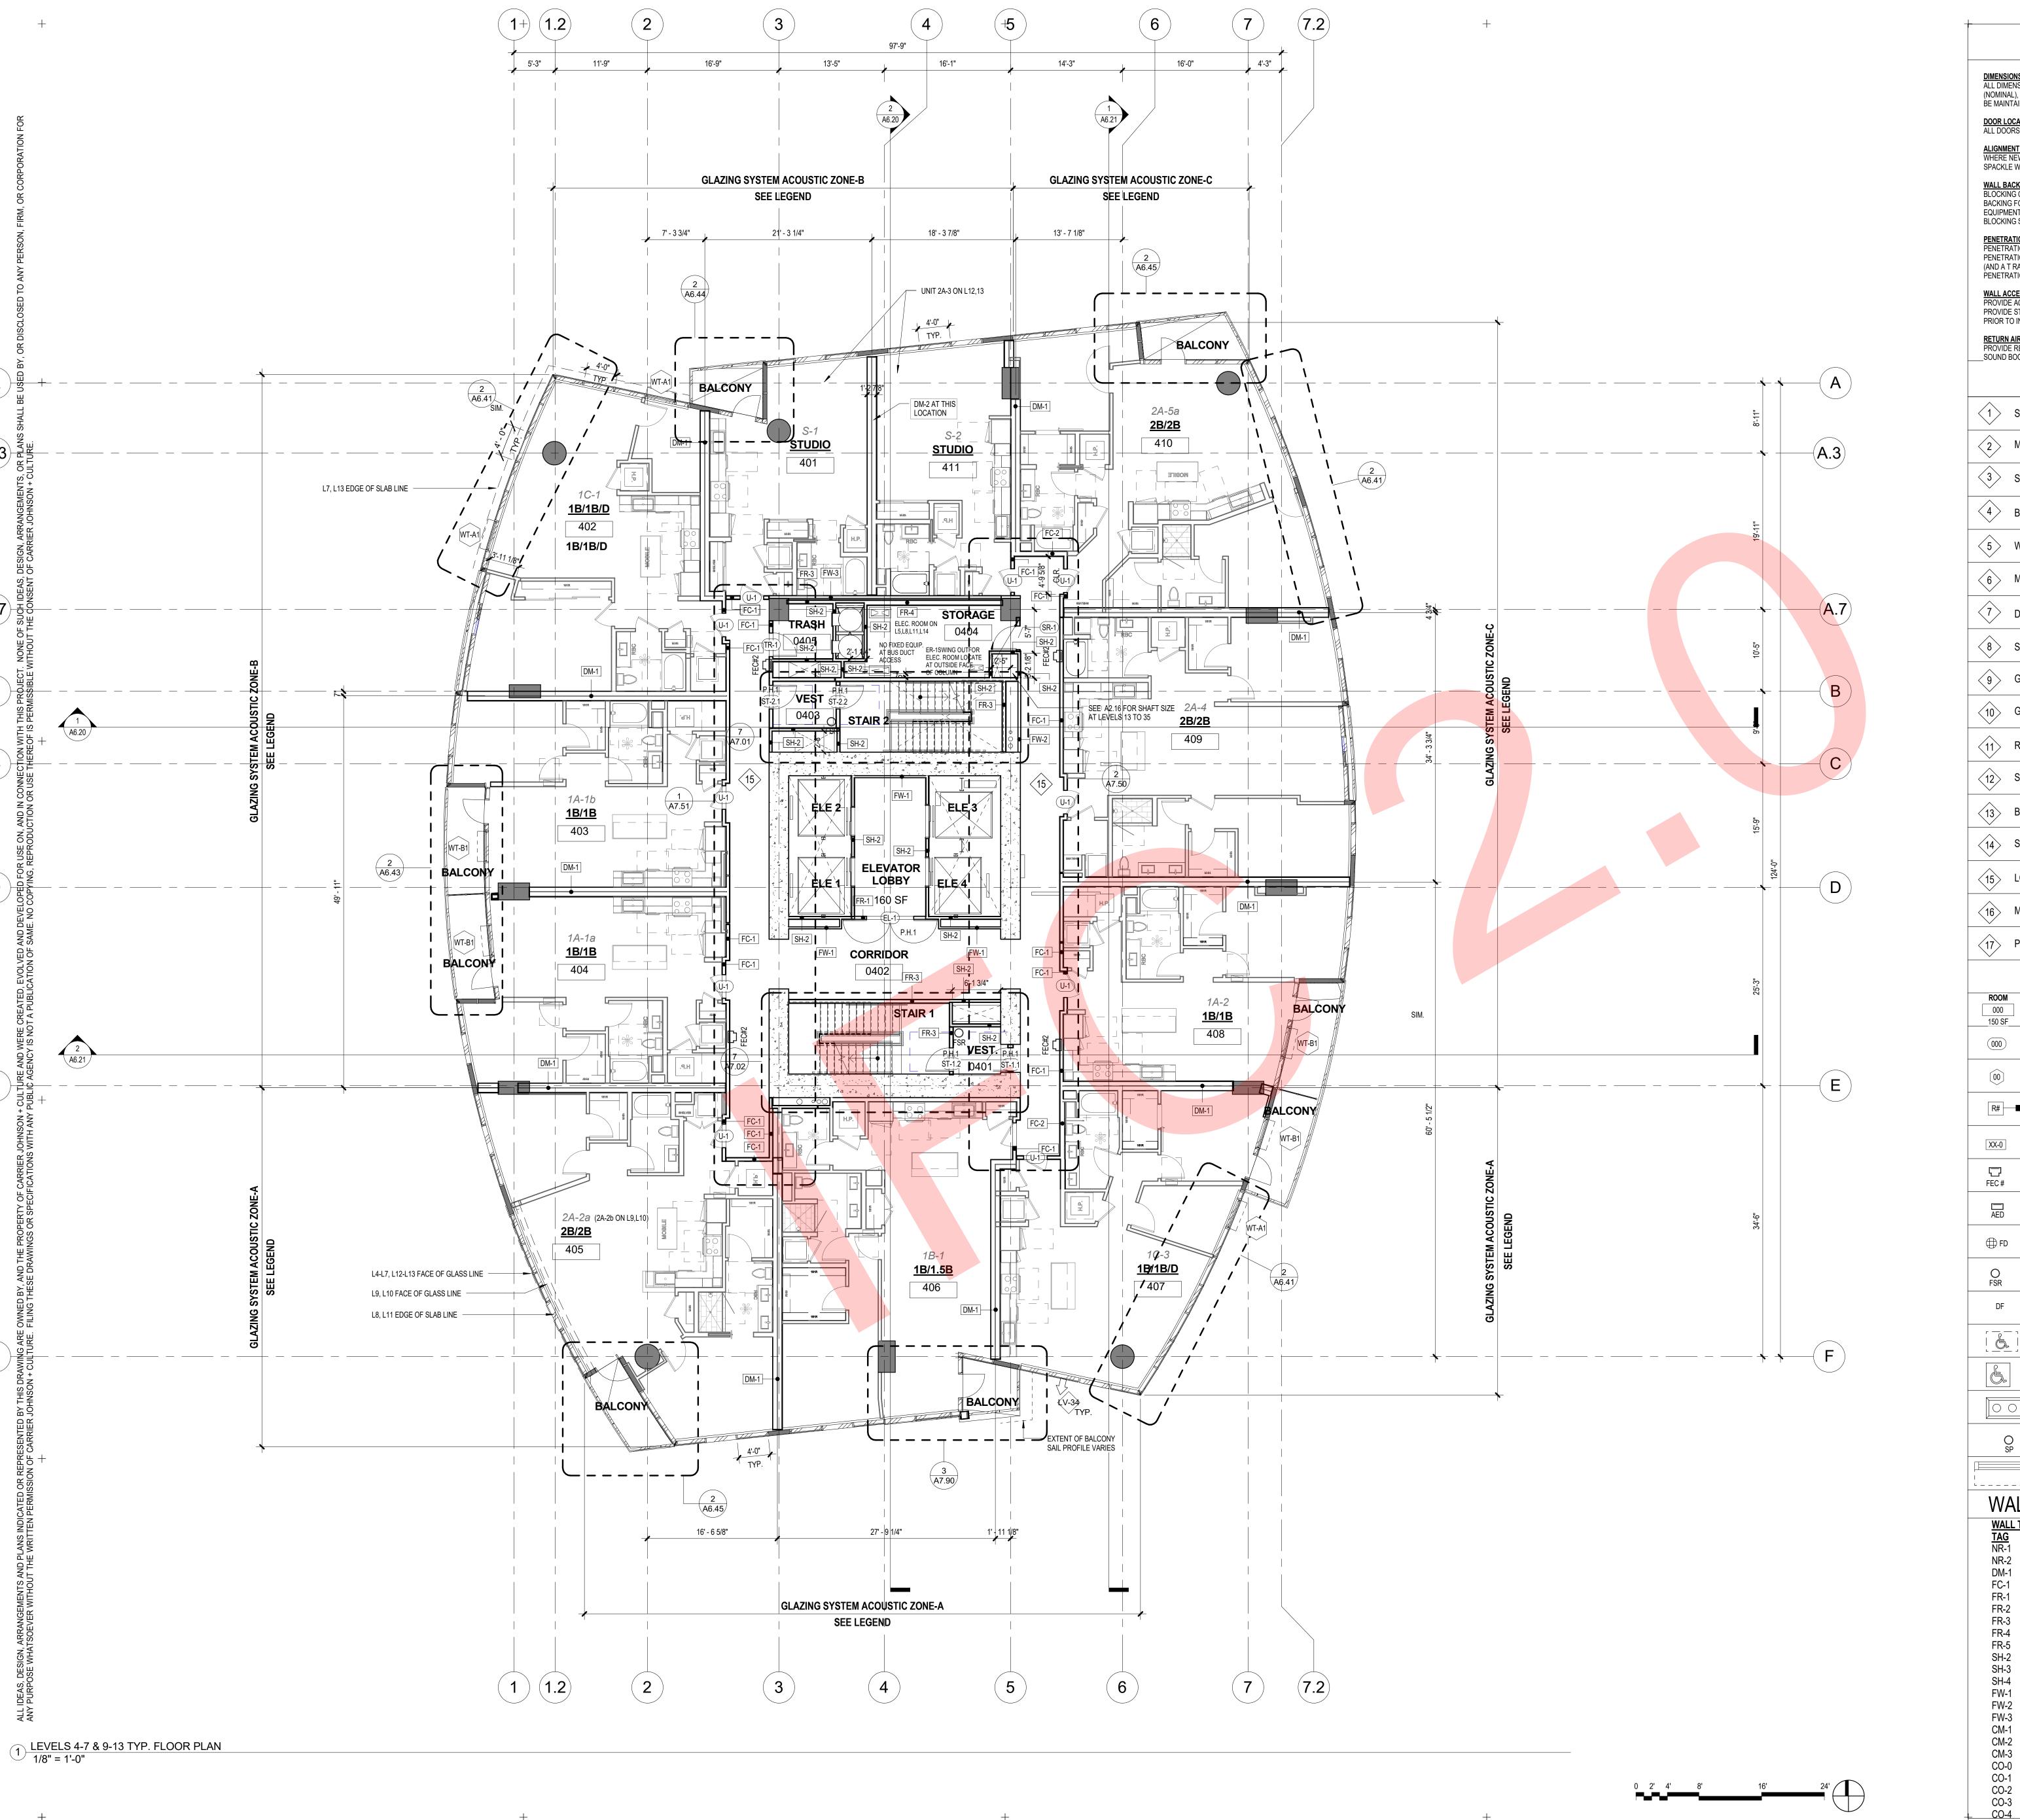

FLOOR PLAN GENERAL NOTES DIMENSIONS:
ALL DIMENSIONS ARE TO FINISH OF STUD, CENTER OF WALL, COLUMN GRID LINES, OR FACE OF CONCRETE AND CMU WALLS (NOMINAL), U.O.N. WINDOW AND DOOR LOCATIONS ARE DIMENSIONED TO ROUGH OPENING. ALL "HOLD" OR "CLR" DIMENSIONS MUST <u>DOOR LOCATION:</u>
ALL DOORS, HINGE SIDE, SHALL BE LOCATED 4" FROM ADJACENT PERPENDICULAR WALL, U.O.N. ALIGNMENT:
WHERE NEW PARTITIONS ARE TO ALIGN WITH EXISTING PARTITIONS, REMOVE EXISTING CORNER BEAD(S), ALIGN, TAPE, AND carrierjohnson SPACKLE WITH NEW PARTITION. WALL BACKING:
BLOCKING OR BACKING SHALL BE PROVIDED IN PARTITIONS AS REQUIRED FOR WALL ATTACHED ITEMS. PROVIDE 6" HIGH, 16 GA. BACKING FOR CABINETRY, SHELVING, MARKER BOARDS, CHAIR RAILS, GRAB BARS, SHOWER SEATS, HANDRAILS, FIXTURES, EQUIPMENT, FURNISHINGS AND OTHER ITEMS AS REQUIRED. ALL WOOD BLOCKING, GROUNDS, ROUGH BUCKS AND MISCELLANEOUS BLOCKING SHALL BE FIRE RETARDANT TREATED IN ACCORDANCE WITH FIRE CODES. PENETRATION FIRESTOP SYSTEM INSTALLED AS TESTED IN ACCORDANCE WITH CBC STANDARD 7-5 AND SHALL HAVE AN F RATING (AND A T RATING AT FLOORS ONLY) OF NOT LESS THAN THE REQUIRED RATING OF THE WALL OR FLOOR PENETRATED. PENETRATIONS OF ACOUSTICAL WALLS FOR PIPES, DUCTS, AND OUTLETS SHALL BE SEALED WITH AN ACOUSTICAL SEALANT. WALL ACCESS PANELS:
PROVIDE ACCESS PANELS AS REQUIRED PER APPLICABLE CODES FOR MAINTENANCE ACCESS TO INSTALLED MEP EQUIPMENT. PROVIDE STAINLESS STEEL AT CERAMIC TILE LOCATIONS. COORDINATE TYPES AND LOCATIONS OF WALL ACCESS PANELS WITH CJ RETURN AIR WALL OPENINGS:
PROVIDE RETURN AIR WALL OPENINGS ABOVE CEILINGS AS PER MECHANICAL DRAWINGS. REFER TO MECHANICAL DRAWINGS FOR _SOUND BOOTS AT ACOUSTICAL WALL LOCATIONS AND FIRE/SMOKE DAMPERS AT ALL FIRE-RATED WALLS. FLOOR PLAN KEYNOTES SHEAR WALL PER STRUCTURE PLANS MEP SHAFT, SEE MEP DRAWINGS STRUCTURAL COLUMN, SEE STRUCTURAL DRAWINGS BALCONY PARTITION (5) WATER METER 6 METAL PANEL **DECK BELOW** (8) SLIDING DOOR 9 GYM RUBBER FLOOR SYSTEM AT WEIGHT LIFTING AREA (10) GUARD RAIL (11) ROLLED CURB S SECURITY GATE (13) BIKE KITCHEN 12 93 13 14 STAIR GATE 15 LOW-LEVEL EXIT SIGNS IN THE INTERIOR RESIDENTIAL CORRIDOR 02/20/2020 | IFC 2.0 02/03/2020 ASI 024.3 16 MECH. LOUVER, SEE ELEVATION 08 91 19 | 12/18/2019 | ASI 024.2 1/14/2019 ASI 024.1 17 PARKING ENTRY STATION FLOOR PLAN LEGEND 07/26/2019 Full Permit Resubmittal **ROOM NUMBER** 150 SF DOOR NUMBER SEE A9.00 A9.01 06/7/2019 Full Permit Resubmittal **SEE A.91** WINDOW NUMBER BALCONY RAILING TYPE 03/09/2019 LBFD WALL TYPE SEE A8.10 FIRE EXTINGUISHER/CABINET LOCATION

FEC #1 = 2A:10-B:C, SEMI-RECESSED

FEC #2 = 2A:10-B:C, SEMI-RECESSED, FIRE-RATED

FEC #3 = 4A:60BC, SEMI-RECESSED, OUTSIDE MECH., ELEC., BOILER ROOMS

01/24/2019 2ND BUILDING SUB. AED CABINET)1/14/2019 │ASI-005/ VE TIER 2 11/21/2018 | ASI-003 FLOOR DRAIN W/ 1/2" MAX. OPENINGS SEE PLUMBING DWGS. 11/07/2018 FOUNDATION ONLY FIRE SPRINKLER RISER SEE PLUMBING DWGS. 04/20/2018 | 1ST CITY SUBMITTA 04/03/2018 | ADDENDUM A DRINKING FOUNTAIN /ELECTRIC WATER COOLER SEE PLUMBING DWGS. 03/12/2018 | 75% BID SET 02/21/2018 | 50% CD SUBMITTAL 30" x 48" CLEAR WHEELCHAIR SPACE 10/16/20 | 100% DD SUBMITTAL 08/10/2017 | 50% DD SUBMITTAL INDICATES FULLY ACCESSIBLE UNIT PER CHAPTER 11B **ROOF DRAINS** STAND PIPE OPERABLE AWANING WINDOW EXTERIOR GLAZING STC RATINGS-WALL TYPE LEGEND RESIDENTIAL FLOOR STC RATING DETAIL NR/A8.10 PROJECT NO: NON-RATED WALL - 3 5/8" STUD 5727.00 NR/A8.10 ZONE-A 17-25 STC=36 NON-RATED WALL - 6" STUD FILE NAME: WRITE CENTRAL FILE PATH HERE:
(I.E. P:\0000.000\BIM\Central File\0000.00-central.rvt) 1 HOUR DEMISING WALL, (2) 6" STUD DM/A8.10 26-35 STC=33 1 HOUR CORRIDOR WALL-3 5/8" STUD FC/A8.10 DRAWN BY: CHECKED BY: 1-16 STC=33 1 HOUR WALL - 3 5/8" STUD LAN FR/A8.10 ZONE-B 17-25 STC=36 1 HOUR WALL - 3 5/8" STUD 2 HOUR WALL - 3 5/8" STUD FR/A8.10 FR-3 26-35 STC=33 2 HOUR WALL - 6" STUD FR/A8.10 1-9 STC=36 TITLE: 1 HOUR WALL - 6" STUD 10-25 STC=33 2 HOUR SHAFT WALL - 2 1/2" STUD SH/A8.10 2 HOUR SHAFT WALL - 3 5/8" STUD SH/A8.10 26-35 STC=31 LEVEL 4-7 & 9-13 CY TYP. FLOOR PLAN 2 HOUR SHAFT WALL - 6" STUD SH/A8.10 EXTERIOR GLAZING STC RATINGS-NON-FW-1 FURRED WALL - 2 1/2" STUD FW/A8.10 RESIDENTIAL FURRED WALL - 3 5/8" STUD FW/A8.10 FLOOR STC RATING LOCATION FURRED WALL - 6" STUD FW/A8.10 -CM/A8.11 ZONE-A 1 STC=33 NON-RATED 8" CMU WALL

CM/A8.11 | ZONE-B & C | 1-3 | STC=31

OTHER NON-RES. AREAS NOT REQUIRED

DRAWING NO:

A2.04

CM/A8.11

CO/A8.11

CO/A8.11

CO/A8.11

CO/A8.11

1 HOUR 8" CMU WALL

2 HOUR 8" CMU WALL


8" CONCRETE WALL


18" CONCRETE WALL


22" CONCRETE WALL


30" CONCRETE WALL

36 CONCRETE WALL

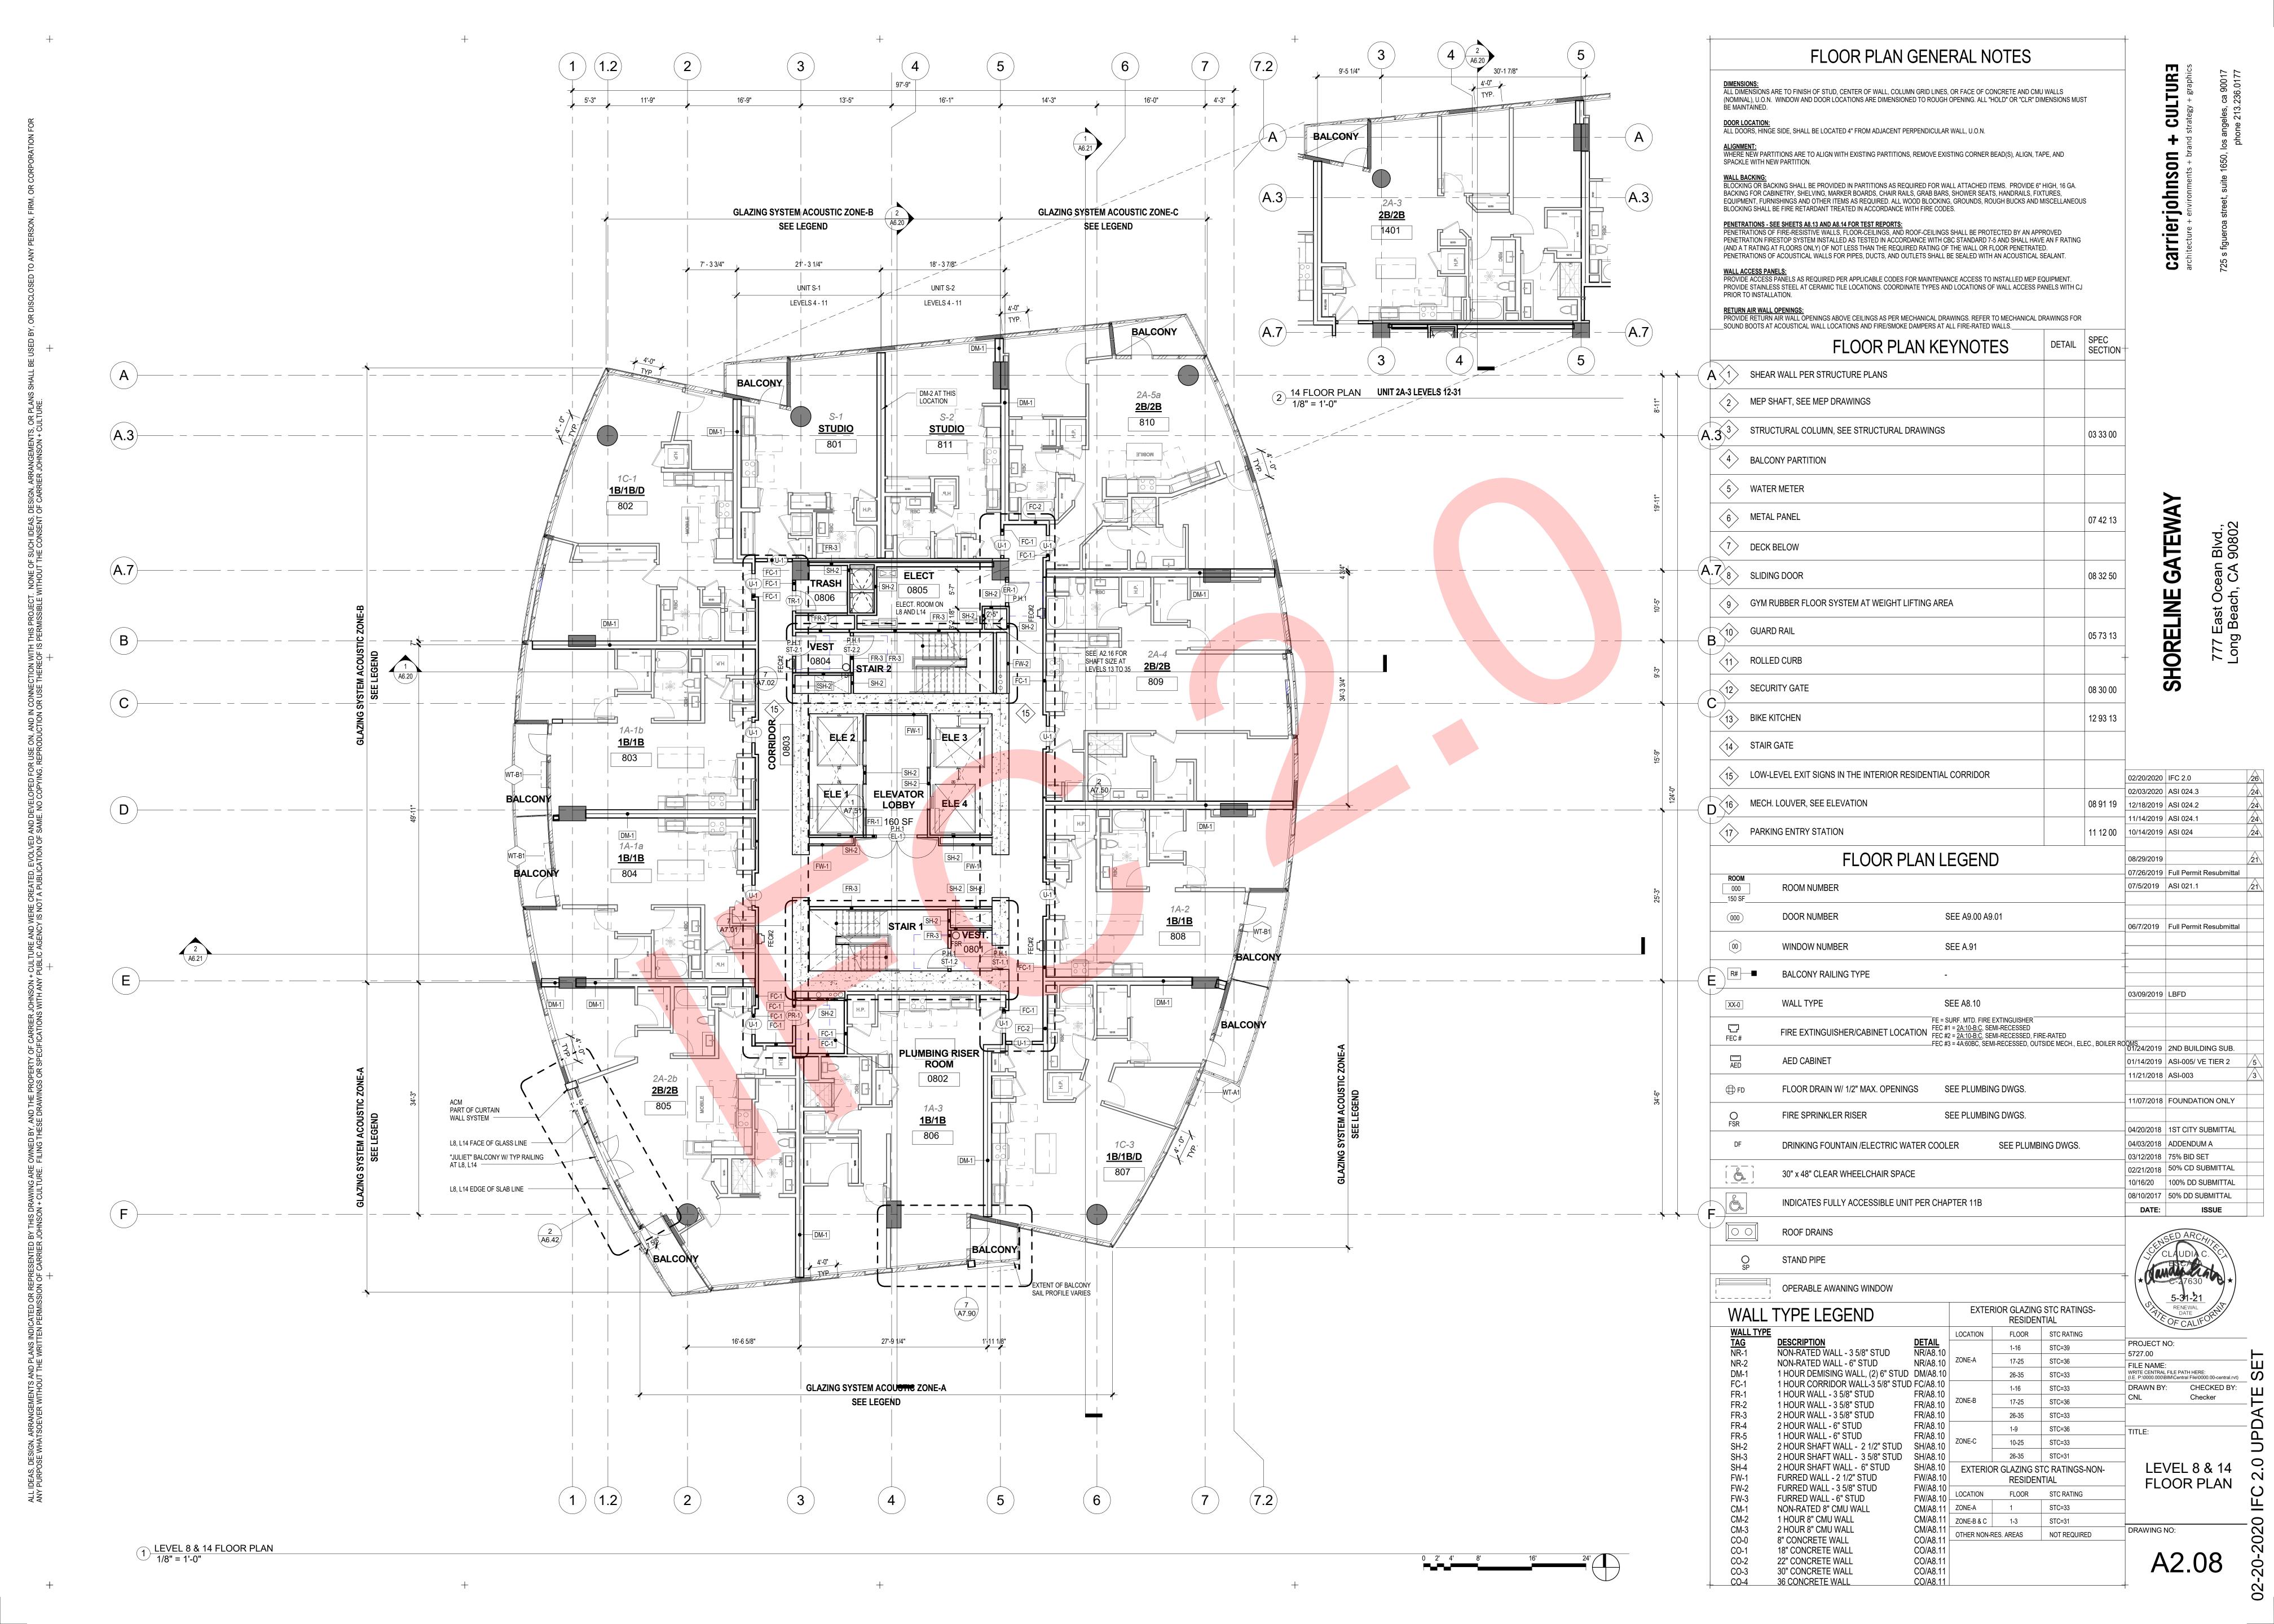

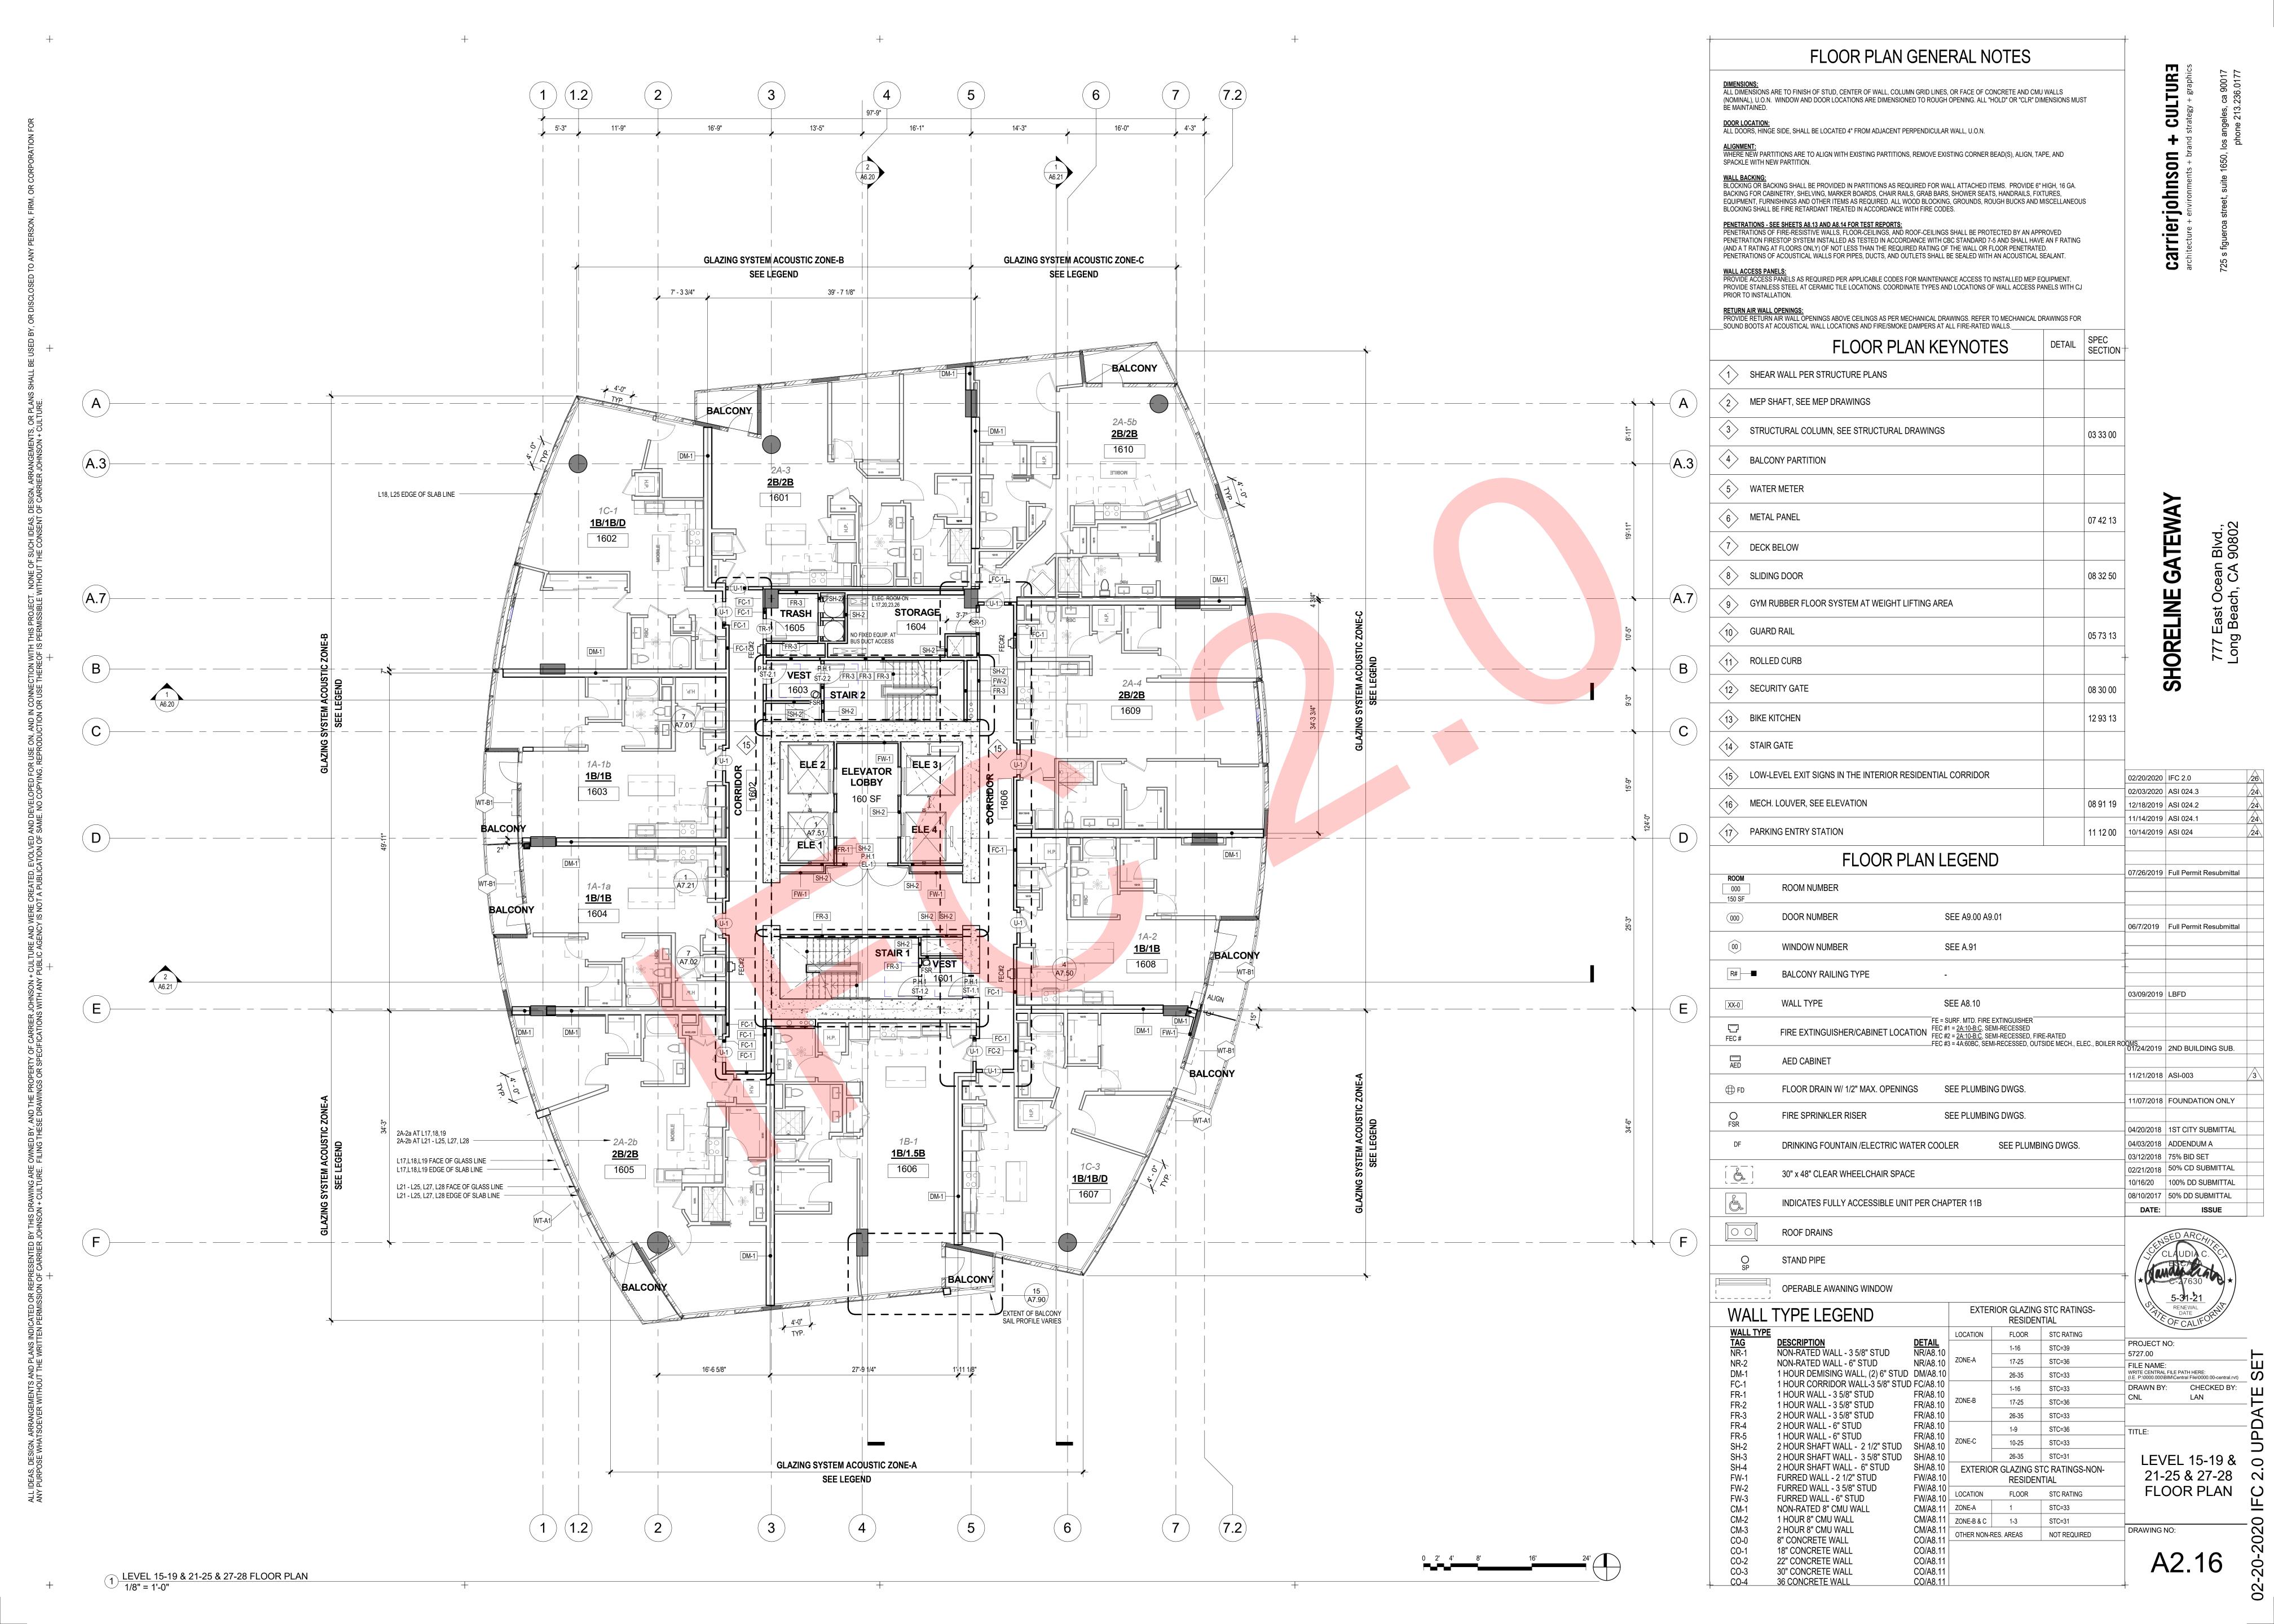

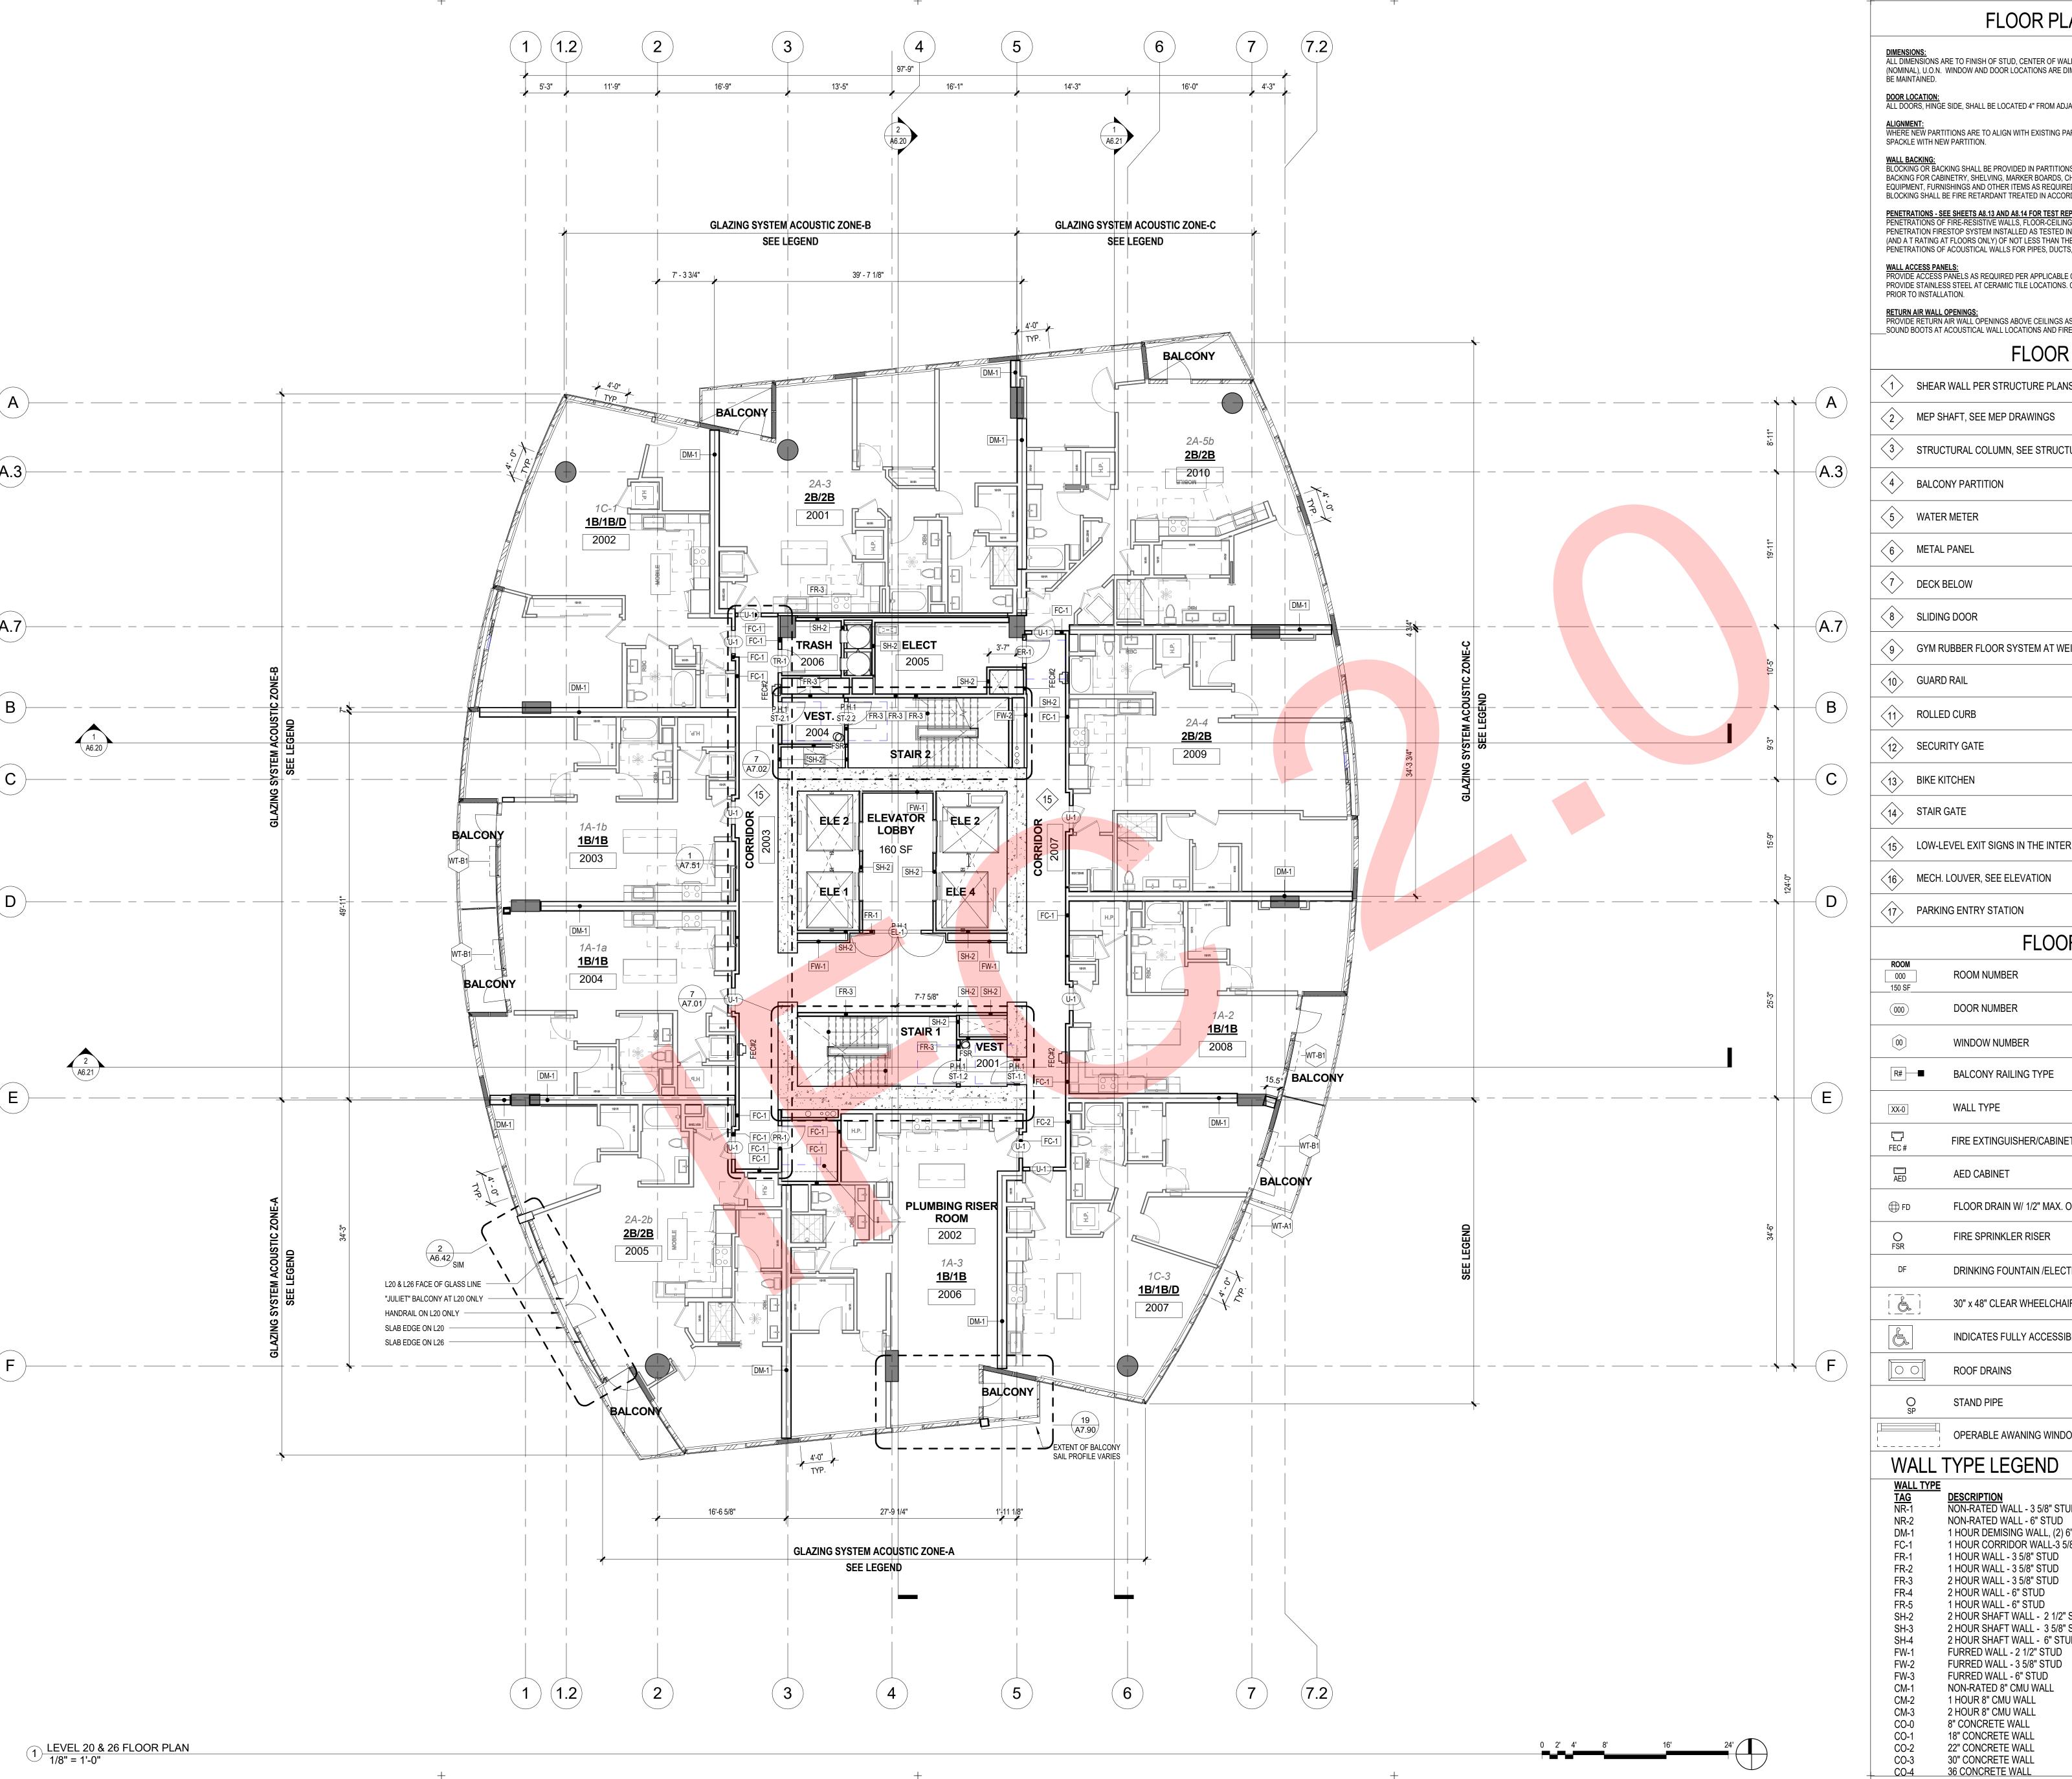

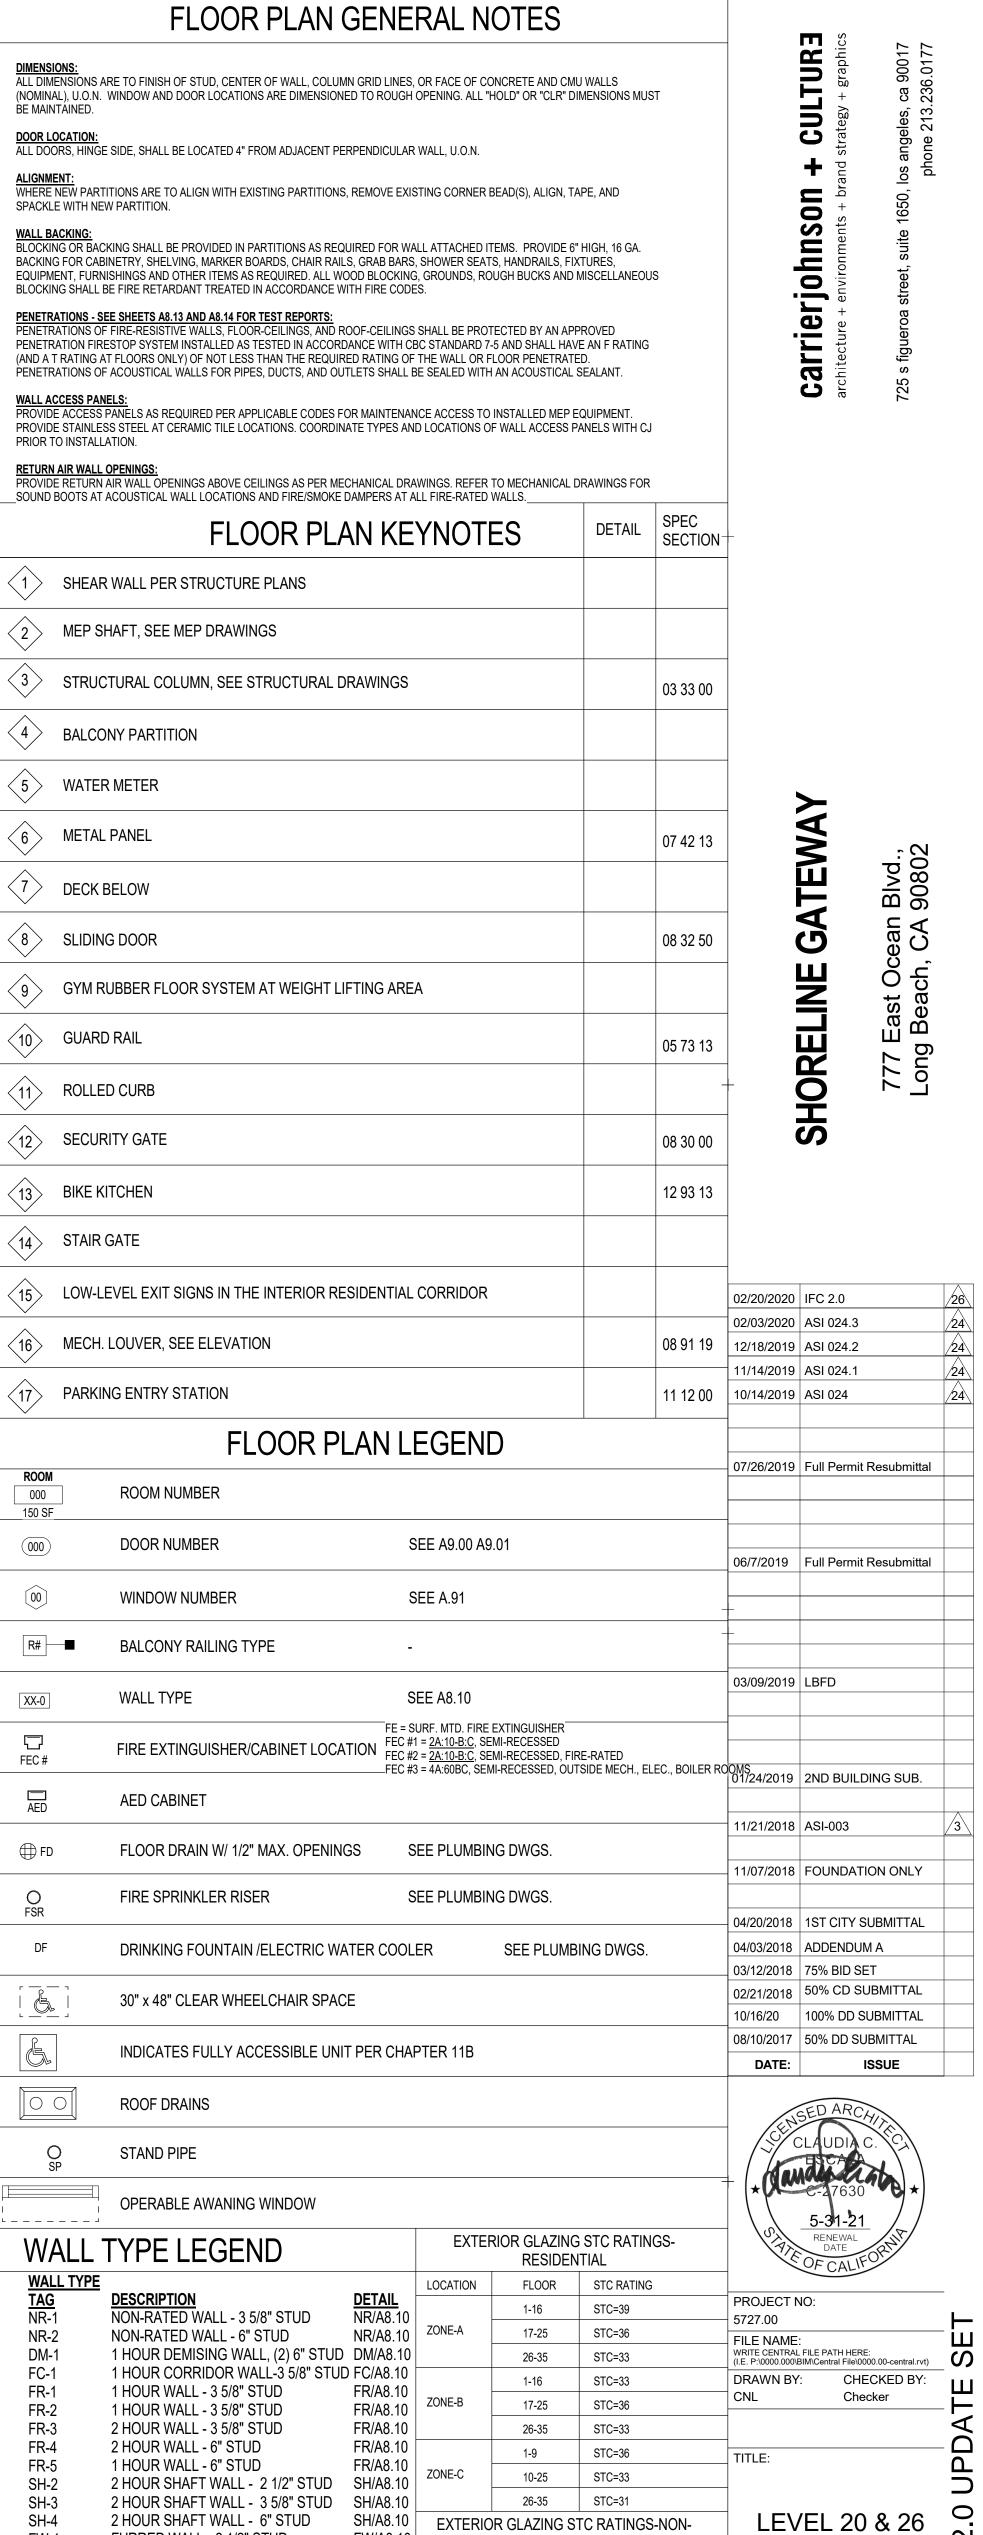

FW/A8.10

FW/A8.10

FW/A8.10 -

CO/A8.11

CO/A8.11

CO/A8.11 CO/A8.11 LOCATION

CM/A8.11 ZONE-A 1 STC=33

CM/A8.11 ZONE-B & C 1-3 STC=31

RESIDENTIAL


OTHER NON-RES. AREAS NOT REQUIRED


FLOOR STC RATING

FLOOR PLAN

A2.20

DRAWING NO:

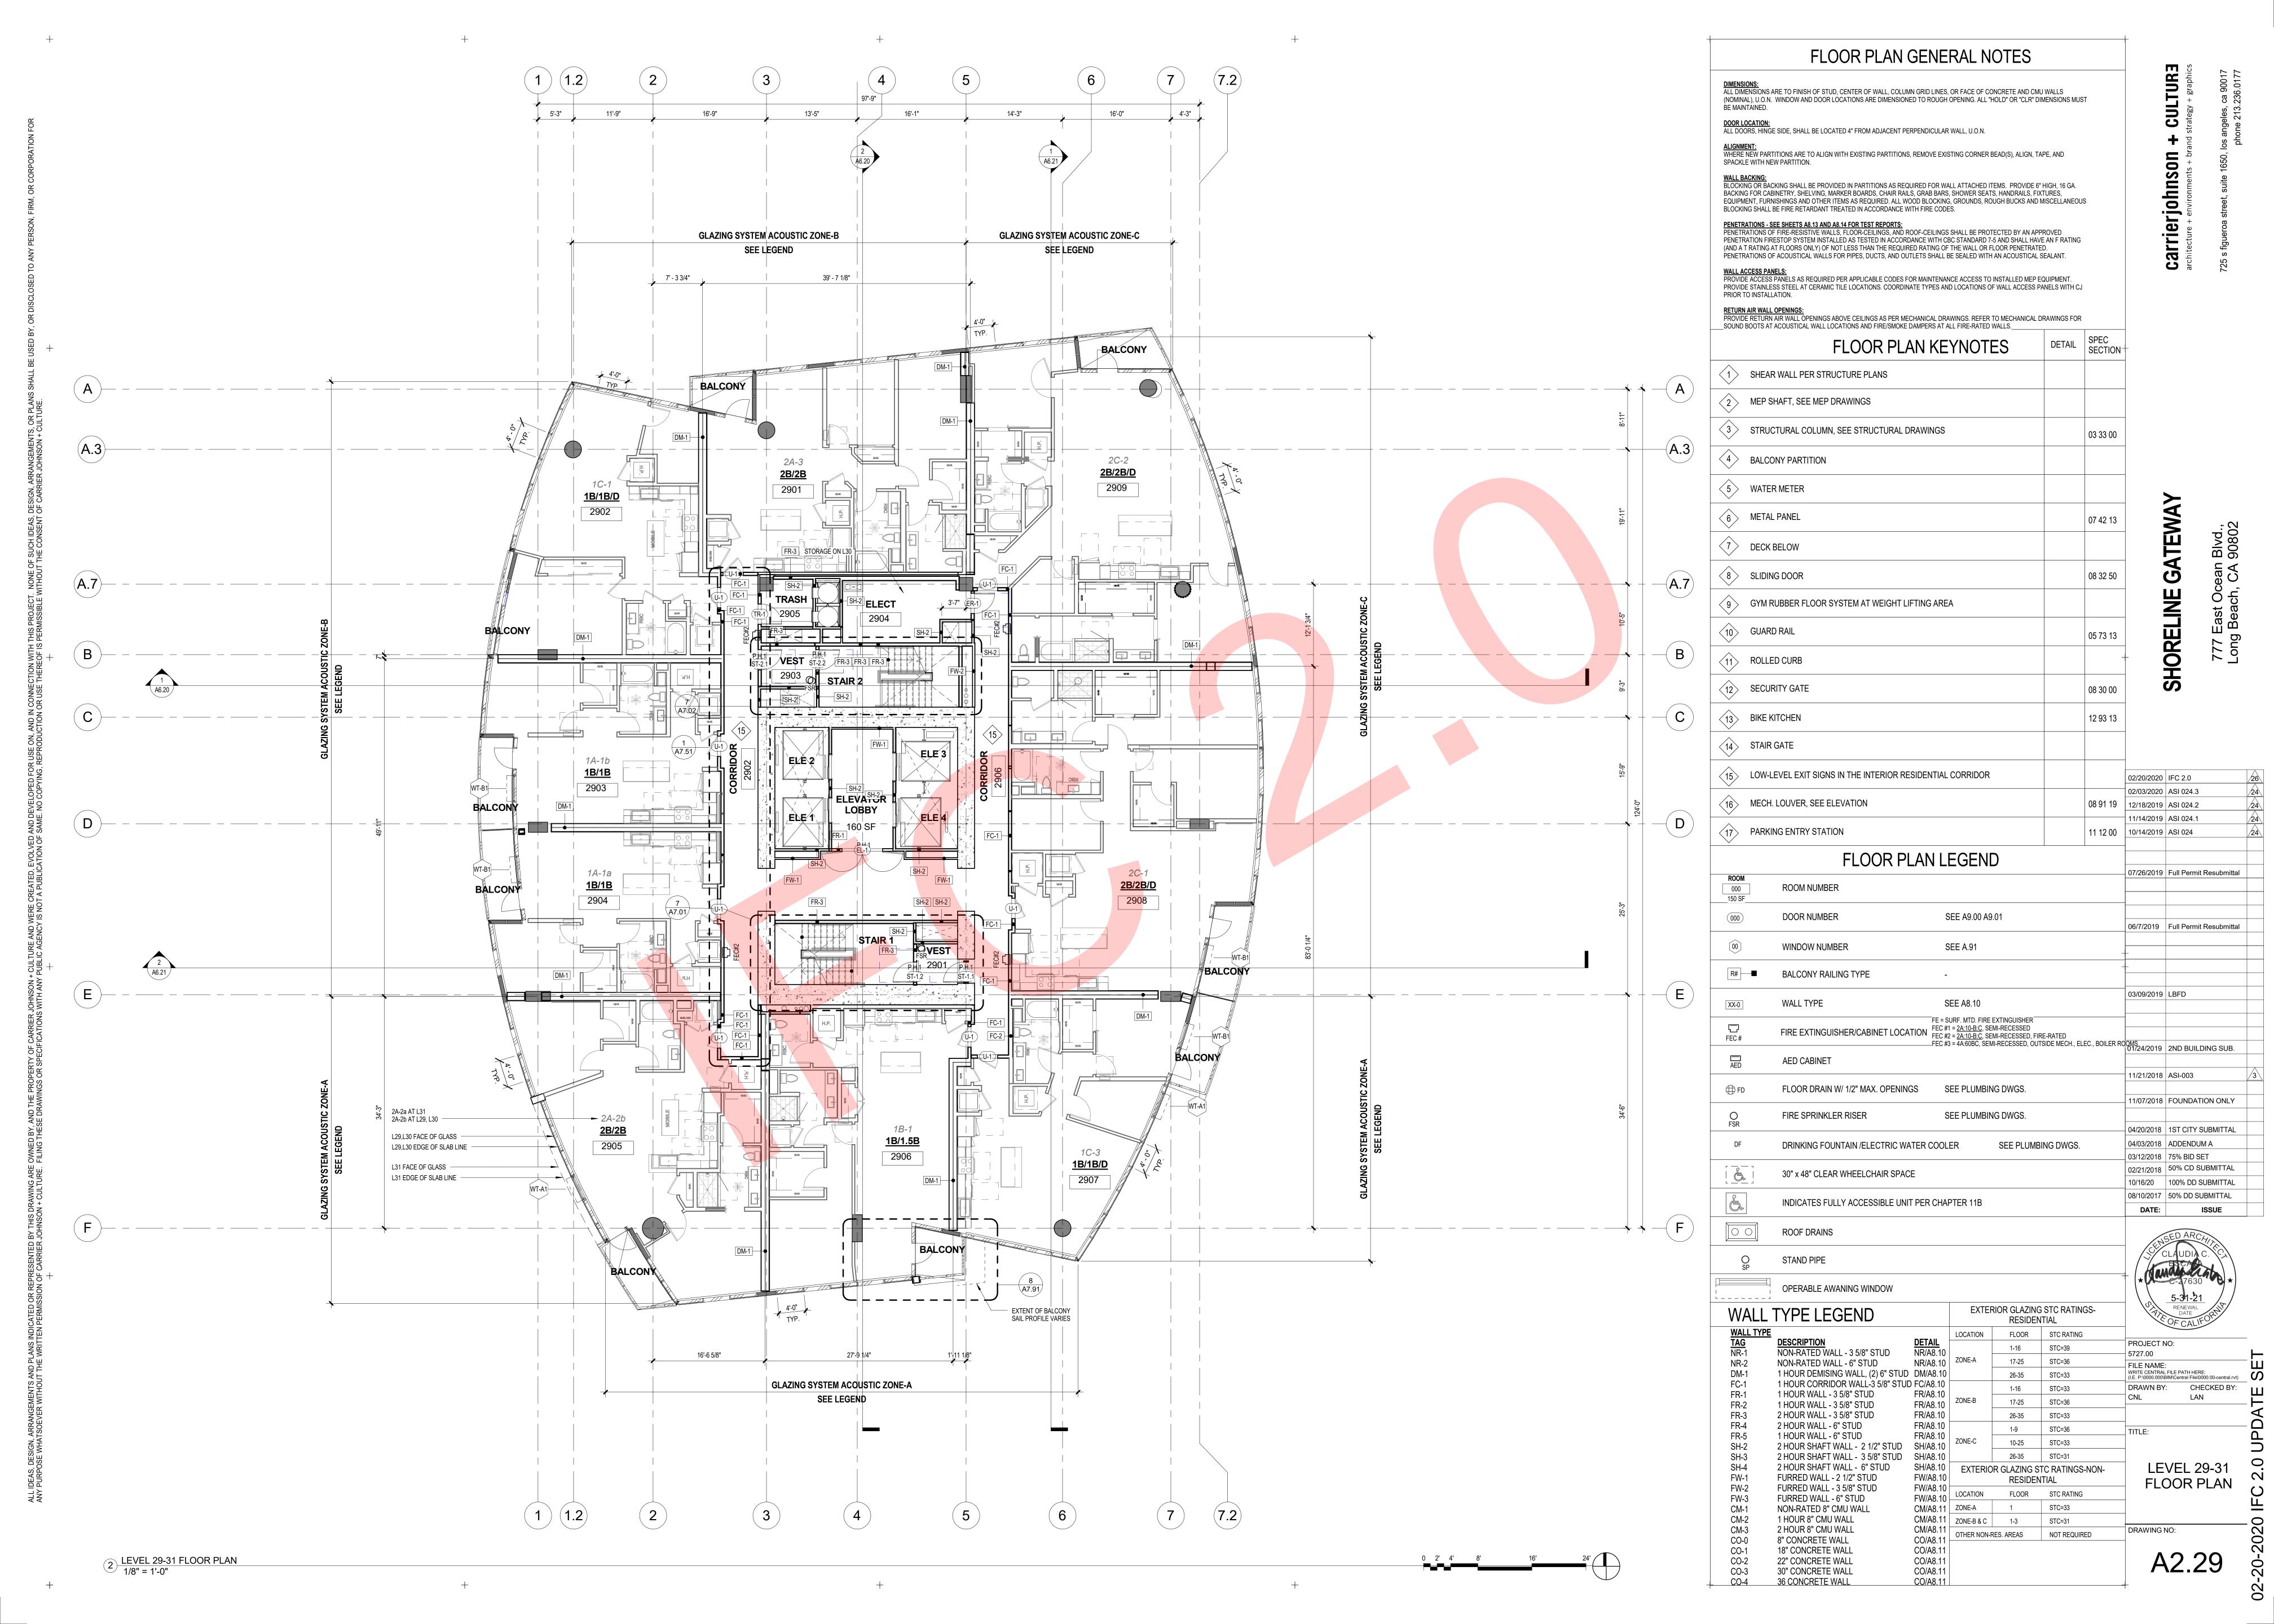

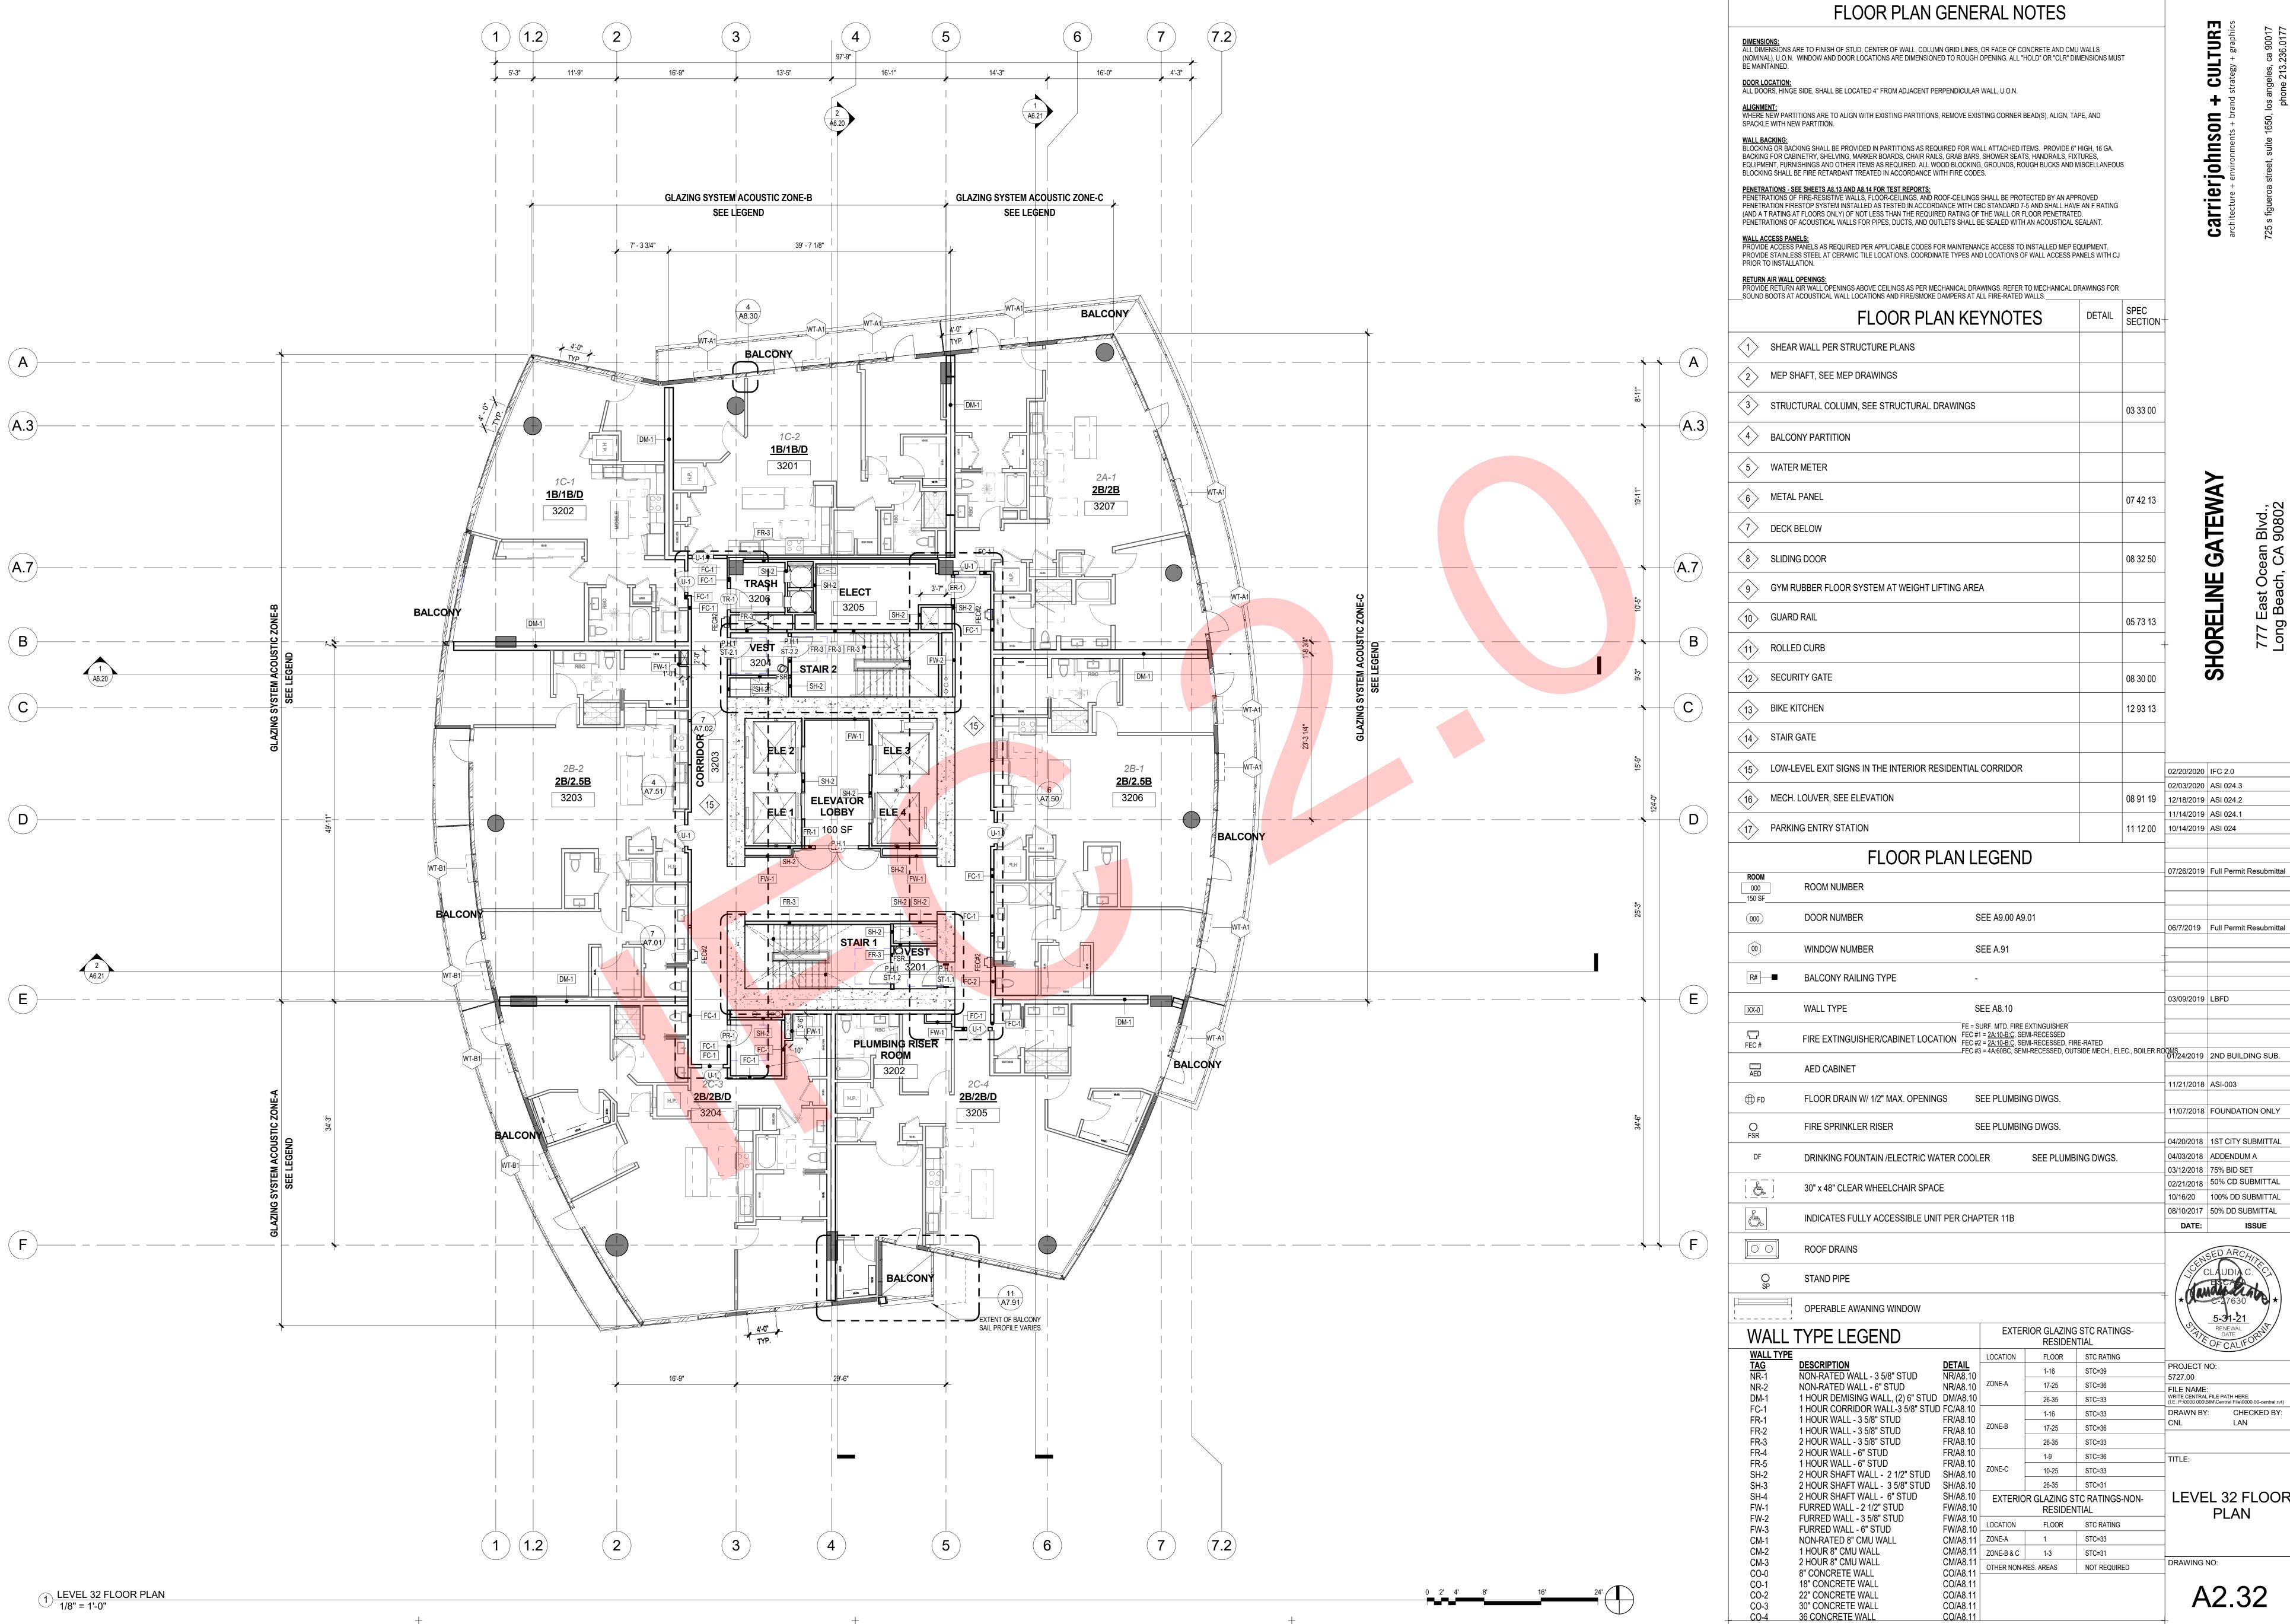

carrierjohnson

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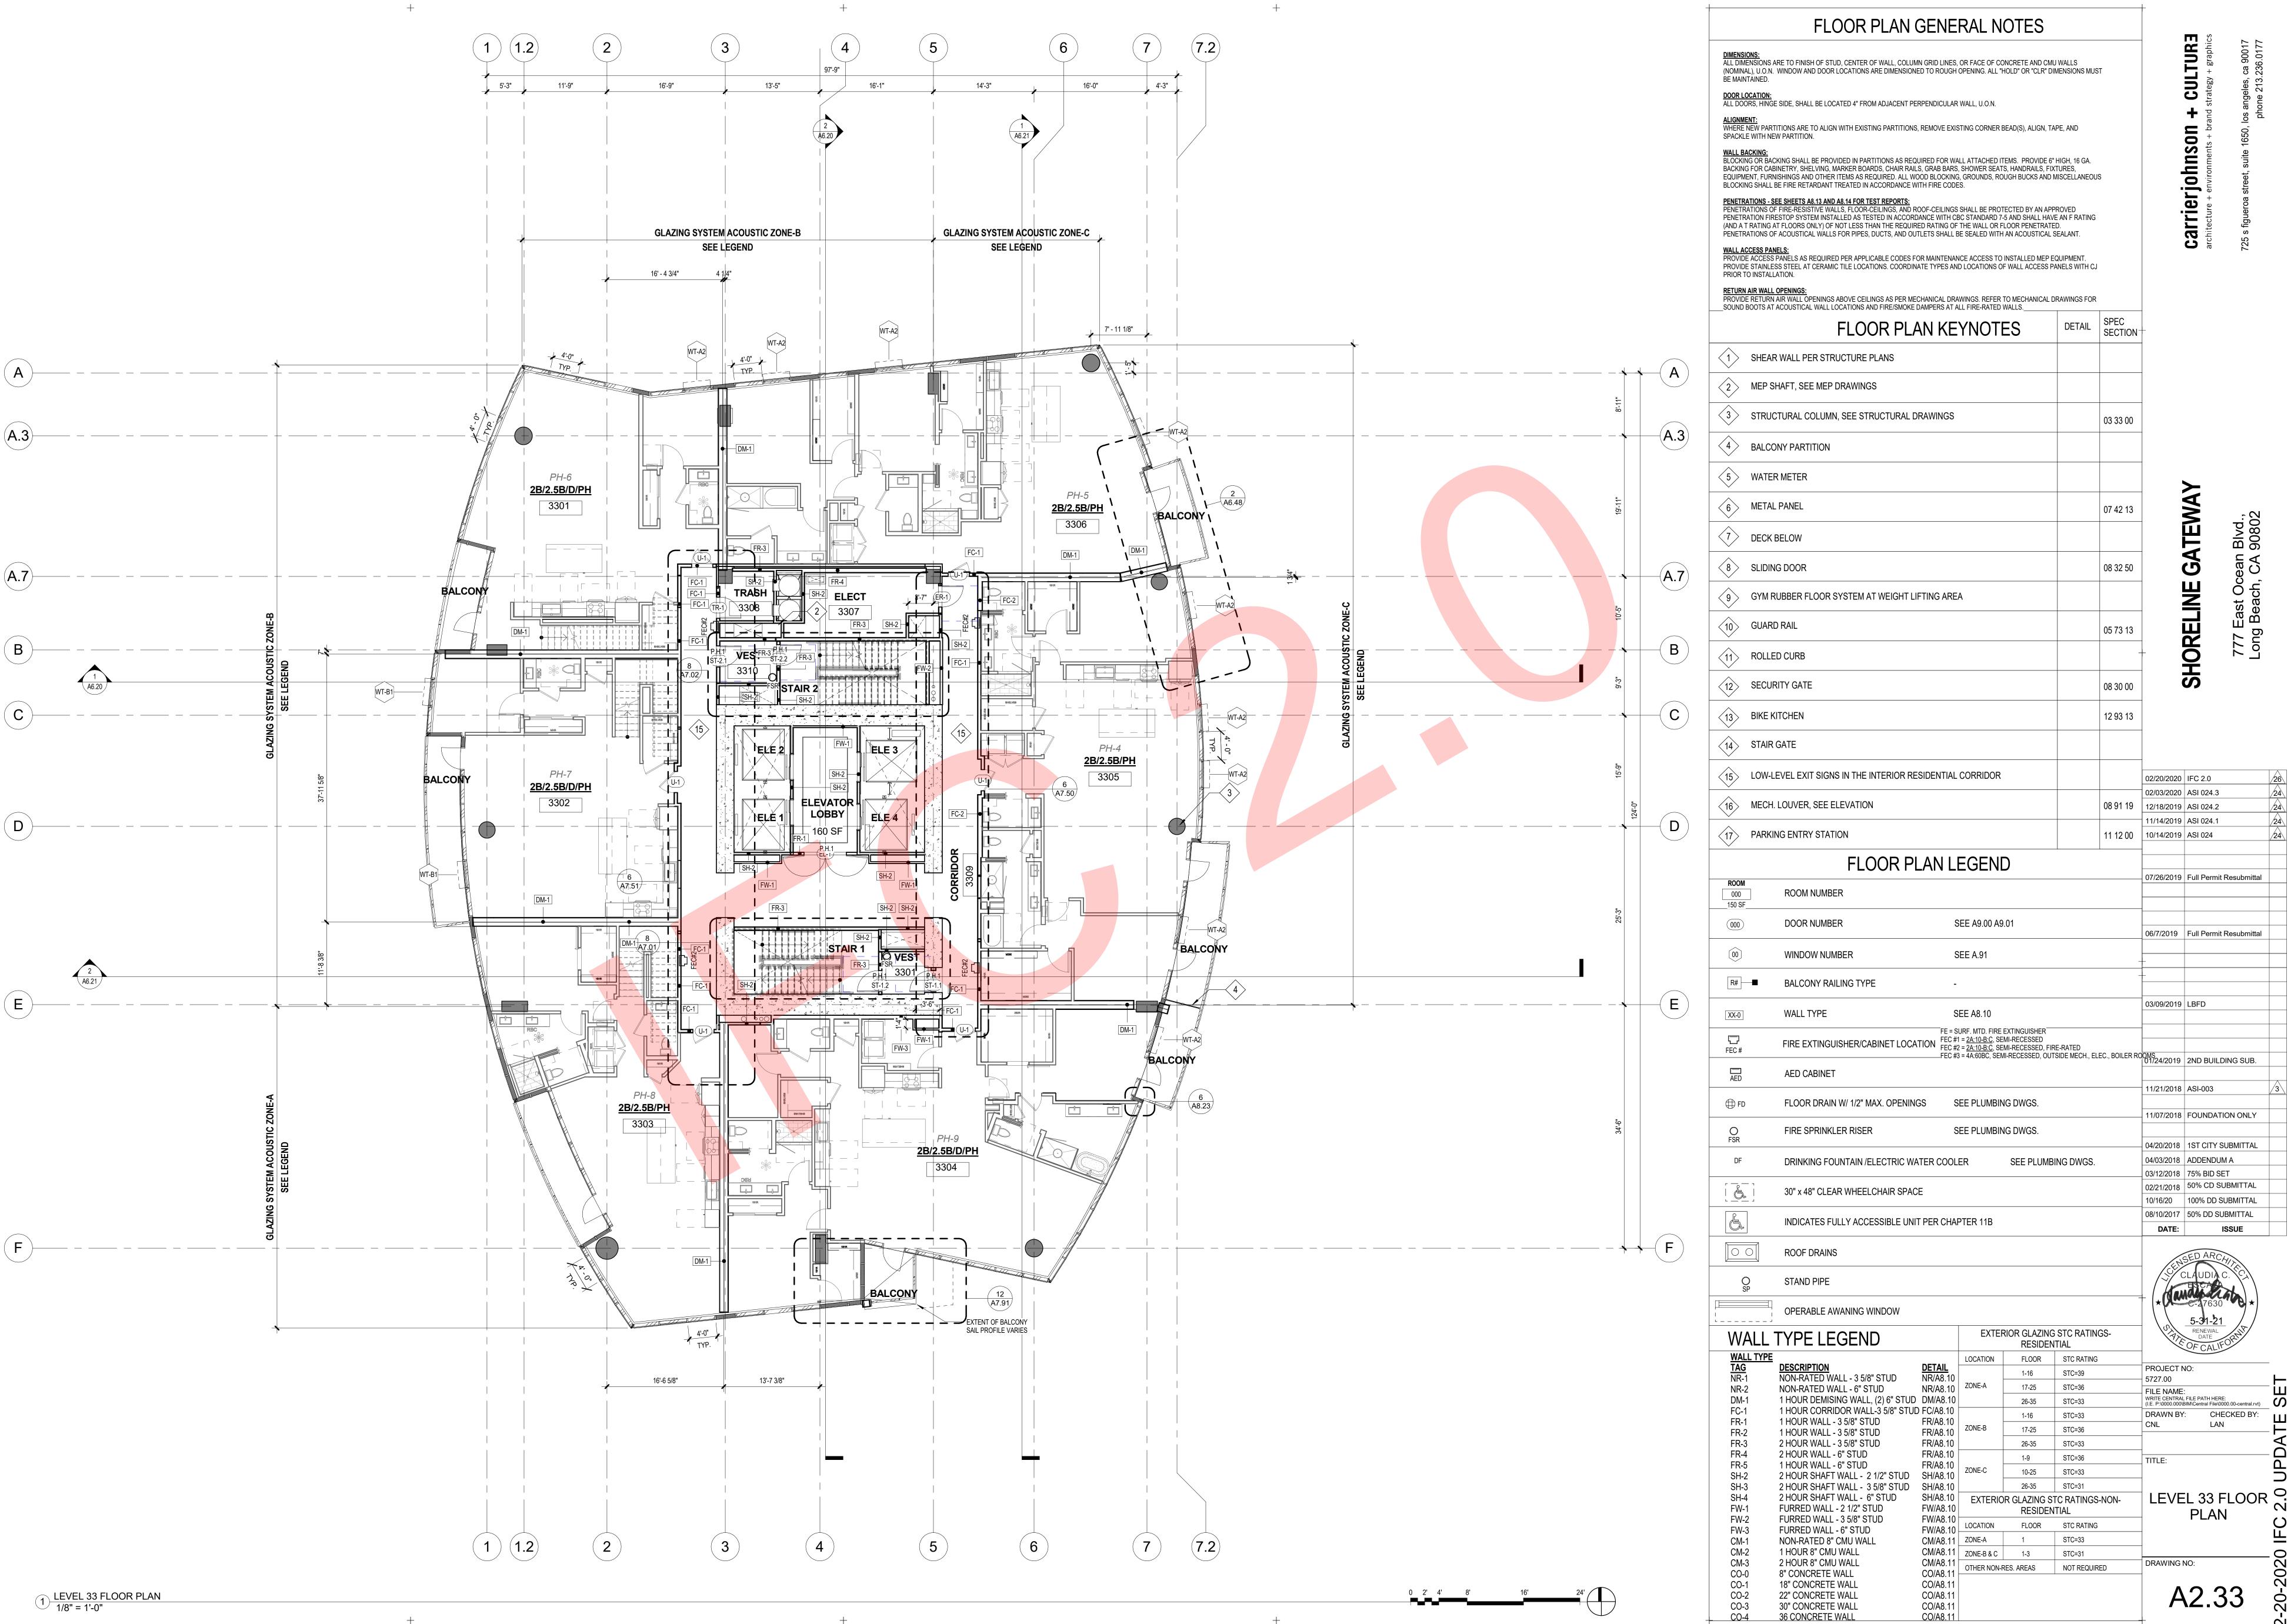
1/14/2019 ASI 024.1 07/26/2019 Full Permit Resubmittal 06/7/2019 Full Permit Resubmittal

04/20/2018 | 1ST CITY SUBMITTA 04/03/2018 | ADDENDUM A 03/12/2018 | 75% BID SET 02/21/2018 \mid 50% CD SUBMITTAL 10/16/20 | 100% DD SUBMITTAL 08/10/2017 | 50% DD SUBMITTAL

PROJECT NO: 5727.00 FILE NAME: WRITE CENTRAL FILE PATH HERE:
(I.E. P:\0000.000\BIM\Central File\0000.00-central.rvt) DRAWN BY: CHECKED BY: LAN

LEVEL 32 FLOOR O

DRAWING NO: A2.32



10/16/20 | 100% DD SUBMITTAL 08/10/2017 | 50% DD SUBMITTAL

LAN

1 LEVEL 34 FLOOR PLAN 1/8" = 1'-0"

FLOOR PLAN GENERAL NOTES

+ CENSED ARCHITCH CLAUDIA C. CLAU

carrierjohnson

S

02/20/2020 IFC 2.0

07/26/2019 Full Permit Resubmittal

06/7/2019 Full Permit Resubmittal

02/07/2019 | ASI-011/ VE TIER 3

01/24/2019 2ND BUILDING SUB

11/07/2018 FOUNDATION ONLY

04/20/2018 | 1ST CITY SUBMITTA

02/21/2018 | 50% CD SUBMITTAL

10/16/20 | 100% DD SUBMITTAL

04/03/2018 | ADDENDUM A

03/12/2018 | 75% BID SET

03/09/2019 LBFD

11/21/2018 | ASI-003

PROJECT NO: 5727.00 FILE NAME:

TITLE:


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(I.E. P:\0000.000\BIM\Central File\0000.00-central.rvt)

DRAWN BY: CHECKED BY:
CNL LAN

LEVEL 34 FLOOI

DRAWING NO:

12.34

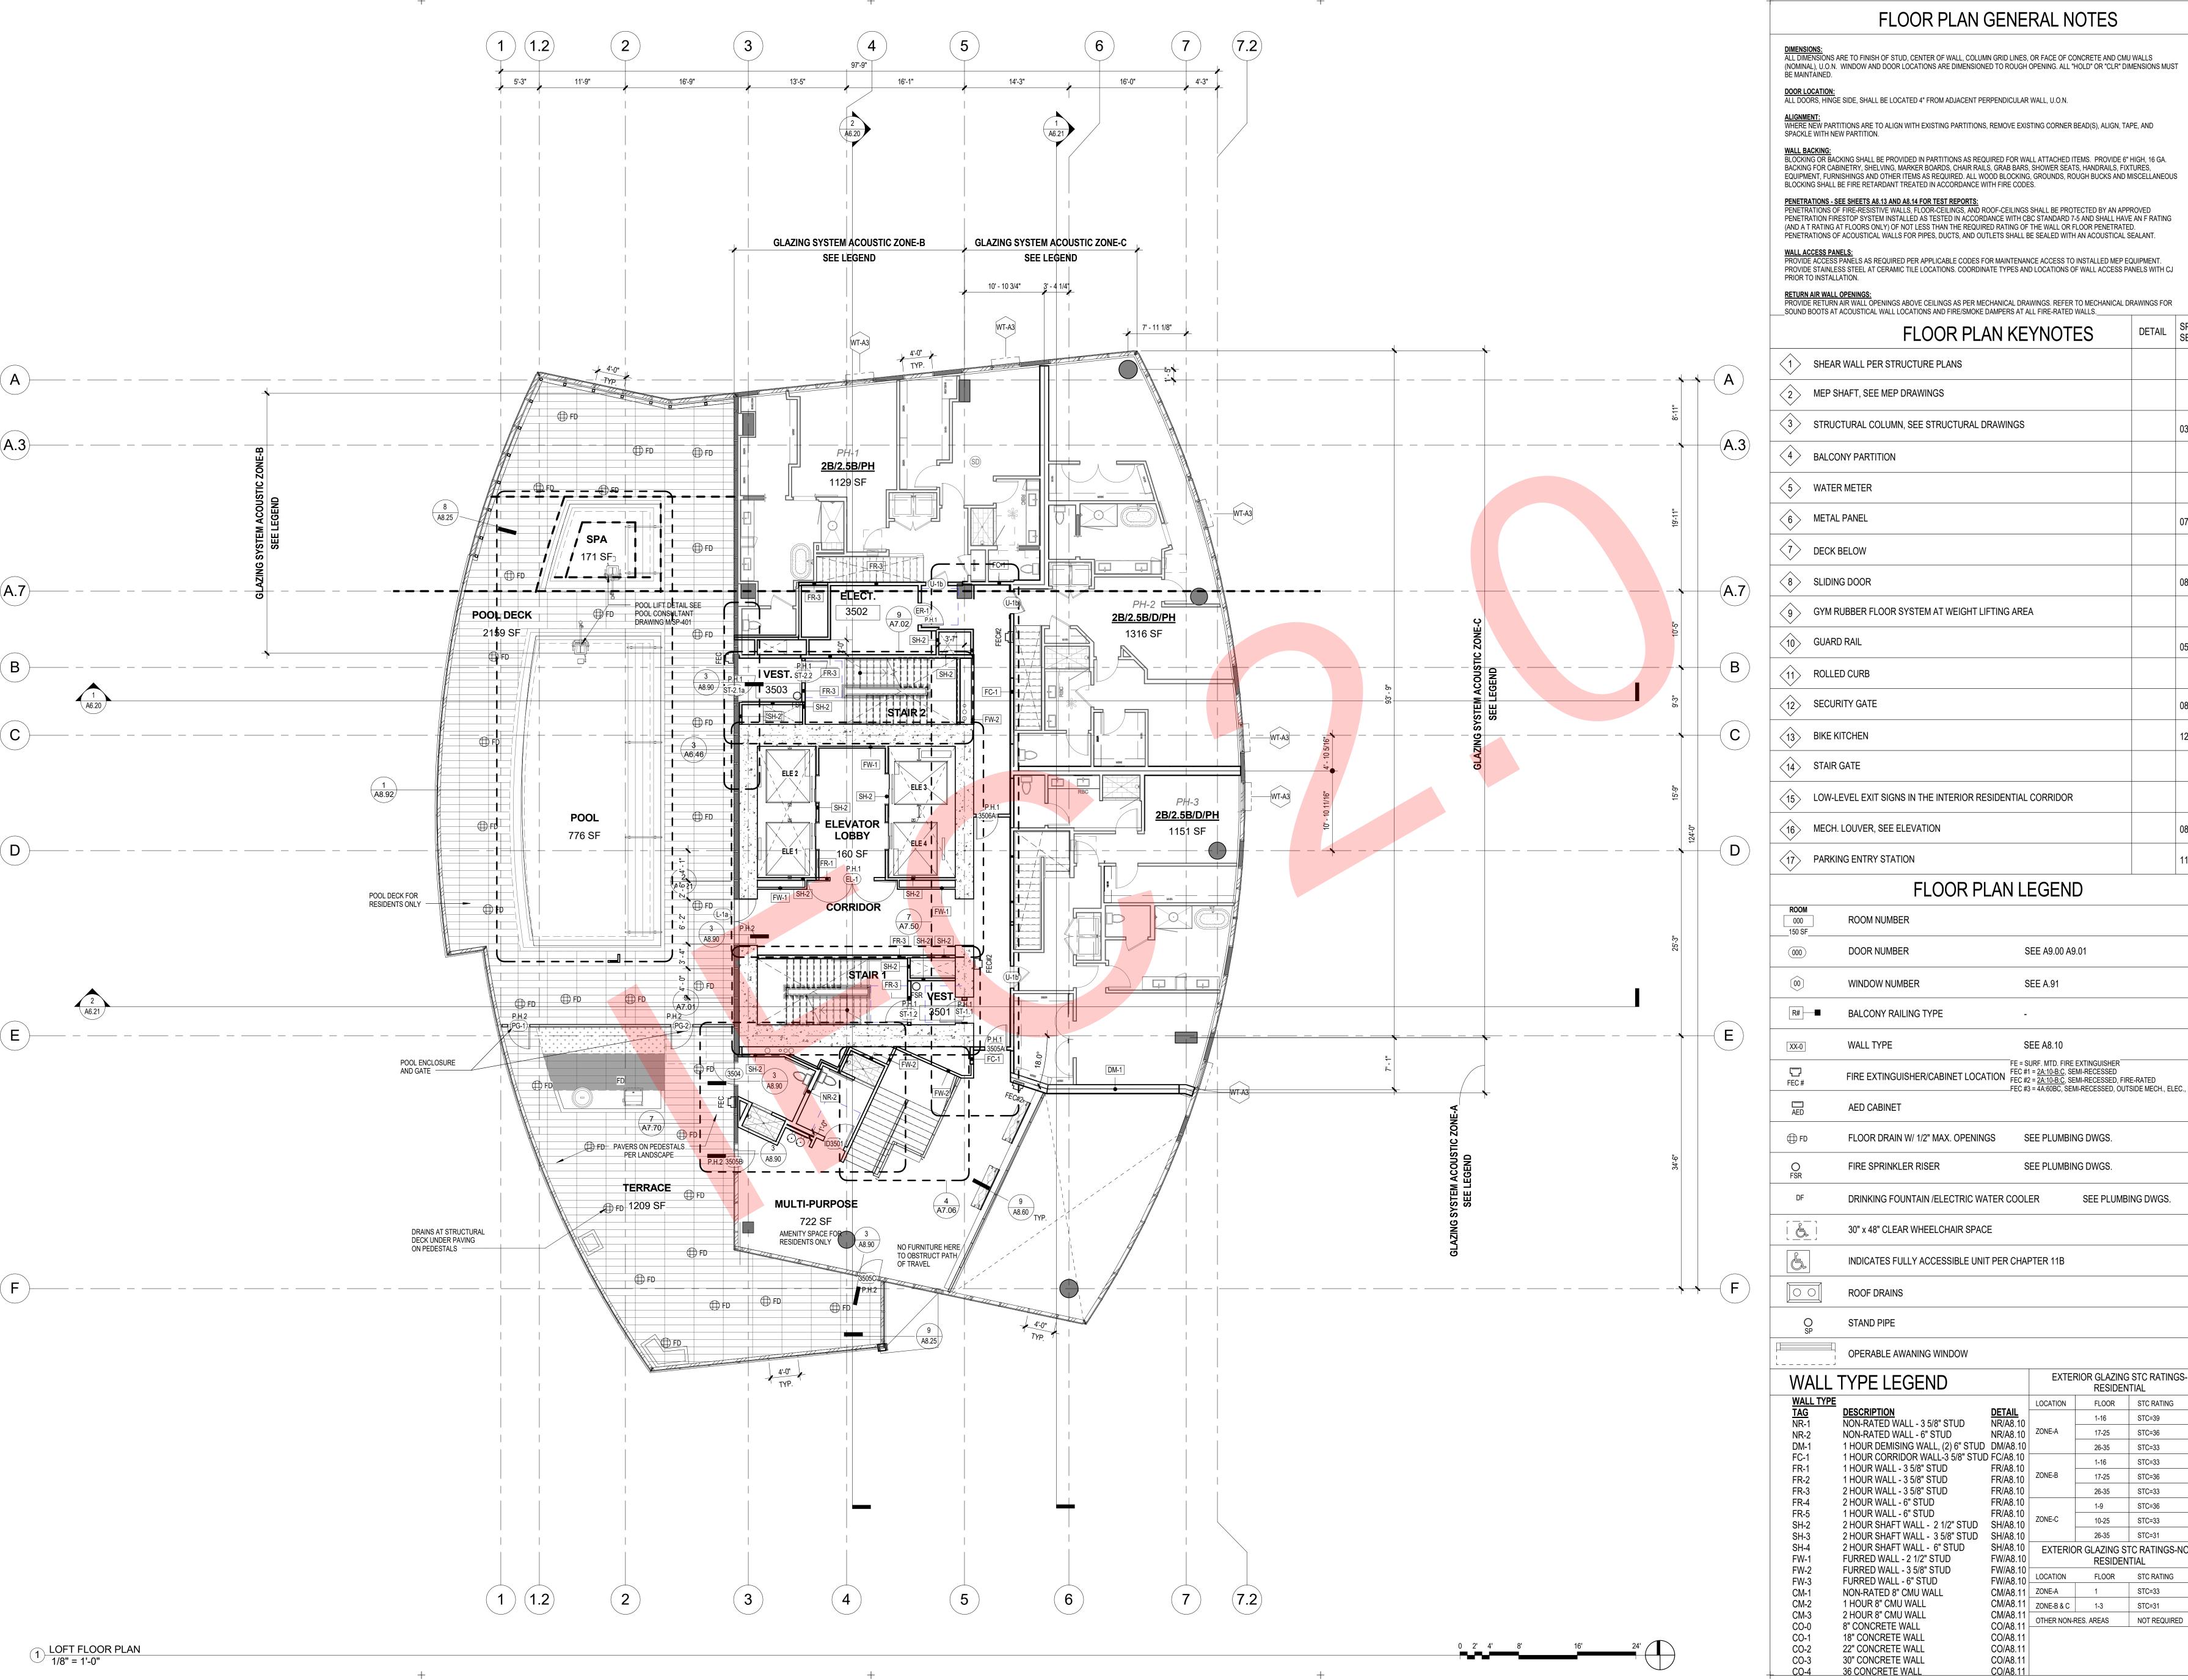

<u>DIMENSIONS:</u>
ALL DIMENSIONS ARE TO FINISH OF STUD, CENTER OF WALL, COLUMN GRID LINES, OR FACE OF CONCRETE AND CMU WALLS
(NOMINAL), U.O.N. WINDOW AND DOOR LOCATIONS ARE DIMENSIONED TO ROUGH OPENING. ALL "HOLD" OR "CLR" DIMENSIONS MUST carrierjohnson

ALIGNMENT:
WHERE NEW PARTITIONS ARE TO ALIGN WITH EXISTING PARTITIONS, REMOVE EXISTING CORNER BEAD(S), ALIGN, TAPE, AND SPACKLE WITH NEW PARTITION.

PENETRATIONS OF ACOUSTICAL WALLS FOR PIPES, DUCTS, AND OUTLETS SHALL BE SEALED WITH AN ACOUSTICAL SEALANT.

WALL ACCESS PANELS:
PROVIDE ACCESS PANELS AS REQUIRED PER APPLICABLE CODES FOR MAINTENANCE ACCESS TO INSTALLED MEP EQUIPMENT.
PROVIDE STAINLESS STEEL AT CERAMIC TILE LOCATIONS. COORDINATE TYPES AND LOCATIONS OF WALL ACCESS PANELS WITH CJ
PRIOR TO INSTALLATION.

RETURN AIR WALL OPENINGS:	
PROVIDE RETURN AIR WALL OPENINGS ABOVE CEILINGS AS PER MECHANICAL DRAWINGS. REFER TO MECHANICAL D	RAWINGS FOR
SOUND BOOTS AT ACOUSTICAL WALL LOCATIONS AND FIRE/SMOKE DAMPERS AT ALL FIRE-RATED WALLS	
	DETAIL

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07 42 13		
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		HORELINE GATEWAY
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05 73 13	j	KE
08 30 00		ダ
12 93 13		
	02/20/2020	IFC 2.0
08 91 19		
11 12 00		
	12 93 13 08 91 19	08 30 00 12 93 13 02/20/2020 08 91 19

	FLOOR PLAN L	EGEND		
ROOM 000 150 SF	ROOM NUMBER		07/26/2019	Full Permit Resubmittal
000	DOOR NUMBER S	SEE A9.00 A9.01	06/7/2019	Full Permit Resubmittal
00	WINDOW NUMBER	SEE A.91	-	T dil T Offiik T (CCGD) ilikai
R# ■	BALCONY RAILING TYPE -	_	-	
			03/09/2019	LBFD
XX-0	WALL TYPE S	SEE A8.10	02/07/2019	ASI-011/ VE TIER 3
FEC#	FIRE EXTINGUISHER/CABINET LOCATION FEC#	SURF. MTD. FIRE EXTINGUISHER 11 = <u>2A:10-B:C</u> , SEMI-RECESSED 12 = <u>2A:10-B:C</u> , SEMI-RECESSED, FIRE-RATED		
AED	AED CABINET	iz = <u>ZA:10-B:C</u> , SEMI-RECESSED, FIRE-RATED i3 = 4A:60BC, SEMI-RECESSED, OUTSIDE MECH., ELEC., BOILER RO	OMS 01/24/2019	2ND BUILDING SUB.
			11/21/2018	ASI-003
⊕ FD	FLOOR DRAIN W/ 1/2" MAX. OPENINGS	SEE PLUMBING DWGS.		
			11/07/2018	FOUNDATION ONLY
O FSR	FIRE SPRINKLER RISER	SEE PLUMBING DWGS.		
TOR			04/20/2018	1ST CITY SUBMITTAL
DF	DRINKING FOUNTAIN /ELECTRIC WATER COOL	ER SEE PLUMBING DWGS.	04/03/2018	ADDENDUM A
			03/12/2018	75% BID SET
	30" x 48" CLEAR WHEELCHAIR SPACE		02/21/2018	50% CD SUBMITTAL
			10/16/20 08/10/2017	100% DD SUBMITTAL 50% DD SUBMITTAL
E.	INDICATES FULLY ACCESSIBLE UNIT PER CHA	PTER 11B	DATE:	ISSUE
	ROOF DRAINS			SED ARCHITE
O SP	STAND PIPE			CLAUDIA C. C.


	OPERABLE AWANING WINDOW					
WALI	TYPE LEGEND		EXTER	RIOR GLAZING RESIDEN	STC RATINGS- TIAL	
WALL TY			LOCATION	FLOOR	STC RATING	
<u>TAG</u> NR-1	<u>DESCRIPTION</u> NON-RATED WALL - 3 5/8" STUD	DETAIL NR/A8.10		1-16	STC=39	
1417-1	NON-INTIED WALL - 0 0/0 OTOD	1111/70.10	ZONE A	47.05	070.00	

ALL	I THE LEGEND			RESIDEN	TIAL	\
ALL TYPE			LOCATION	FLOOR	STC RATING	
\G ⋜-1	DESCRIPTION	DETAIL		1-16	STC=39	PROJEC
	NON-RATED WALL - 3 5/8" STUD	NR/A8.10	ZONE-A			5727.00
₹-2	NON-RATED WALL - 6" STUD	NR/A8.10	ZUNE-A	17-25	STC=36	FILE NA
M-1	1 HOUR DEMISING WALL, (2) 6" STUD	DM/A8.10		26-35	STC=33	WRITE CEN (I.E. P:\0000
C-1	1 HOUR CORRIDOR WALL-3 5/8" STUD			1-16	STC=33	DRAWN
R-1	1 HOUR WALL - 3 5/8" STUD	FR/A8.10	ZONE-B		STC=36	CNL
R-2	1 HOUR WALL - 3 5/8" STUD	FR/A8.10	ZONE-D	17-25		
₹-3	2 HOUR WALL - 3 5/8" STUD	FR/A8.10		26-35	STC=33	
₹-4	2 HOUR WALL - 6" STUD	FR/A8.10		1-9	STC=36	TITLE:
₹-5	1 HOUR WALL - 6" STUD	FR/A8.10	ZONE-C	10-25	STC=33	
1 -2	2 HOUR SHAFT WALL - 2 1/2" STUD	SH/A8.10	20112 0			
1 -3	2 HOUR SHAFT WALL - 3 5/8" STUD	SH/A8.10		26-35	STC=31	
1 -4	2 HOUR SHAFT WALL - 6" STUD	SH/A8.10	EXTERIO	R GLAZING ST	C RATINGS-NON-	∣ LE\
N-1	FURRED WALL - 2 1/2" STUD	FW/A8.10		RESIDEN	TIAL	
N-2	FURRED WALL - 3 5/8" STUD	FW/A8.10	LOCATION	FLOOR	STC RATING	
N-3	FURRED WALL - 6" STUD	FW/A8.10		I LOOK		
M-1	NON-RATED 8" CMU WALL	CM/A8.11	ZONE-A	1	STC=33	
M-2	1 HOUR 8" CMU WALL	CM/A8.11	ZONE-B & C	1-3	STC=31	
M-3	2 HOUR 8" CMU WALL	CM/A8.11	OTHER NON-F	RES AREAS	NOT REQUIRED	DRAWI
O-0	8" CONCRETE WALL	CO/A8.11	OTTLICTION	NEO. AINEAO	NOTIVEQUIVED	-
O-1	18" CONCRETE WALL	CO/A8.11				
)-2	22" CONCRETE WALL	CO/A8.11				

WN BY: CHECKED BY: Checker

EVEL 35 FLOOR Si

A2.35

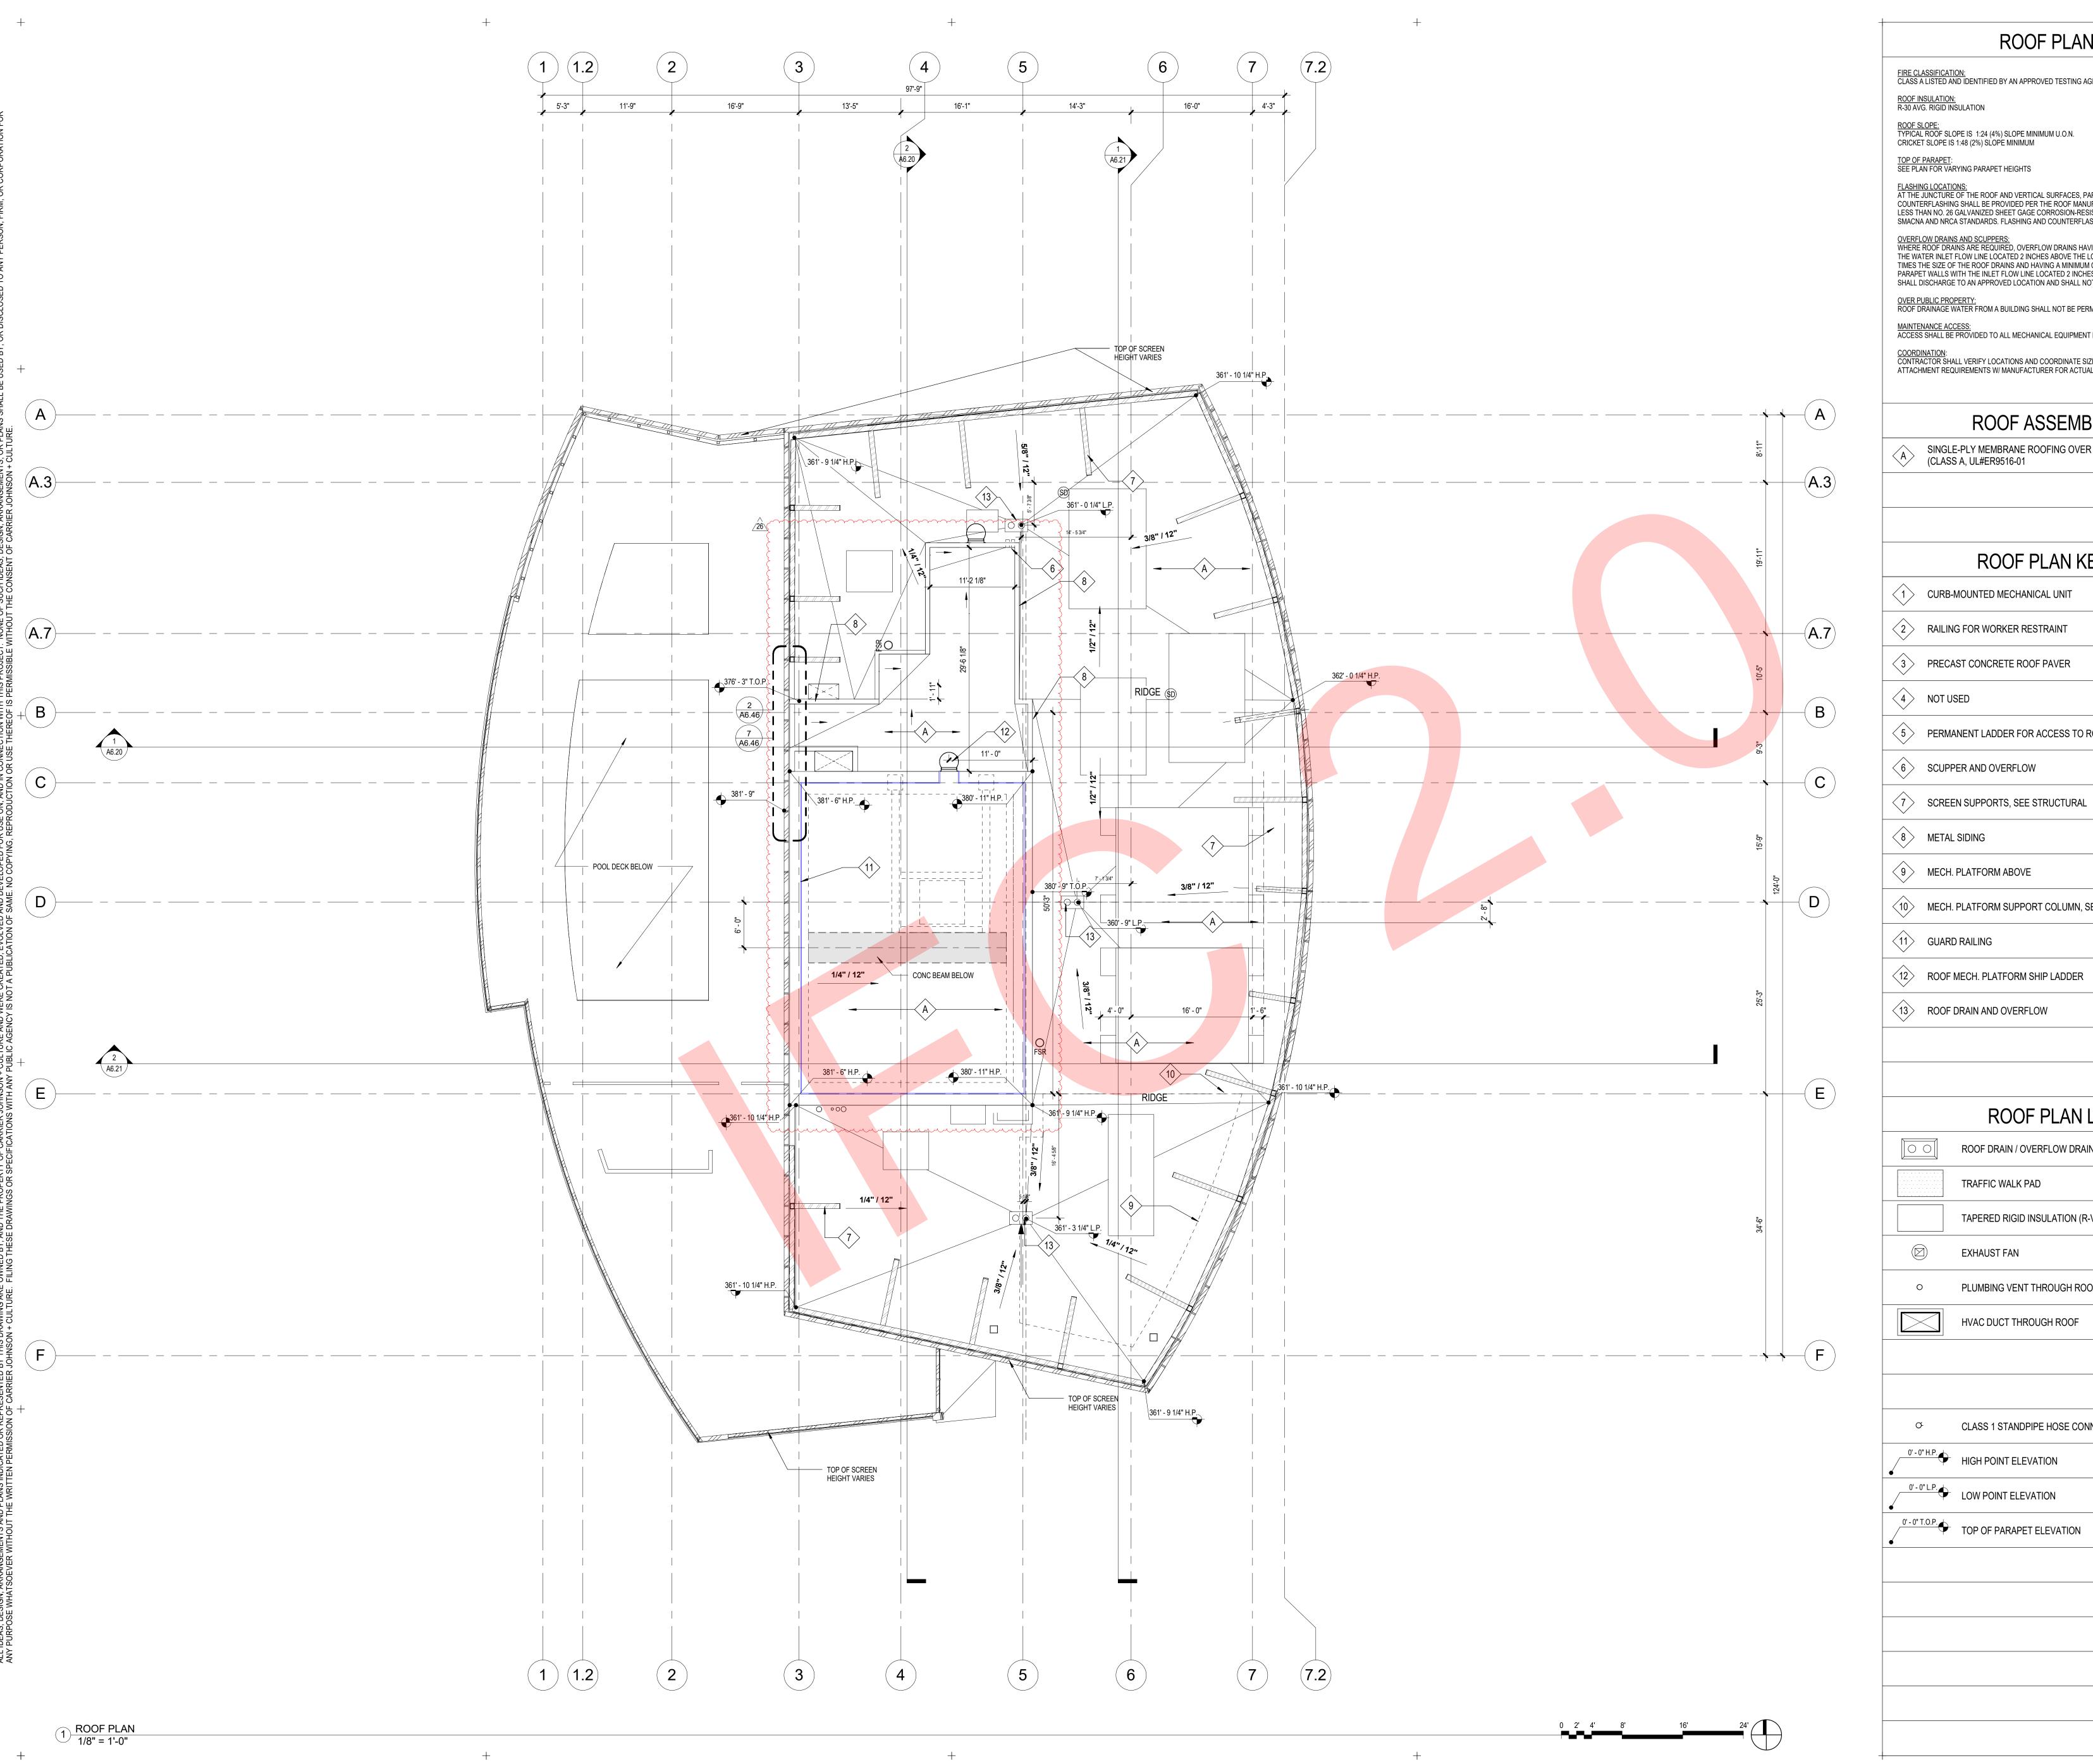

ROOF PLAN GENERAL NOTES

<u>FIRE CLASSIFICATION:</u> CLASS A LISTED AND IDENTIFIED BY AN APPROVED TESTING AGENCY (CBC 1505)

ROOF INSULATION: R-30 AVG. RIGID INSULATION

ROOF SLOPE: TYPICAL ROOF SLOPE IS 1:24 (4%) SLOPE MINIMUM U.O.N. CRICKET SLOPE IS 1:48 (2%) SLOPE MINIMUM

TOP OF PARAPET: SEE PLAN FOR VARYING PARAPET HEIGHTS

FLASHING LOCATIONS:
AT THE JUNCTURE OF THE ROOF AND VERTICAL SURFACES, PARAPETS, ROOF EDGES, ROOF PENETRATIONS, ETC., FLASHING AND COUNTERFLASHING SHALL BE PROVIDED PER THE ROOF MANUFACTURER'S RECOMMENDATIONS AND, WHEN OF METAL, SHALL NOT BE LESS THAN NO. 26 GALVANIZED SHEET GAGE CORROSION-RESISTANT METAL. (CBC 1503) ALL ROOF FLASHINGS SHALL CONFORM TO SMACNA AND NRCA STANDARDS. FLASHING AND COUNTERFLASHING SHALL BE PAINTED U.O.N.

OVERFLOW DRAINS AND SCUPPERS:
WHERE ROOF DRAINS ARE REQUIRED, OVERFLOW DRAINS HAVING THE SAME SIZE AS THE ROOF DRAINS SHALL BE INSTALLED WITH THE WATER INLET FLOW LINE LOCATED 2 INCHES ABOVE THE LOW POINT OF THE ROOF, OR OVERFLOW SCUPPERS HAVING THREE TIMES THE SIZE OF THE ROOF DRAINS AND HAVING A MINIMUM OPENING HEIGHT OF 4 INCHES MAY BE INSTALLED IN THE ADJACENT PARAPET WALLS WITH THE INLET FLOW LINE LOCATED 2 INCHES ABOVE THE LOW POINT OF THE ADJACENT ROOF. OVERFLOW DRAINS SHALL DISCHARGE TO AN APPROVED LOCATION AND SHALL NOT BE CONNECTED TO ROOF DRAIN LINES

OVER PUBLIC PROPERTY:
ROOF DRAINAGE WATER FROM A BUILDING SHALL NOT BE PERMITTED TO FLOW OVER PUBLIC PROPERTY

MAINTENANCE ACCESS:
ACCESS SHALL BE PROVIDED TO ALL MECHANICAL EQUIPMENT LOCATED ON THE ROOF AS REQUIRED BY THE MECHANICAL CODE

COORDINATION: CONTRACTOR SHALL VERIFY LOCATIONS AND COORDINATE SIZES FOR ALL ROOF OPENINGS, CURBS, CONCRETE PADS, AND ATTACHMENT REQUIREMENTS W/ MANUFACTURER FOR ACTUAL MECHANICAL EQUIPMENT SUBMITTED

	ROOF ASSEMBLY TYPES	DETAIL	SPEC SECTION
A	SINGLE-PLY MEMBRANE ROOFING OVER RIGID INSULATION (R-30 MINIMUM) (CLASS A, UL#ER9516-01	-/A8.30	DIV.07

		1	Г
	ROOF PLAN KEYNOTES	DETAIL	SPEC SECTION
$\langle 1 \rangle$	CURB-MOUNTED MECHANICAL UNIT		DIV.23
2	RAILING FOR WORKER RESTRAINT	10/A8.25	05 50 00
3>	PRECAST CONCRETE ROOF PAVER		07 76 00
4	NOT USED		
5	PERMANENT LADDER FOR ACCESS TO ROOF WITH INTEGRAL SAFETY RAIL	1&2/A8.36	07 62 00
6	SCUPPER AND OVERFLOW	14/A8.36	07 62 00
7	SCREEN SUPPORTS, SEE STRUCTURAL		
8	METAL SIDING	A8.41	07 41 00
9	MECH. PLATFORM ABOVE		
10>	MECH. PLATFORM SUPPORT COLUMN, SEE STRUCTURAL		
<u> </u>	GUARD RAILING	10/A8.25	
(12)	ROOF MECH. PLATFORM SHIP LADDER	13/A8.36	

				03/09/2019	LBFD	
		DETAIL	SPEC			
	ROOF PLAN LEGEND	DETAIL	SECTION			
		0/4.0.00	D.11 / 0.0			
	ROOF DRAIN / OVERFLOW DRAIN	6/A8.36	DIV 22	01/24/2019	2ND BUILDING SUB.	
	TRAFFIC WALK PAD	12/A8.36	07 54 19	01/14/2019	ASI-005/ VE TIER 2	
	TAPERED RIGID INSULATION (R-VALUE = 30 MIN.)	_	07 54 19	11/07/2018	FOUNDATION ONLY	
	,					
(\square)	EXHAUST FAN		DIV 23	04/20/2018	1ST CITY SUBMITTAL	
				04/03/2018	ADDENDUM A	
	PLUMBING VENT THROUGH ROOF (VTR)	2/A8.35	DIV 22	03/12/2018	75% BID SET	
0				02/21/2018	50% CD SUBMITTAL	
				10/16/20	100% DD SUBMITTAL	
	HVAC DUCT THROUGH ROOF	15/A8.36	DIV 23	08/10/2017	50% DD SUBMITTAL	
				DATE:	ISSUE	
				KNSED ARCHITA		
				CLAUDIA C. C.		
			I	/ ~/	_\	

CLASS 1 STANDPIPE HOSE CONNECTION

Carrierjohnson

S

02/20/2020 IFC 2.0

07/26/2019 Full Permit Resubmittal

06/7/2019 Full Permit Resubmittal

PROJECT NO: 5727.00

FILE NAME:
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(I.E. P:\0000.000\BIM\Central File\0000.00-central.rvt) DRAWN BY: CHECKED BY:

ROOF PLAN N

A2.37

