
Attachment B

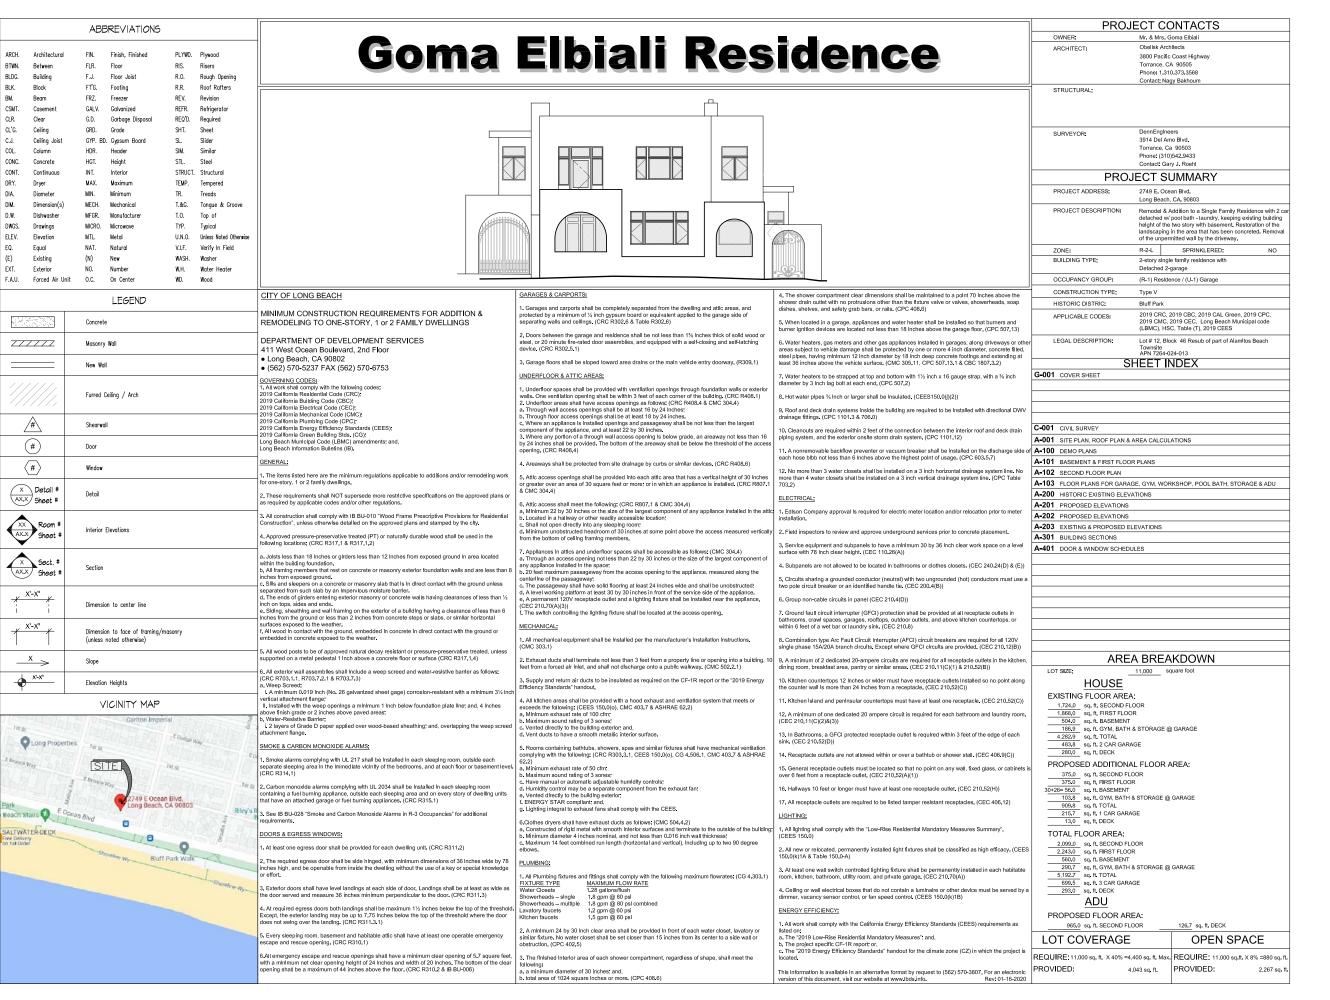

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PROJECT

Goma Elbiali Residence

2749 E. Ocean Blvd. Long Beach, CA 90803

REVISIONS
Application #COAC2203-0

PROJECT NUMBER
2010 ELB OCE LB

January 3, 2023




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BENCHMARK: CITY OF LONG BEACH BENCHMARK 1073/NW
A BRASS DISC FLUSH WITH PAVEMENT, STAMPED "CLB BM 1073 1988"

BENCHMARK ELEVATION = 44.02'

3914 DEL AMO BLVD, SUITE 921 TORRANCE, CA 90503 (310) 542-9433

SURVEY AND TOPOGRAPHY

GOMA ELBIALI
2749 E. OCEAN BOULEVARD
LONG BEACH, CA, 90803
PHONE

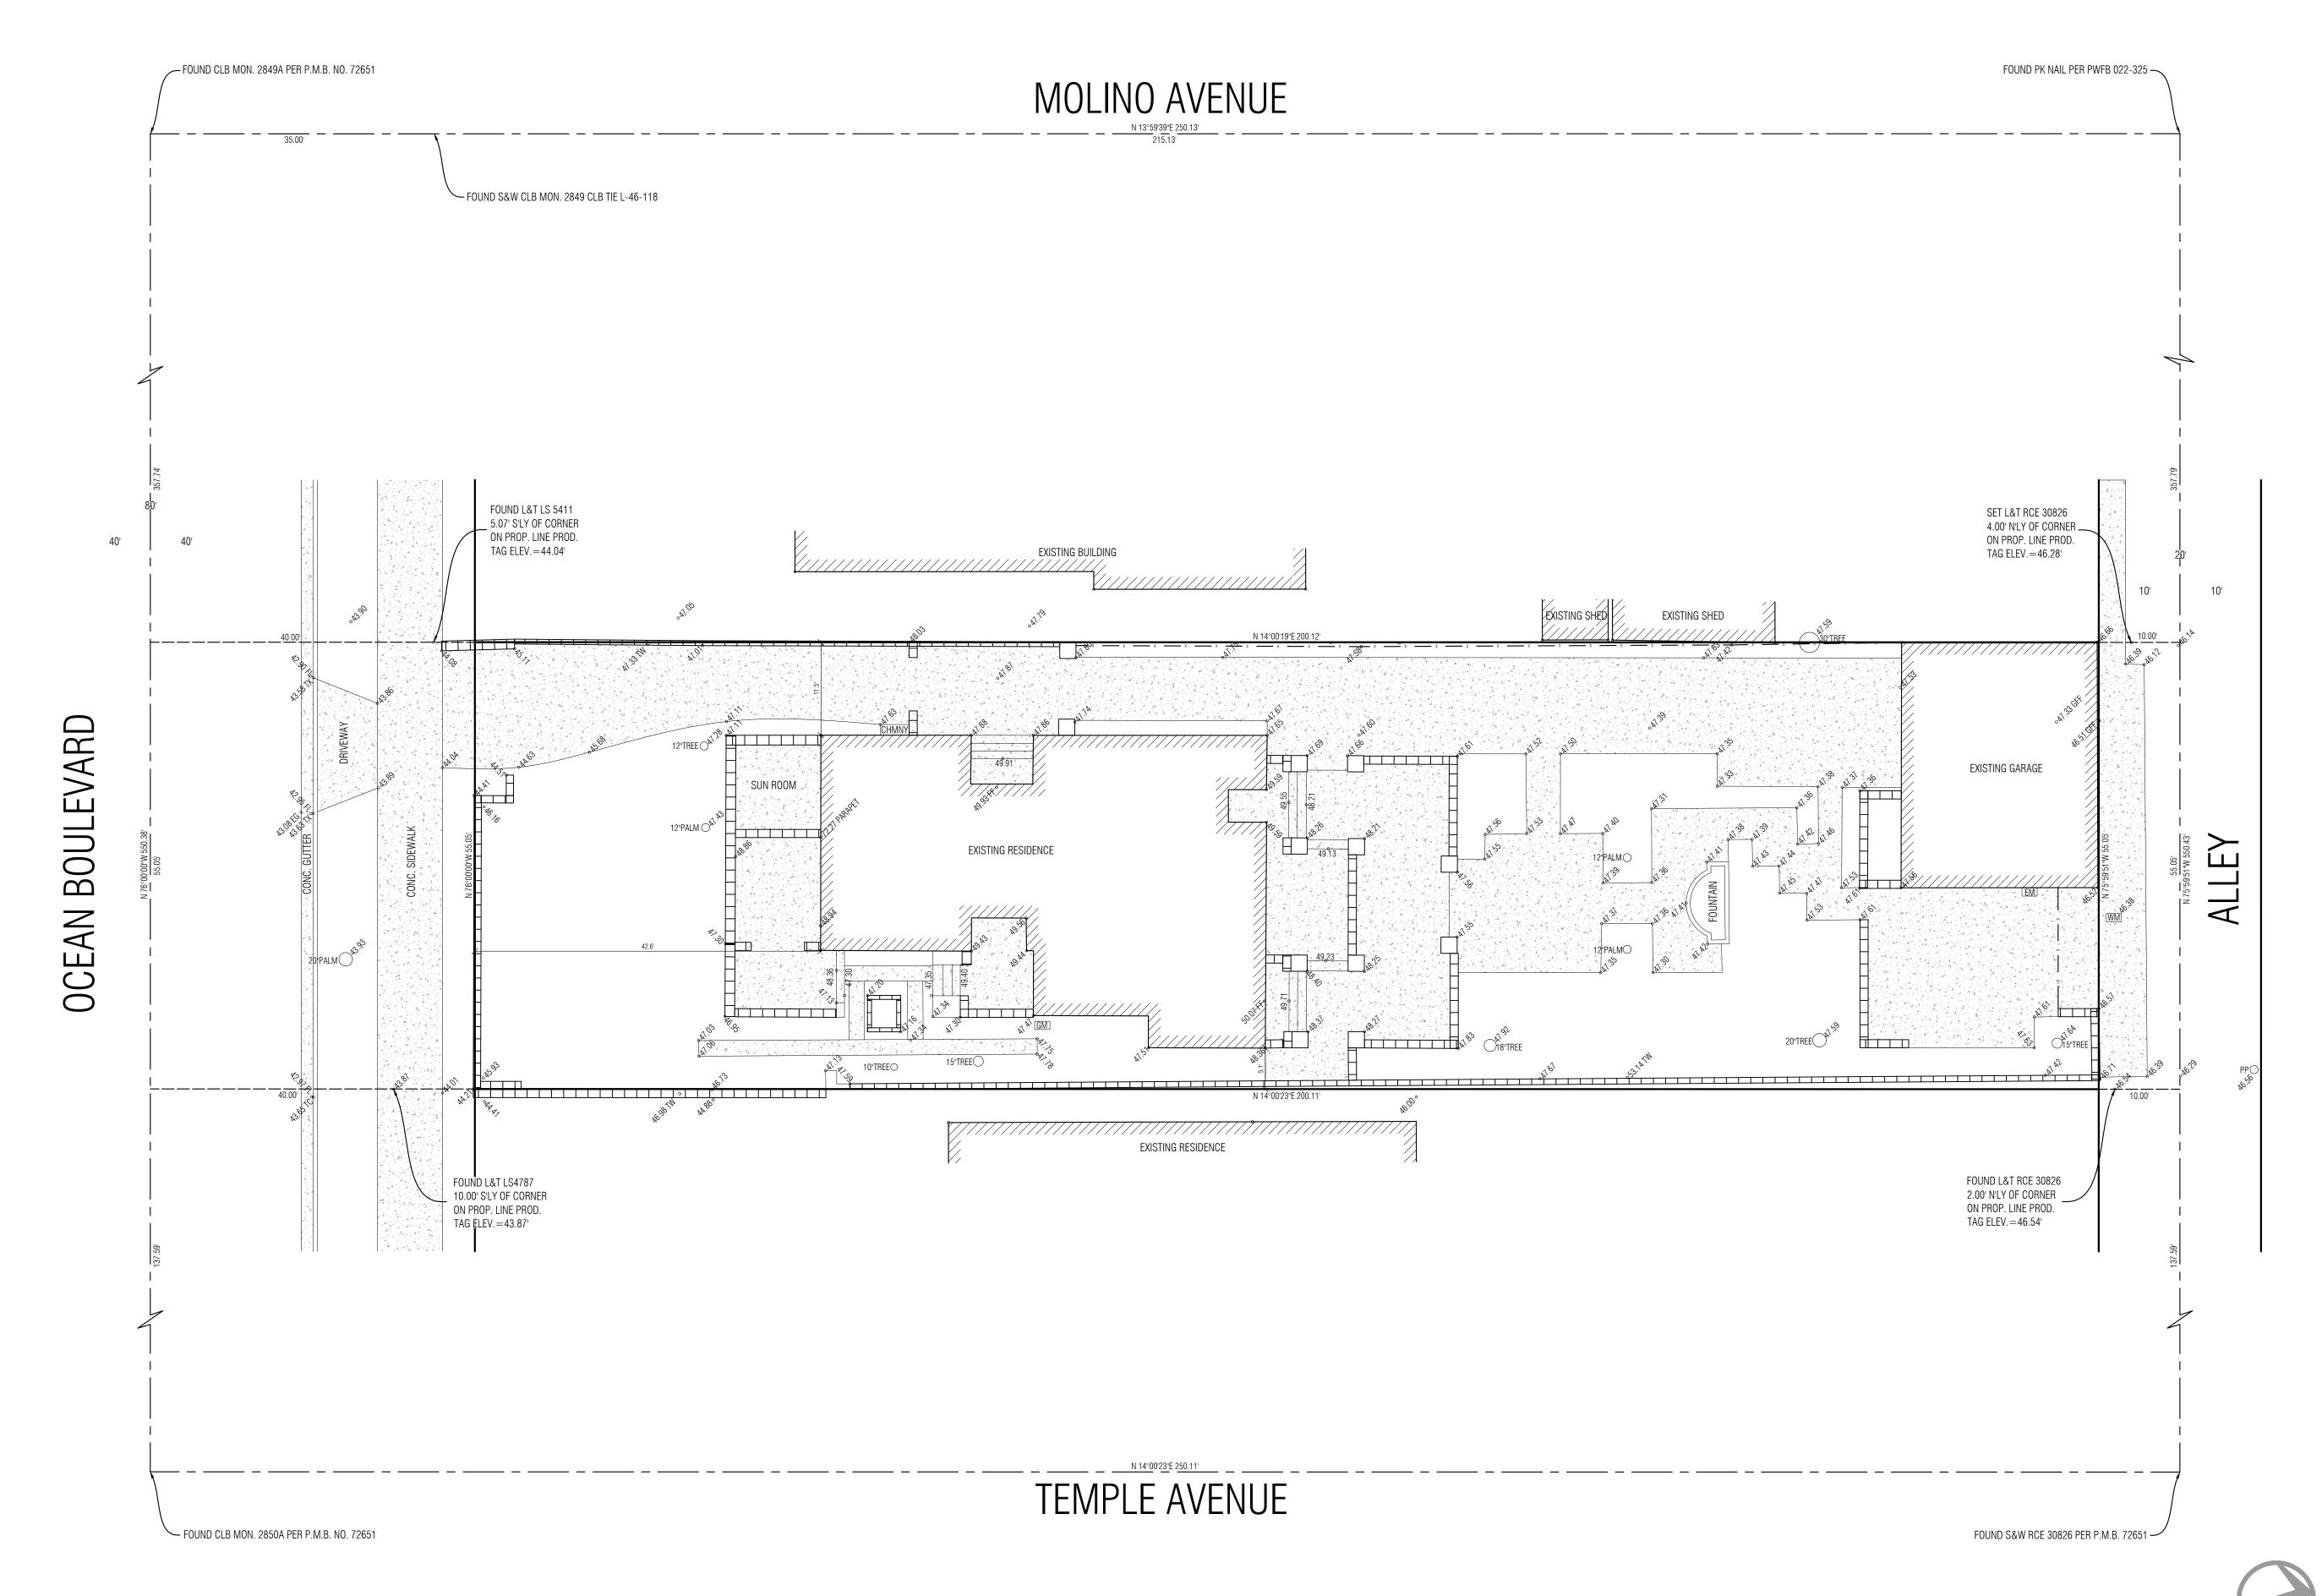JOB ADDRESS 2749 E. OCEAN BOULEVARD LONG BEACH, CA, 90803

LEGAL DESCRIPTION

APN 7264-024-013

LOT 12, BLOCK 46
RESUB. OF ALAMITOS BEACH TOWNSITE
M B 5

THIS MAP CORRECTLY REPRESENTS A SURVEY MADE BY ME OR UNDER MY DIRECTION IN CONFORMANCE WITH THE REQUIREMENTS OF PROFESSIONAL LAND SURVEYORS' ACT



GARY J. ROEHL

AWN BY FM CHECK BY TS

R.C.E. 30826

DRAWN ON DECEMBER 17,

REVISIONS
REVISIONS

LEGEND

EXISTING BUILDING

CONCRETE

O 106.76 EXISTING ELEVATION

 O EXISTING CONTOUR

 BLOCK WALL X EXISTING FENCE

BCR BEGINNING OF CURB RETURN
CATV CABLE TV PULL BOX
CONC. CONCRETE
CHMNY CHIMNEY
CEFB CITY ENGINEERS FIELD BOOK
C/L CENTERLINE
C.L.F. / W.I.F. CHAIN LINK FENCE / WROUGHT IRON FENCE

E'LY EASTERLY
EG EDGE OF GUTTER
EM ELECTRIC METER
FF FINISH FLOOR
FH FIRE HYDRANT
FL FLOW LINE

GM GAS METER
GUY / GW GUY WIRE
I.P. IRON PIPE MONUMENT
L&T LEAD AND TACK / TAG MONUMENT
MH MANHOLE (SANITARY SEWER / STORM DRAIN)
N'LY NORTHERLY

GARAGE FINISH FLOOR

N&T NAIL AND TAG MONUMENT
PB PULL BOX (EDISON / TRAFFIC / STREET LIGHT
PB (CONT) TELEPHONE / CABLE TV)
PC PROPERTY CORNER / PROP. LINE
PD (LID PROPERTY LINE PROP. LINE

PP/UP POWER POLE / UTILITY POLE
PPT PARAPET
PWFB PUBLIC WORKS FIELD BOOK
R.R. RAIL ROAD
RDFB ROAD DEPARTMENT FIELD BOOK

R.S. RECORD OF SURVEY
SPK / S&W SPIKE / SPIKE AND WASHER MONUMENT
S'LY SOUTHERLY
SSCO SANITARY SEWER CLEANOUT
STK / STK&T STAKE / STAKE AND TAG MONUMENT

STLT / LT STREET LIGHT POLE / LIGHT POLE
TC TOP OF CURB
TX / BX TOP OF APRON / BOTTOM OF APRON
WLY WESTERLY
WM WATER METER
NOTE: ALL SETBACK DIMENSIONS SHOWN

ARE MEASURED TO EXTERIOR SURFACE OF BUILDINGS UNLESS OTHERWISE NOTED.
BOUNDARY MONUMENTS ARE NOT NECESSARILY SET ON PROPERTY CORNERS. PLEASE REFER TO THE NOTATION ON THIS SURVEY PLAT FOR OFFSET DIMENSIONS. IF THERE ARE ANY QUESTIONS,


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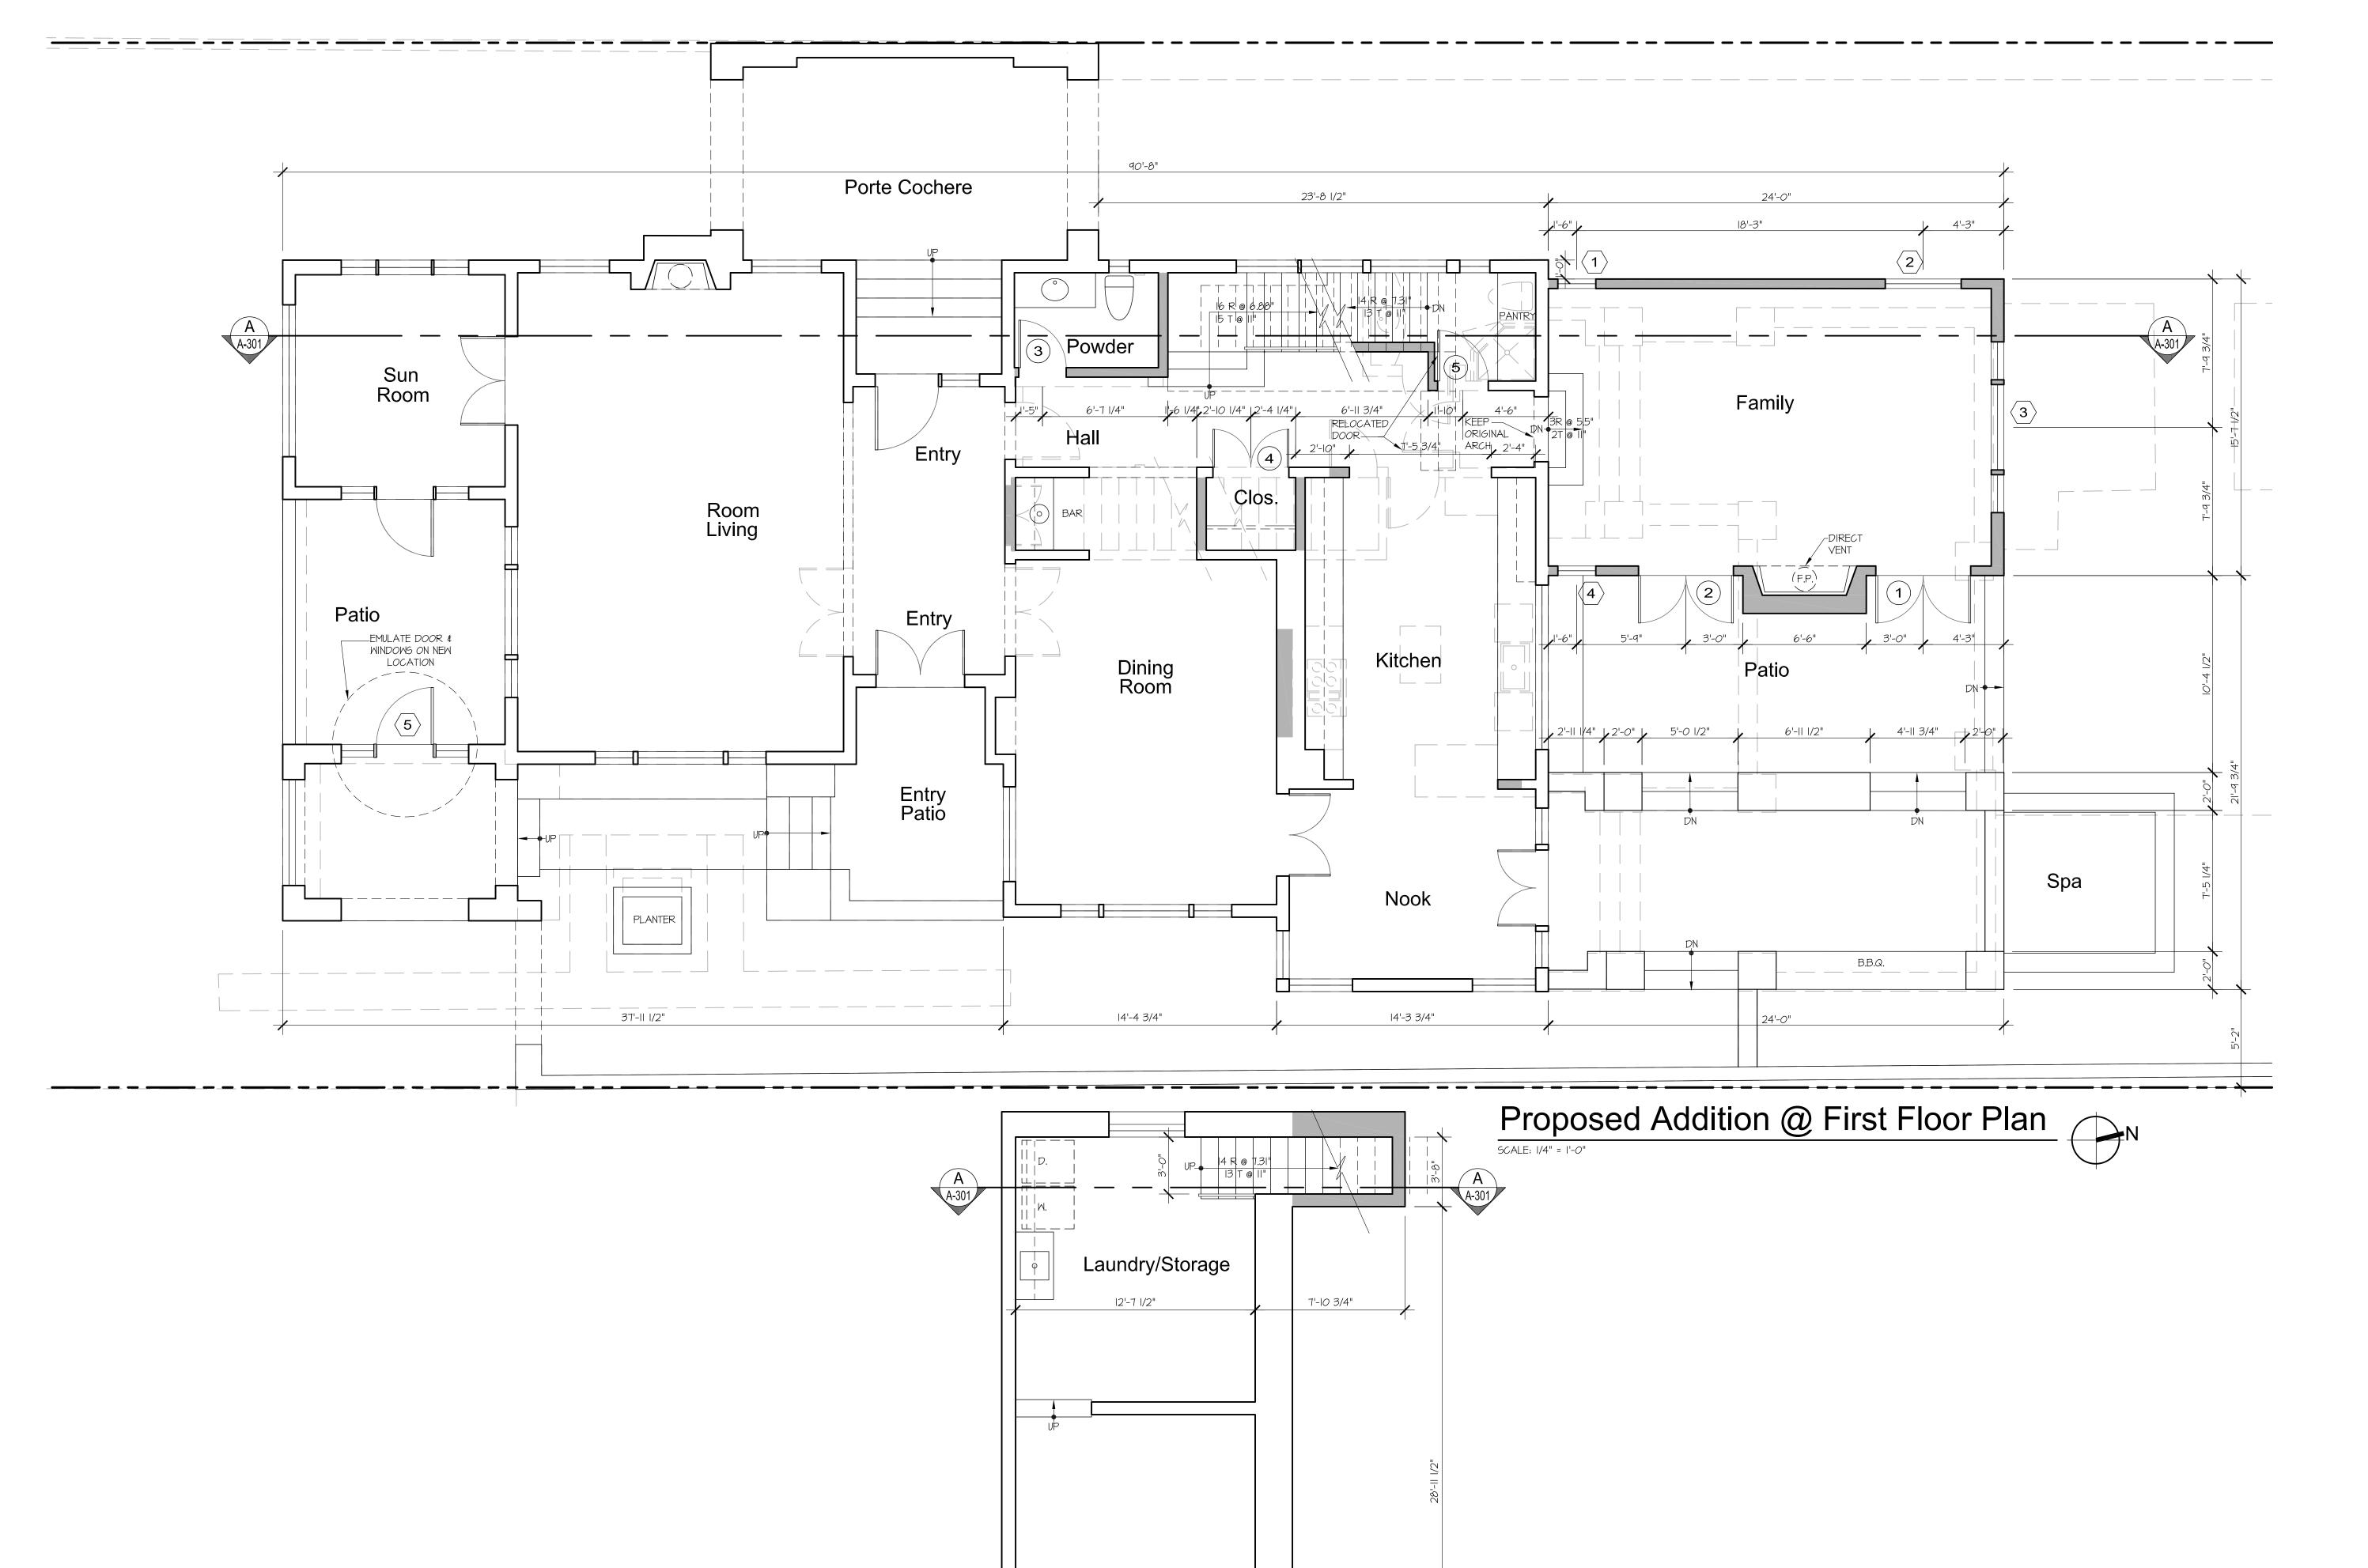
SCALE 1" = 10'

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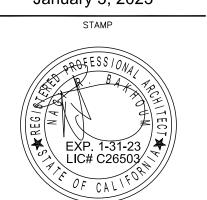
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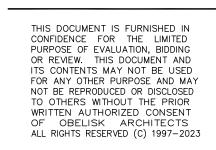
2010 ELB OCE LB

DATE



SHEET TITLE

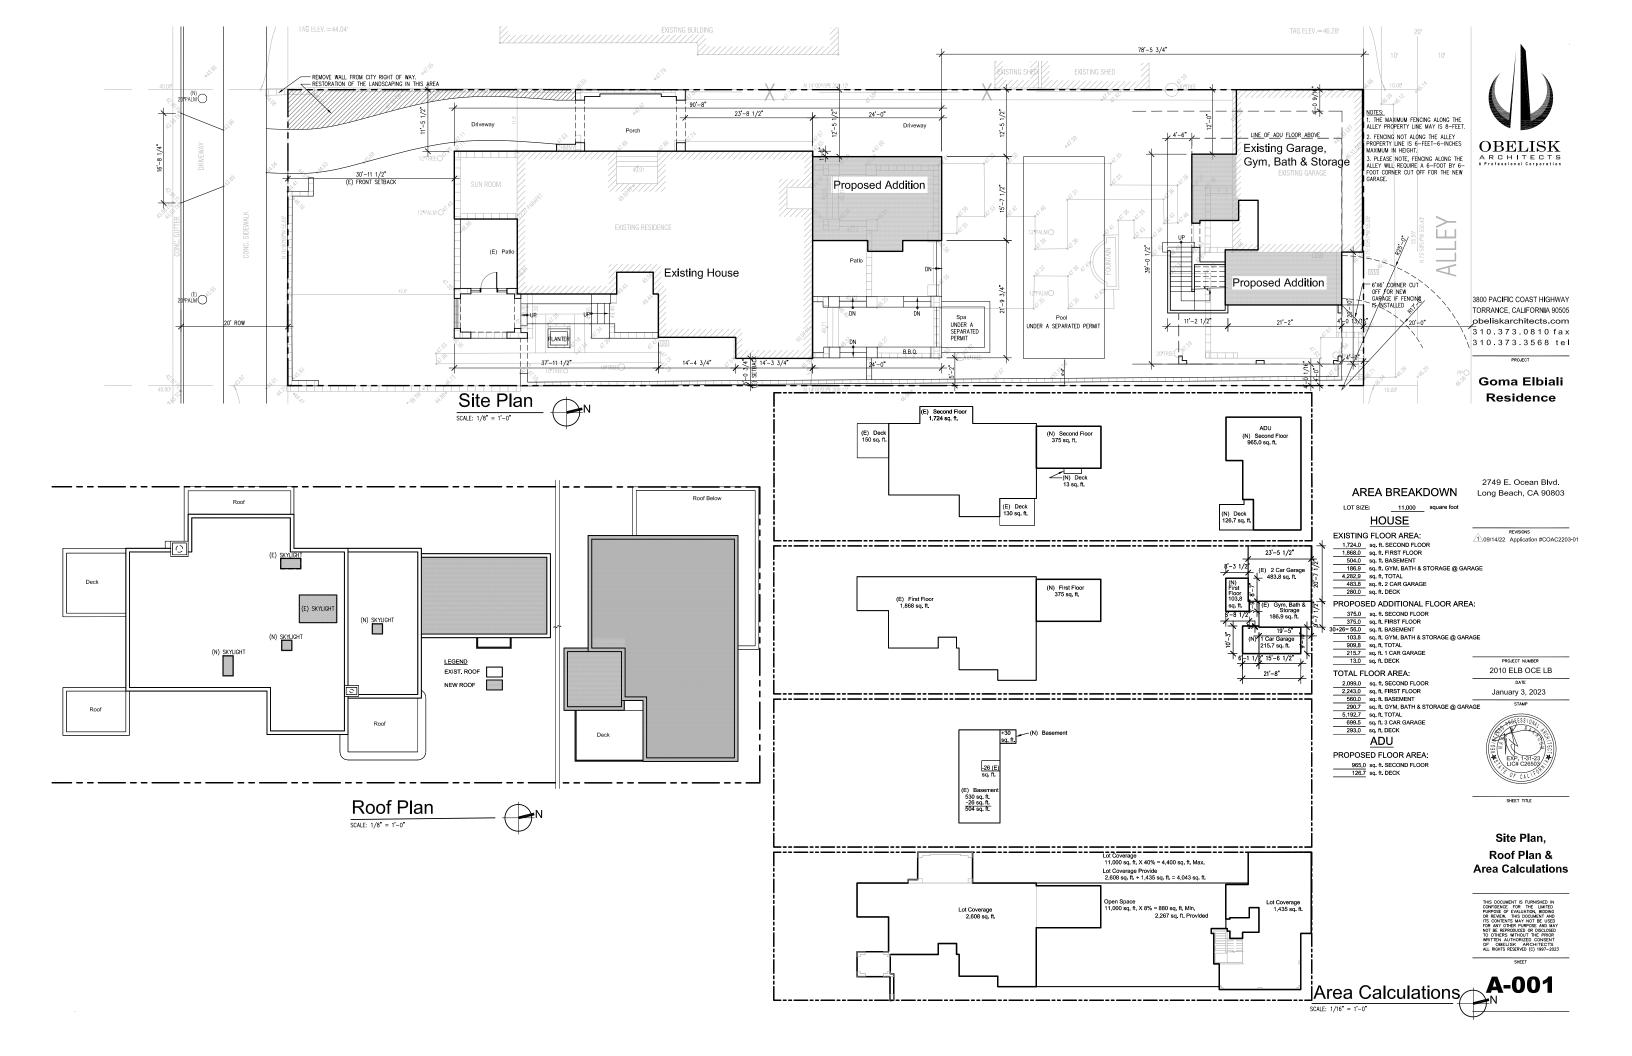Basement & First Floor Plans




<u>LEGEND</u> EXIST. WALL NEW WALL

Proposed Addition @ Basement

SCALE: 1/4" = 1'-0"

EXIST. WALL TO BE DEMOLISHED

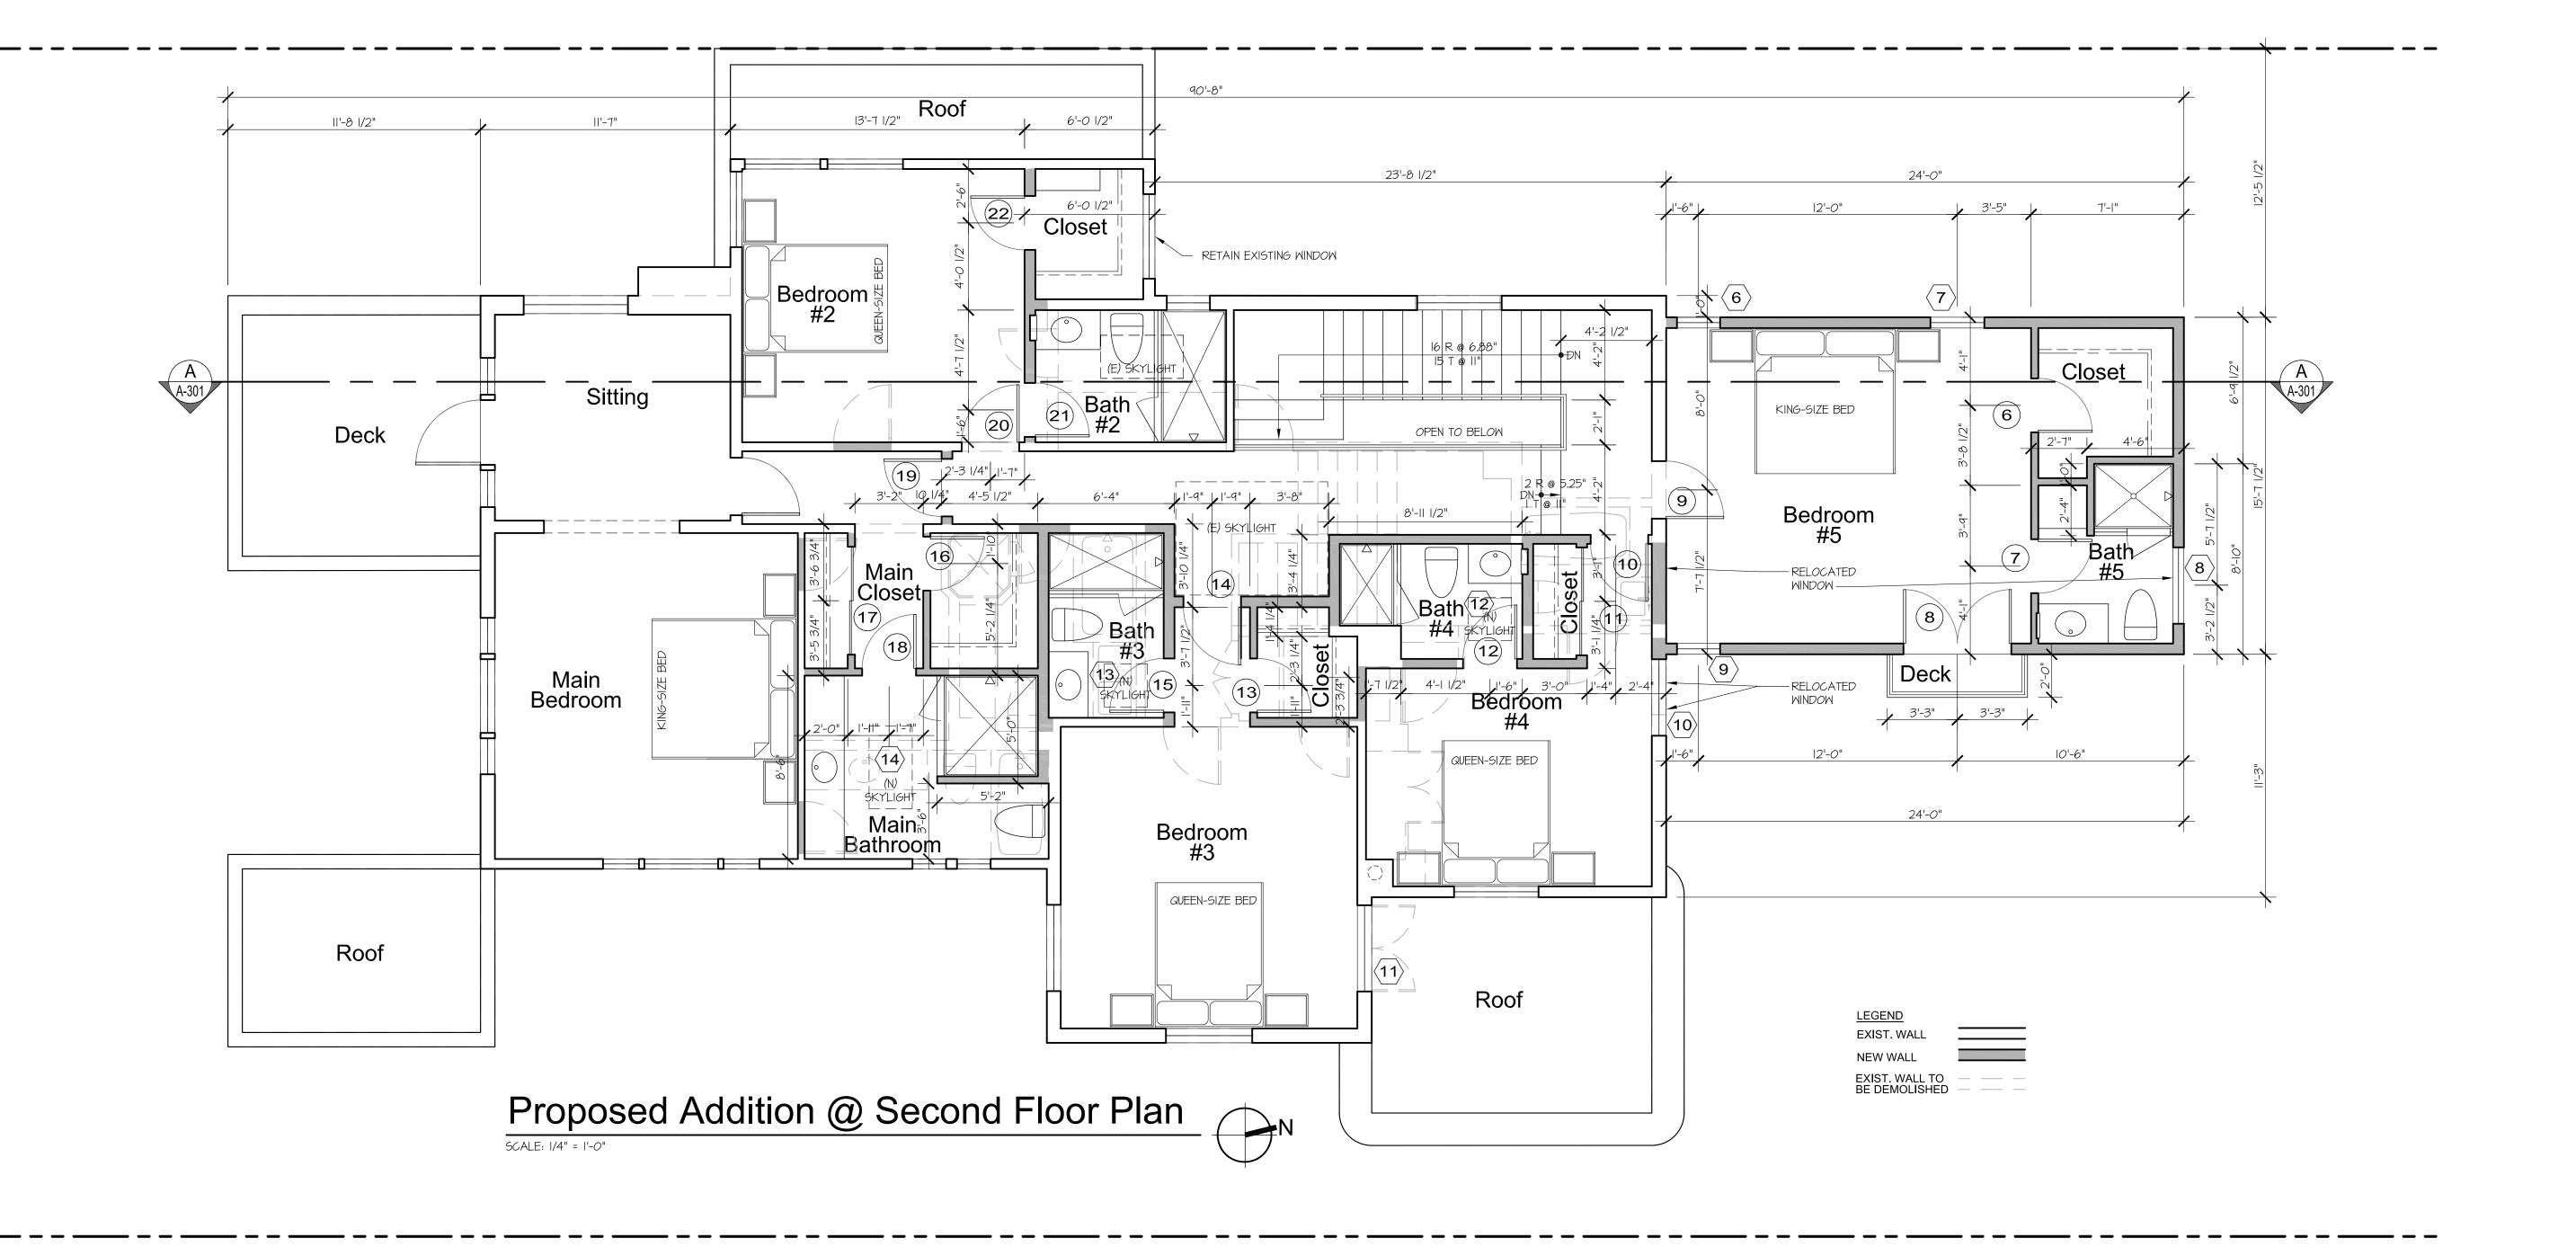



Goma Elbiali Residence

2749 E. Ocean Blvd. Long Beach, CA 90803

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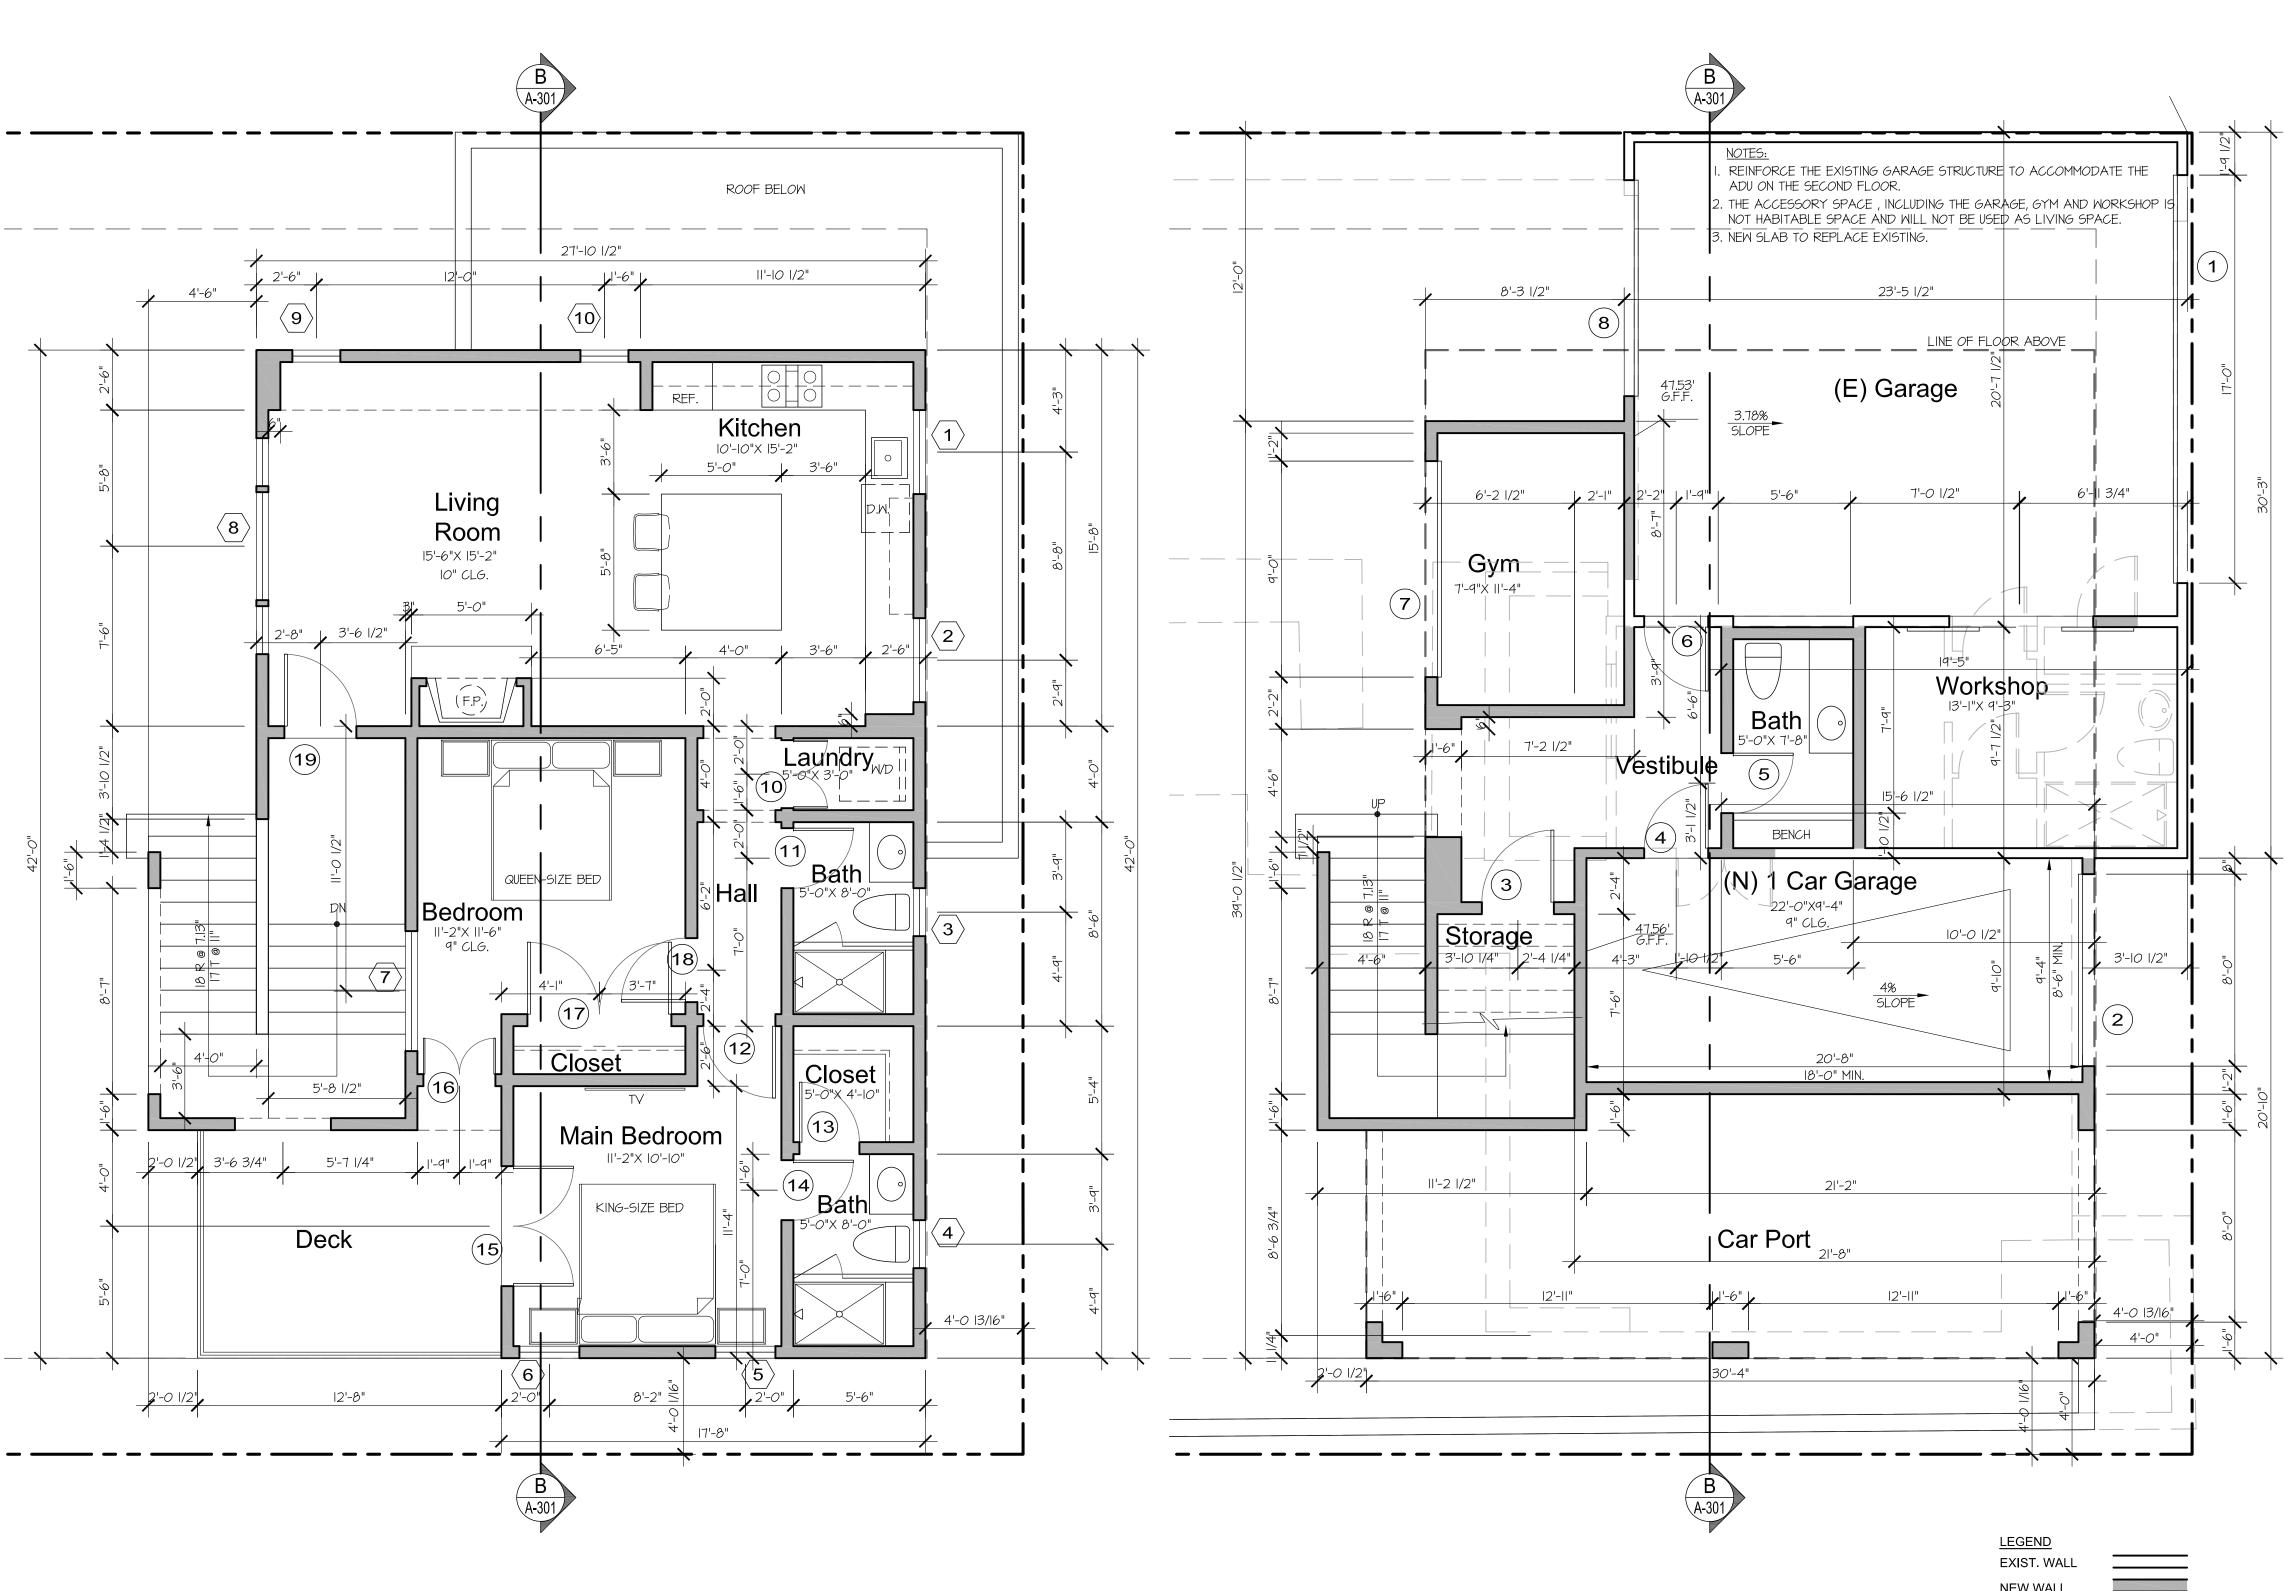
January 3, 2023



SHEET TITLE

Second Floor Plan

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Proposed ADU @ Second Floor Plan

EXIST. WALL TO BE DEMOLISHED Proposed Addition @ First Floor Plan



RECOMMENDATIONS. 10. METAL EXHAUST VENT HOOD @ COOKTOP OR RANGE - VERIFY VENTING REQUIREMENTS PER MANUFACTURER'S RECOMMENDATIONS. SHALL VENT TO OUTSIDE BUILDING.

9. COOKTOP OR RANGE - PROVIDE FUEL GAS AND/OR ELECTRICAL SUPPLY AS REQUIRED PER MANUFACTURER'S

1. PROVIDE ALL NECESSARY ELECTRICAL SUPPLY LINES AND CONNECTIONS TO ALL APPLIANCES AS REQUIRED.

3. SEE ELECTRICAL PLANS FOR ELECTRICAL, FUEL GAS, HOSE BIBB, WATER HOOKUPS, ETC. AND ADDITIONAL

THE FOLLOWING LOCATIONS: (CBC 907.2.10.1.2). PROVIDE ONE CO2 DETECTOR TO MEET CODE.

a.IN EACH ROOM USED FOR SLEEPING PURPOSES. (SMOKE DETECTOR)

c.ONE PER EVERY STORY. (SMOKE DETECTOR & CARBON MONOXIDE)

PERIODS WITHIN 24 HOURS PER CEC SECTION 150 (1). HVAC WILL BE ZONED BY FLOOR.

TO OUTSIDE AIR. SEE ELECTRICAL PLANS FOR LOCATIONS. 8. ALL COOKING EQUIPMENT MUST BE LISTED FOR RESIDENTIAL USE.

2. SMOKE ALARM AND CARBON MONOXIDE ALARMS SHALL RECEIVE THEIR PRIMARY POWER SOURCE FROM THE BUILDING WIRING AND SHALL BE EQUIPPED WITH BATTERY BACK UP AND LOW BATTERY SIGNAL. (907.2.10.1.3, 908.2.10.5.2). SMOKE ALARMS (i.e., SMOKE DETECTORS) AND CARBON MONOXIDE ALARMS SHALL BE INSTALLED AND MAINTAINED AT ALL OF

b.ON THE CEILING OR WALL OUTSIDE IMMEDIATE VICINITY SLEEPING ROOM. (SMOKE DETECTOR & CO)

4. PROVIDE ALL NECESSARY FUEL GAS SUPPLY LINES WITH SHUTOFF VALVES TO ALL GAS FIRED OPERATED APPLIANCES

7. ROOM EXHAUST FAN - CAPABLE OF PROVIDING 5 COMPLETE AIR CHANGES PER HOUR WITH BACK DRAFT DAMPER, VENT

6. ALL HEATING SYSTEMS SHALL HAVE AN AUTOMATIC THERMOSTAT WITH A CLOCK MECHANISM WHICH THE BUILDING OCCUPANT CAN MANUALLY PROGRAM TO AUTOMATICALLY SET BACK THE THERMOSTAT SET POINT AT LEAST TWO

Floor Plan Notes:

MECHANICAL

11. PROVIDE BUILT-IN MICROWAVE OVEN. VERIFY VENTING REQUIREMENTS PER MANUFACTURER'S RECOMMENDATIONS.

12. ANY CLOTHES DRYER LOCATED IN A HABITABLE SPACE OR IN AN AREA WITH OTHER FUEL BURNING APPLIANCES SHALL BE VENTED TO THE OUTSIDE WITH A 4" MINIMUM DIAMETER, SMOOTH, GALVANIZED, METAL DUCT. THE EXHAUST DUCT IS

LIMITED TO 14'-0" IN LENGTH WITH TWO ELBOWS. THIS LENGTH SHALL BE REDUCED 2'-0" FOR EVERY ELBOW IN EXCESS

OF TWO PER CMC SECTION 504.3 908. PROVIDE WITH WEATHER HOOD AND DAMPER AT EXTERIOR WALL TERMINATION. WOOD-BURNING) OR OTHER LISTED MAKE, APPROVED BY THE BUILDING OFFICIAL, WITH APPROVED SPARK ARRESTOR FLUE TERMINATION. FIREPLACE HEARTH TO BE OF NON-COMBUSTIBLE MATERIAL. ANY CHANGE FROM THE APROVED ITEM IS APPROVED IN THE PLAN CHECK OFFICE, NOT BY THE FIELD INSPECTOR. PROVIDE FUEL GAS AND LOOSE KEY VALVE WITH SWITCH OPERATED AUTOMATIC LIGHTER. THE CONTROL VALVE SHALL BE LOCATED OUTSIDE OF EFFECTIVE

14. COMBUSTION AIR VENT - 8"x14" STAINLESS STEEL METAL, SCREENED VENTS, ONE 12" BELOW CEILING AND ONE 12" ABOVE FLOOR, IN EXTERIOR WALL OF MECHANICAL ROOM. 15. UNDERFLOOR VENT - 6"x14" COPPER OR STAINLESS STEEL, SCREENED VENTS EQUAL TO ONE SQUARE FOOT OF VENT

AREA FOR EACH 150 SQUARE FEET OF UNDER FLOOR AREA. VENTS SHALL PROVIDE CROSS VENTILATION ALONG THE LENGTH OF AT LEAST TWO OPPOSITE BUILDING SIDES. 16. 24"x24" LOCKABLE, COPPER, SCREENED ENCLOSURE @ EACH UNDER FLOOR ACCESS, 75% FREE VENT AREA.

17. PROVIDE 18" HIGH PLATFORM FOR F.A.U. AND/OR WATER HEATER IN GARAGE, PROTECT FROM VEHICLE IMPACT WITH 3" DIA. x 36" HIGH CONCRETE FILLED STEEL PIPE EMBEDDED INTO 12" DIA. x 30" DEEP CONCRETE FOOTING AS REQUIRED. 18. GARAGE VENT - 6"x14" STAINLESS STEEL, SCREENED VENT 6" ABOVE GARAGE FLOOR, ONE PER CAR.

19. PROVIDE WHOLE HOUSE INDOOR AIR QUALITY VENTILATION BY MEANS OF CONTINUOUS EXHAUST VENTILATION, SUPPLY VENTILATION OR A COMBINATION OF BOTH EXHAUST AND SUPPLY VENTILATION IN EACH INDIVIDUAL DWELLING UNIT. SPECIFY THE REQUIRED CFM PER 2019 CALIFORNIA ENERGY CODE SECTION 150 (0) AND ASHRAE 62.2. IDENTIFY THE MECHANICAL APPLIANCE PROVIDING THE CONTINUOUS VENTILATION.

INSTALLATION INSTRUCTIONS THAT WERE APPROVED AS PART OF THEIR LISTING. THE GAS PIPING SERVING THIS APPLIANCE MUST BE SIZED IN COMPLIENCE WITH THE WATER HEATER'S LISTED INSTALLATION INSTRUCTIONS AND THE 2019 CALIFORNIA PLUMBING CODE. (NAVIEN NPE 240 TANKLESS WATER HEATER OR EQUAL)

20. GAS TANKLESS WATER HEATERS SHALL BE NATIONALLY LISTED AND BE INSTALLED IN ACCORDANCE WITH THE

21. PROVIDE DEVICES TO ABSORB HIGH PRESSURES RESULTING FROM THE QUICK ACTING VALVES OF THE WASHER DISHWASHER, ETC. PER CPC SECTION 609.10. 22. PLUMBING FIXTURES; LOW FLOW TOILETS - 1.28 GALLONS PER FLUSH, SHOWER HEADS - NO MORE THAN 2.0 GALLONS PER MINUTE & FAUCETS - 1.5 GALLONS PER MINUTE PER H. & S. CODE SECTION 17921.3(b). IAMPO APPROVAL REQUIRED

FOR ONE PIECE LAVATORIES. 23. A 12"x12" MIN. ACCESS PANEL TO BATHTUB TRAP CONNECTION IS REQUIRED UNLESS PLUMBING IS WITHOUT SLIP JOINTS

24. PROVIDE PRESSURE BALANCED OR THERMOSTATIC MIXING CONTROL VALVES AT SHOWERS AND TUB-SHOWERS PER

25. REFRIGERATOR/FREEZER - PROVIDE PURIFIED COLD WATER SUPPLY LINE TO ICE MAKER WITH RECESSED SHUTOFF VALVE WITH FILTERED WATER UNIT LOCATED ADJACENT TO APPLIANCE. 26. PROVIDE RECESSED HOT AND COLD WATER, DRAIN STANDPIPE & J.R. SMITH FLOOR DRAIN, OR APPROVED EQUAL, @

CLOTHES WASHER. PROVIDE AN APPROVED TRAP PRIMER. 27. ALL HOSE BIBBS MUST BE PROTECTED BY AN ANTI-SIPHON DEVICE.

28. PROVIDE GALVANIZED METAL DRIP PANS OR OTHER DEVICES FOR LAUNDRY ROOM, WATER HEATERS & DISHWASHERS. 29. INSTALL ON THE COLD WATER SUPPLY PIPE AT THE TOP OF THE WATER HEATER A CAPPED "T" FITTING TO PLUMB FOR FUTURE SOLAR WATER HEATING.

30. 4" SEWER LINE SHALL BE USED FOR THE BUILDING. 31. SHOWERS AND SHOWER-TUBS SHALL BE PROVIDED WITH INDIVIDUAL CONTROL VALVES OF THE PRESSURE BALANCE, THERMOSTATIC, OR COMBINATION PRESURE BALANCE/THERMOSTATIC MIXING VALVE TYPE THAT PROVIDE

SCALD AND THERMAL SHOCK PROTECTION (418 CPC) 32. PROVIDE FIBERGLASS BATT THERMAL INSULATION THROUGHOUT ENTIRE RESIDENCE: R-19 IN ALL EXTERIOR WALLS AND

IN WALLS BETWEEN GARAGE AND LIVING AREAS. R-13 IN ALL INTERIOR WALLS. R-30 IN ALL CEILINGS WITH ATTIC SPACE ABOVE. R-19 IN ALL SLOPED, VOLUME CEILINGS WHEN RAFTERS ARE 10" OR LESS. R-30 IN ALL SLOPED, VOLUME CEILINGS WHEN RAFTERS MORE THAN 10". R-30 IN ALL INTERIOR FLOORS. LAUNDRY & BATHROOMS: 33. 24" CLEAR IN FRONT OF WATER CLOSETS AND 30" MINIMUM WIDE WATER CLOSET COMPARTMENT (CBC SECTION 2904)

34. SLAB COUNTERTOP WITH BACKSPLASH @ BATHROOMS, COLOR AND PATTERN BY OWNER. 35. GRANITE SLAB COUNTERTOP WITH FULL BACKSPLASH @ KITCHEN, COLOR BY OWNER.

36. FRAMELESS GLASS SHOWER ENCLOSURE @ ALL TUB AND SHOWER STALLS TO 6'-0" HIGH MIN. MEASURED FROM

ADJACENT FINISH FLOOR UNLESS NOTED OTHERWISE. GLAZING TO BE PERMANENTLY LABELED "TEMPERED". 37. PROVIDE FULL HEIGHT SEALED SHOWER ENCLOSURE w/ GASKETED DOOR @ MASTER BATH SHOWER. SLOPE CEILING 2" PER FOOT MIN. AWAY FROM SEAT. PROVIDE MR. STEAM GENERATOR BY SUSSMAN LIFESTYLE GROUP W/ AUTO FLUSH OR

38. HOT MOPPED SHOWER PAN WITH A DROP DOWN DAM, MINIMUM AREA 1,024 SQUARE INCHS AND 30" DIAMETER CLEAR PER CPC 408.5. CONTRACTOR TO LEAK TEST PRIOR TO INSTALLING FINISHES.

39. SHOWERS AND WALLS ABOVE BATHTUBS WITH SHOWER HEADS SHALL BE FINISHED WITH A SMOOTH, NONABSORBENT SURFACE TO A HEIGHT NOT LESS THAN 72" ABOVE THE DRAIN INLET. (1210.3 CBC) 40. WALL FINISH @ SHOWER OR TUB/SHOWER - CERAMIC TILE OR OTHER LISTED MAKE APPROVED BY THE BUILDING

OFFICIAL, ANY CHANGE FROM THE APPROVED ITEM IS APPROVED IN THE PLAN CHECK OFFICE, NOT THE FIELD INSPECTOR. 70" HIGH MIN. ABOVE DRAIN. TILE DETAILING PER TILE COUNCIL OF NORTH AMERICA STANDARDS. MATERIAL OTHER THAN STRUCTURAL ELEMENTS TO BE MOISTURE RESISTANT. 41. COMPARTMENTED MEDICINE CABINET WITH BEVELED GLASS MIRROR IN BATHROOMS WHERE SHOWN.

INTERIOR WALLS: 42. 5/8" GYPSUM BOARD INTERIOR FINISH. FASTENED TO WALLS AND CEILING WITH DRYWALL SCREWS AND TWO SKIM FINISH COATS OF GYPSUM.

43. ALL UNDER STAIR AREA WALLS AND CEILING TO BE PROVIDED WITH 5/8" TYPE "X" GYPSUM BOARD. 1-HR. FIRE RESISTIVE CONSTRUCTION PER CBC SECTION 1003.3.9

44. PROVIDE 5/8" TYPE "X" GYPSUM BOARD, 1-LAYER ON WALLS AND 2-LAYERS ON CEILINGS, @ GARAGE (U-1) ADJACENT TO LIVING AREAS (R-3). EXPOSED POSTS AND/OR BEAMS @ GARAGE (U-1) SUPPORTING FLOORS ABOVE TO BE WRAPPED WITH 5/8" TYPE "X" GYPSUM BOARD OR HEAVY TIMBER (8"x8" MIN.) PER CBC SECTION 302.4. DOORS & WINDOWS

45. GLAZING IN ALL DOORS, GLAZING WITHIN A 24" ARC OF A CLOSED DOOR EDGE AND LESS THAN 60" ABOVE FINISH FLOOR, GLAZING PANELS OVER 9 SQUARE FEET HAVING THEIR LOWEST EDGE LESS THAN 18" ABOVE FINISH FLOOR AND HAVING A TOP EDGE GREATER THAN 36" ABOVE FINISH FLOOR, GLAZING STAIRWAY LANDINGS OR WITHIN 5'-0" OF THE TOP OR BOTTOM RISER AND LESS THAN 60" ABOVE FINISH FLOOR AND GLAZING IN GUARDRAILS MUST BE IDENTIFIED BY PERMANENT LABEL AS TEMPERED.

46. DOORS THAT SWING OVER LANDING OR PORCH REQUIRE A LANDING 36" MINIMUM IN LENGTH AND NOT MORE THAN 1/2" BELOW THRESHOLD. DOORS THAT DO NOT SWING OVER A TOP STEP OR LANDING MAY OPEN ON A LANDING OR TOP STEP THAT IS NOT MORE THAN 8" BELOW FINISH FLOOR.

47. BASEMENTS AND EVERY SLEEPING ROOM SHALL HAVE AT LEAST ONE EMERGENCY EGRESS DOOR OR WINDOW OPENING DIRECTLY INTO A YARD OR EXIT COURT. EMERGENCY EGRESS WINDOWS MUST PROVIDE: MINIMUM 5.7 SQ. FT. OF OPENABLE AREA, MINIMUM CLEAR WIDTH OF 20", MINIMUM CLEAR HEIGHT OF 24" AND HAVE A FINISHED SILL HEIGHT OF NOT MORE THAN 44" ABOVE FINISH FLOOR.

48. ALL WINDOW AND SLIDING GLASS DOOR ASSEMBLIES MUST BE DUAL-PANED AND ALUMINUM FRAME OR HAVE A MAXIMUM U-VALUE OF 0.32 & SHGC 0.25

49. ALL DOORS, WINDOWS, AND LOCKS TO COMPLY WITH CBC APPENDIX CHAPTER 10 - BUILDING SECURITY.

50. FLAT, SAFTY GLAZED SKYLIGHT BY VELUX (ICBO # ESR-4108) OR APPROVED EQUAL. 51. THE DOORWAY FROM A GARAGE INTO A LIVING AREA (NOT A BEDROOM) SHALL BE PROTECTED BY A MIN. 1-3/8 INCH SELF-CLOSING, SELF-LATCHING SOLID CORE DOOR, OR A SELF-CLOSING DOOR HAVING A FIRE-PROTECTION RATING OF

NOT LESS THAN 20 MINUTES. (406.1.4 CBC) 52. MIRRORED WARDROBE DOORS TO BE SAFETY GLAZING.

53. TILE OR STONE OVER DEX-O-TEX WATERPROOF MEMBRANE (ICC# ESR 1757) OR APPROVED EQUAL.

54. INDICATE TWO LAYERS OF GRADE D PAPER BETWEEN PLYWOOD SHEAR PANEL AND EXTERIOR LATH

GUARDRAILS: 55. SHALL BE INSTALLED ALONG OPEN-SIDED WALKING SURFACES, INCLUDING STAIRS, RAMPS, AND LANDINGS, THAT ARE LOCATED MORE THAN 30" ABOVE THE FLOOR OR GRADE BELOW AT ANY POINT WITHIN 36" HORIZONTALLY TO THE EDGE

56. SHALL HAVE A HEIGHT OF NOT LESS THAN 42" MEASURED VERTICALLY ABOVE THE WALKING SURFACE, ADJACENT FIXED SEATING, OR THE LINE CONNECTING THE LEADING EDGES OF THE TREADS. GUARDS LOCATED ON THE OPEN SIDE OF STAIRS MAY HAVE A HEIGHT NOT LESS THAN 34".

57. OPENINGS BETWEEN RAILINGS SHALL BE LESS THAN 4". THE TRIANGULAR OPENING FORMED BY THE RISER, TREAD AND BOTTOM ELEMENT OF A GUARDRAIL AT A STAIR SHALL BE LESS THAN 6". GUARDS ON THE OPEN SIDES OF STAIRS SHALL HAVE OPENINGS LESS THAN 4-3/8".

OBELISK

ARCHITECTS

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Goma Elbiali Residence

2749 E. Ocean Blvd. Long Beach, CA 90803

1\09/14/22 Application #COAC2203-01

PROJECT NUMBER

2010 ELB OCE LB

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SHEET TITLE

First & Second **Floor Plans**

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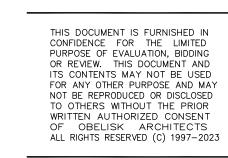
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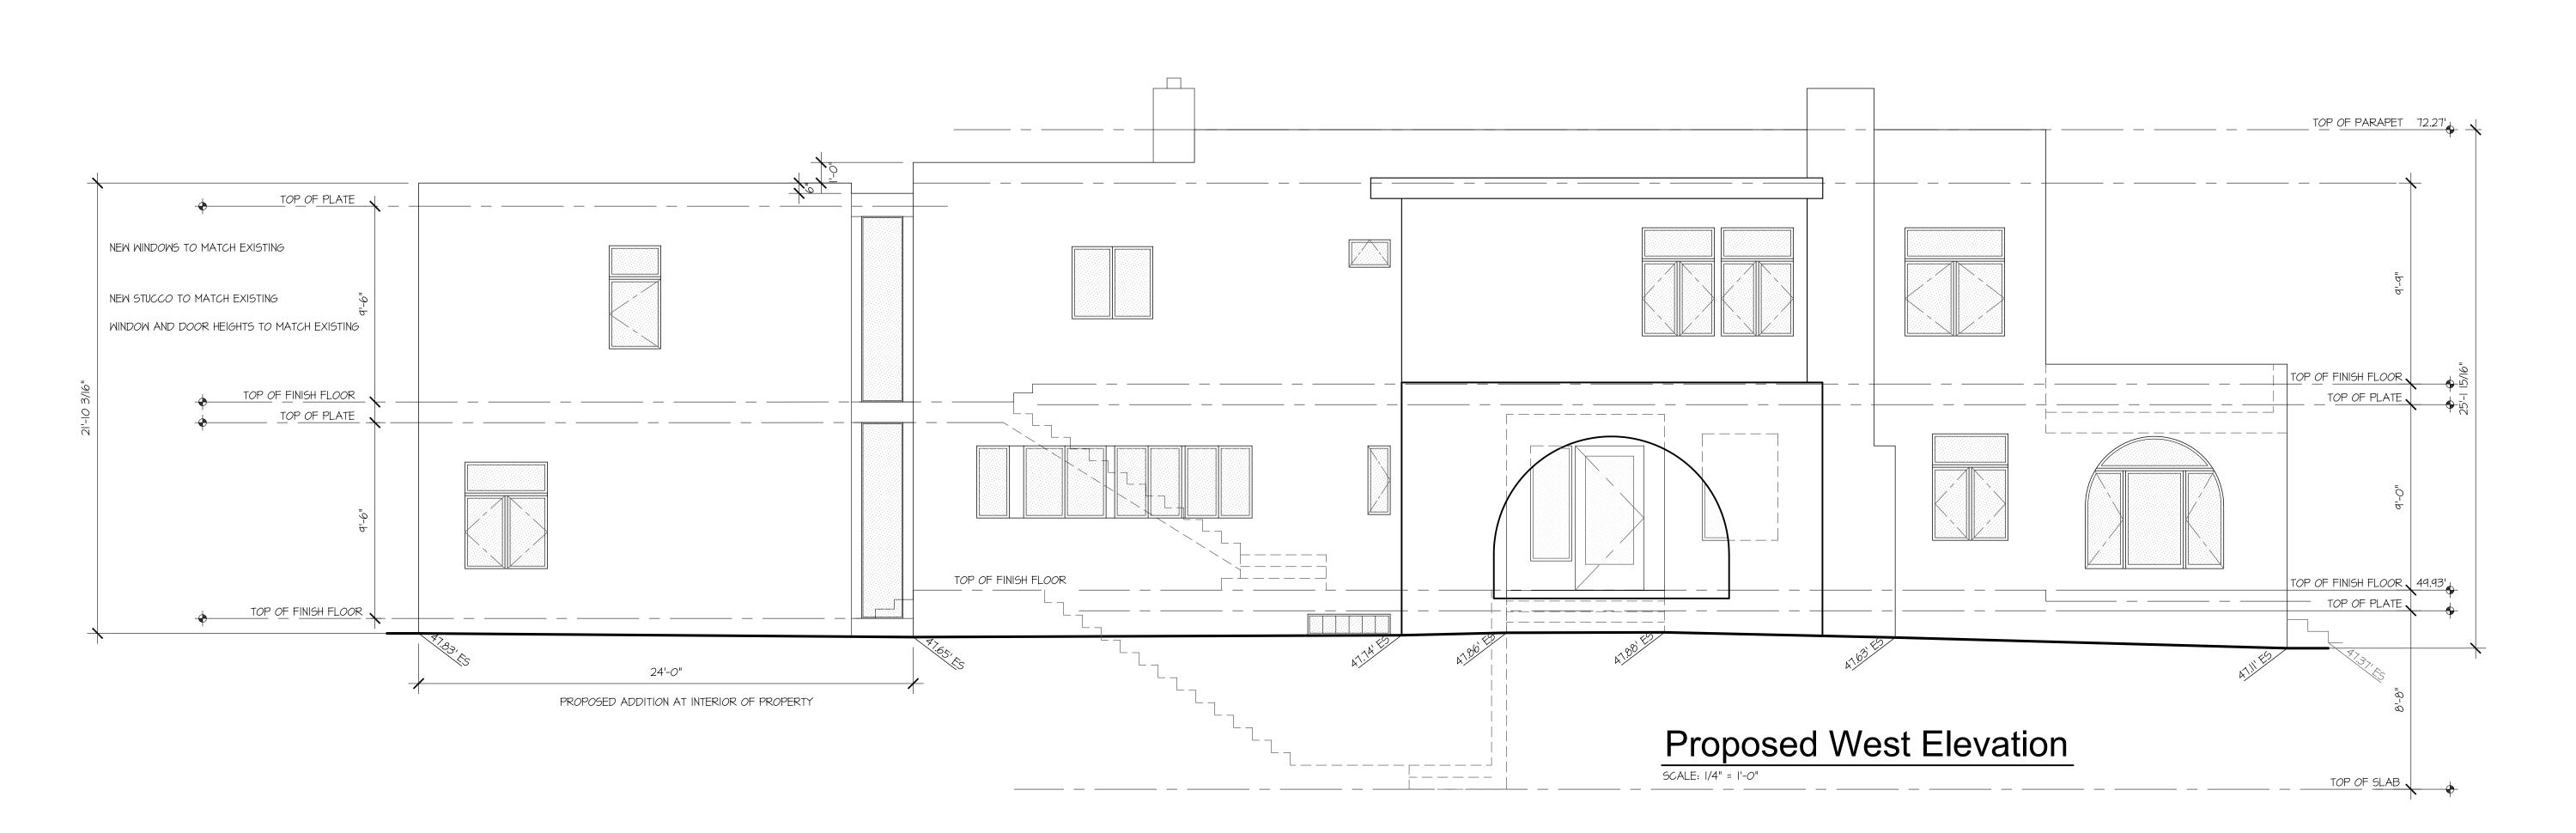
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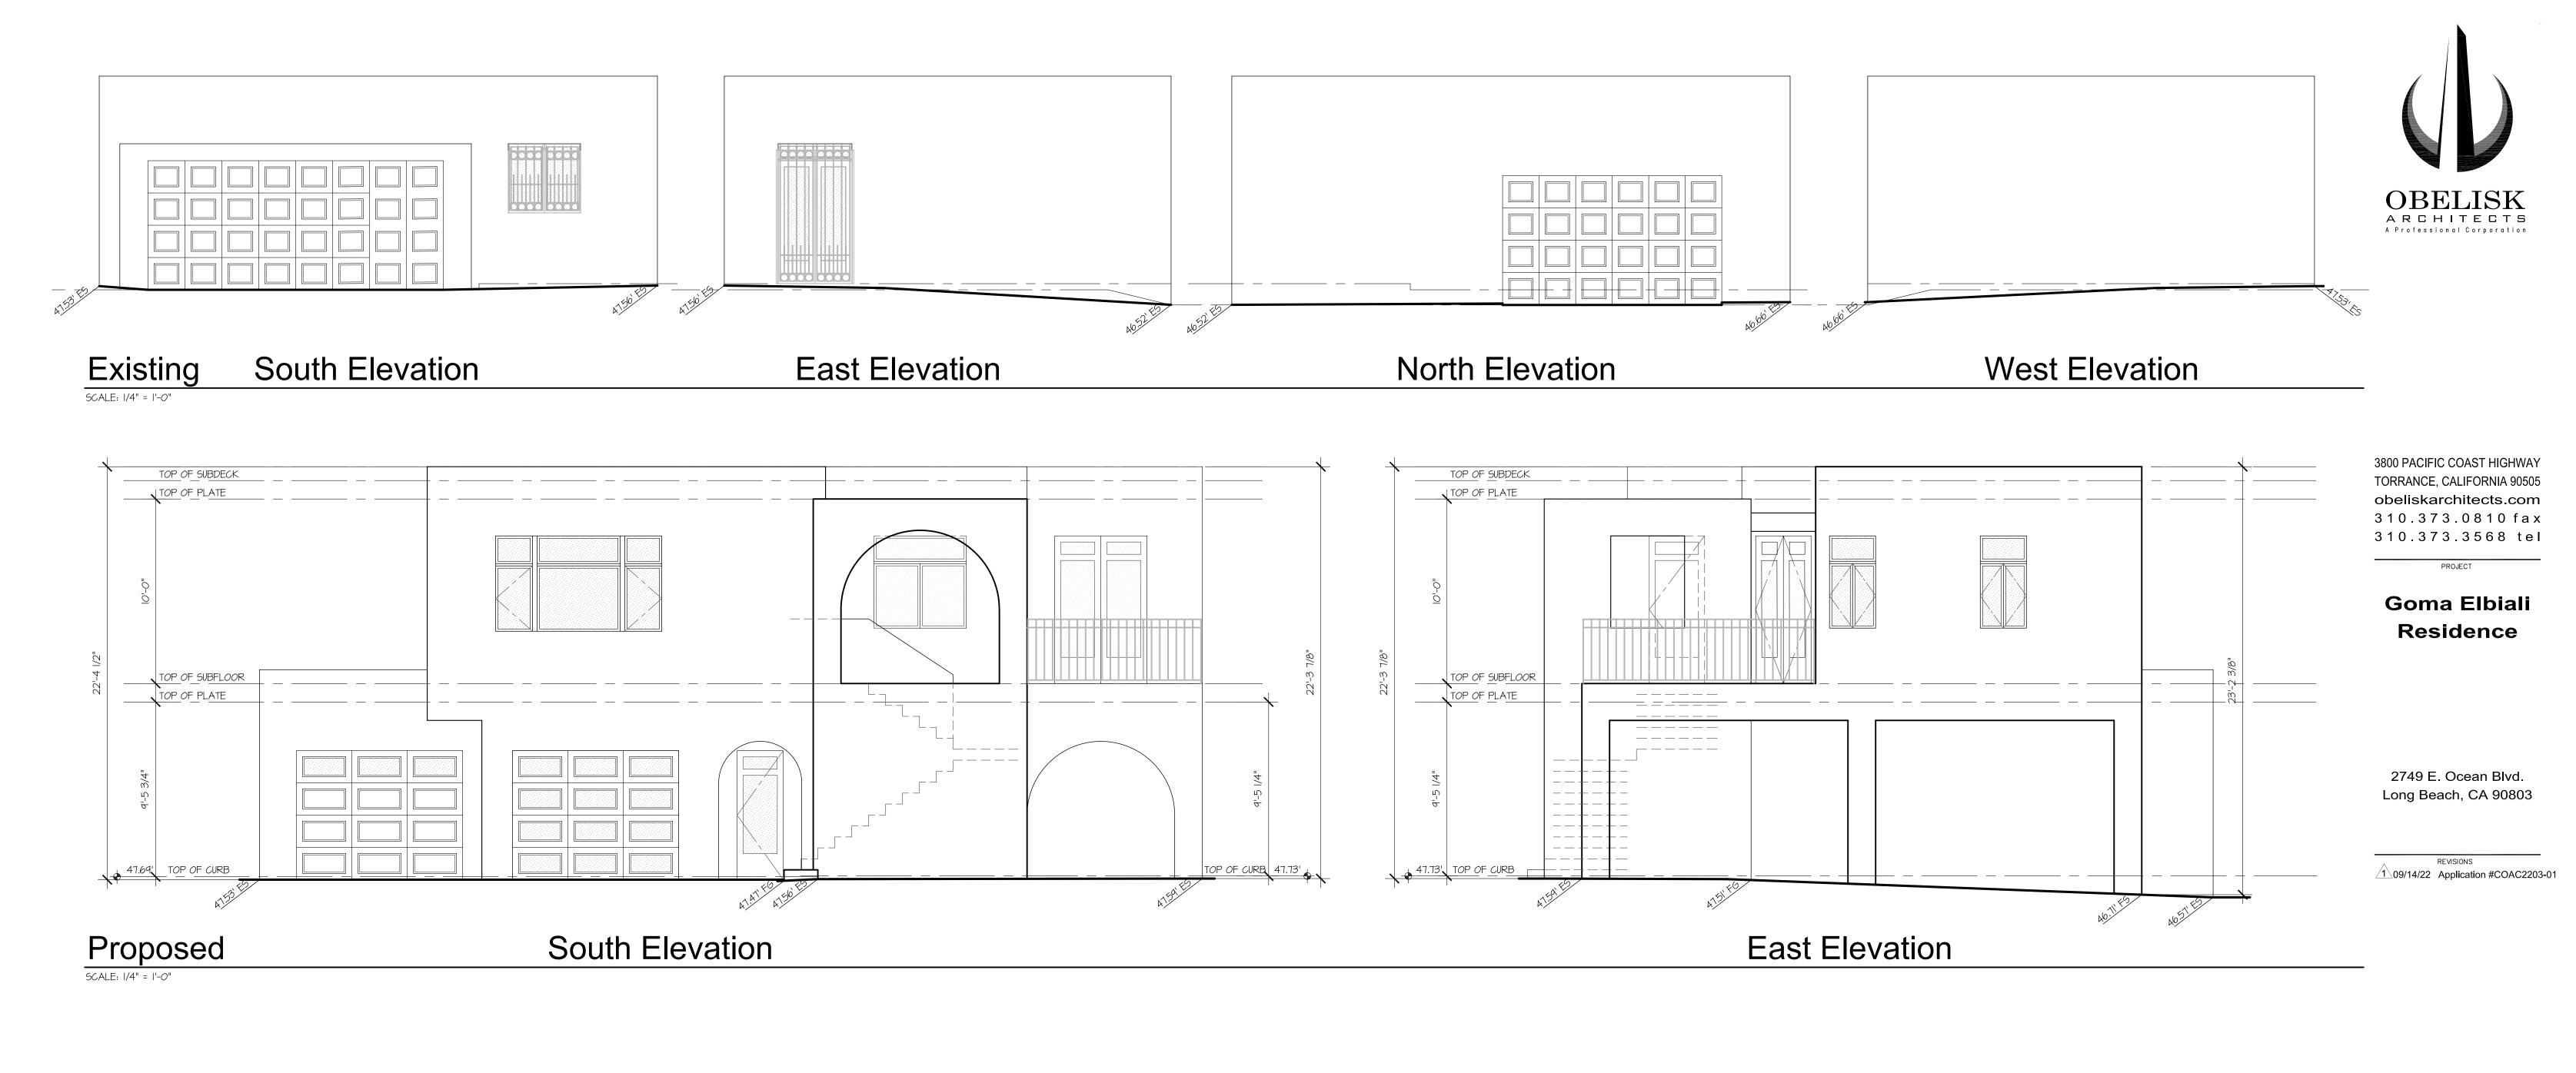



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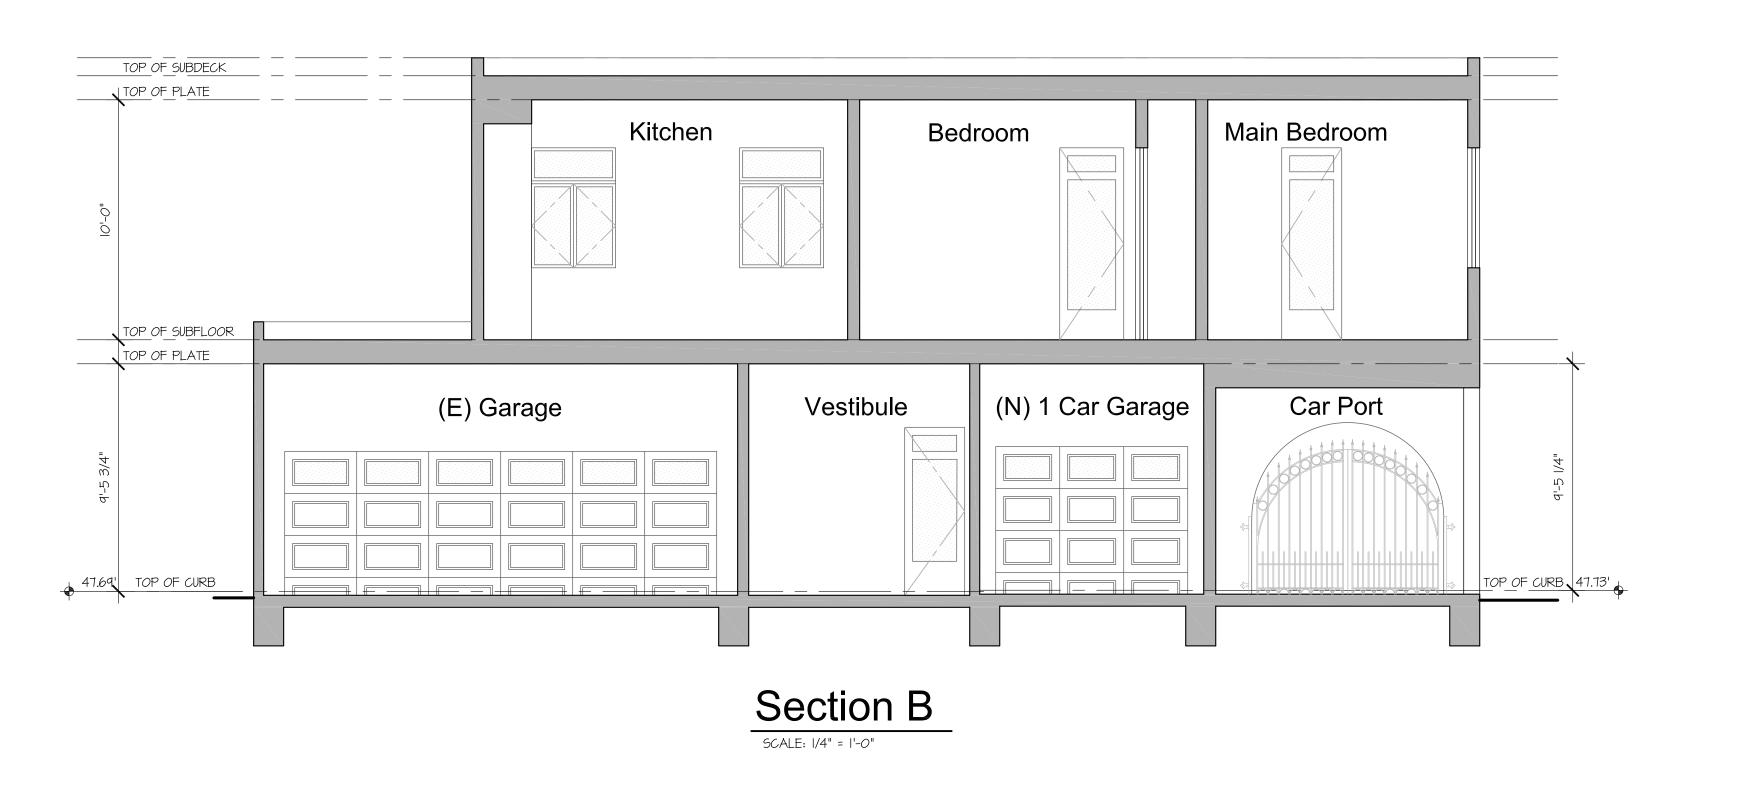
Historic Existing & Proposed Elevations









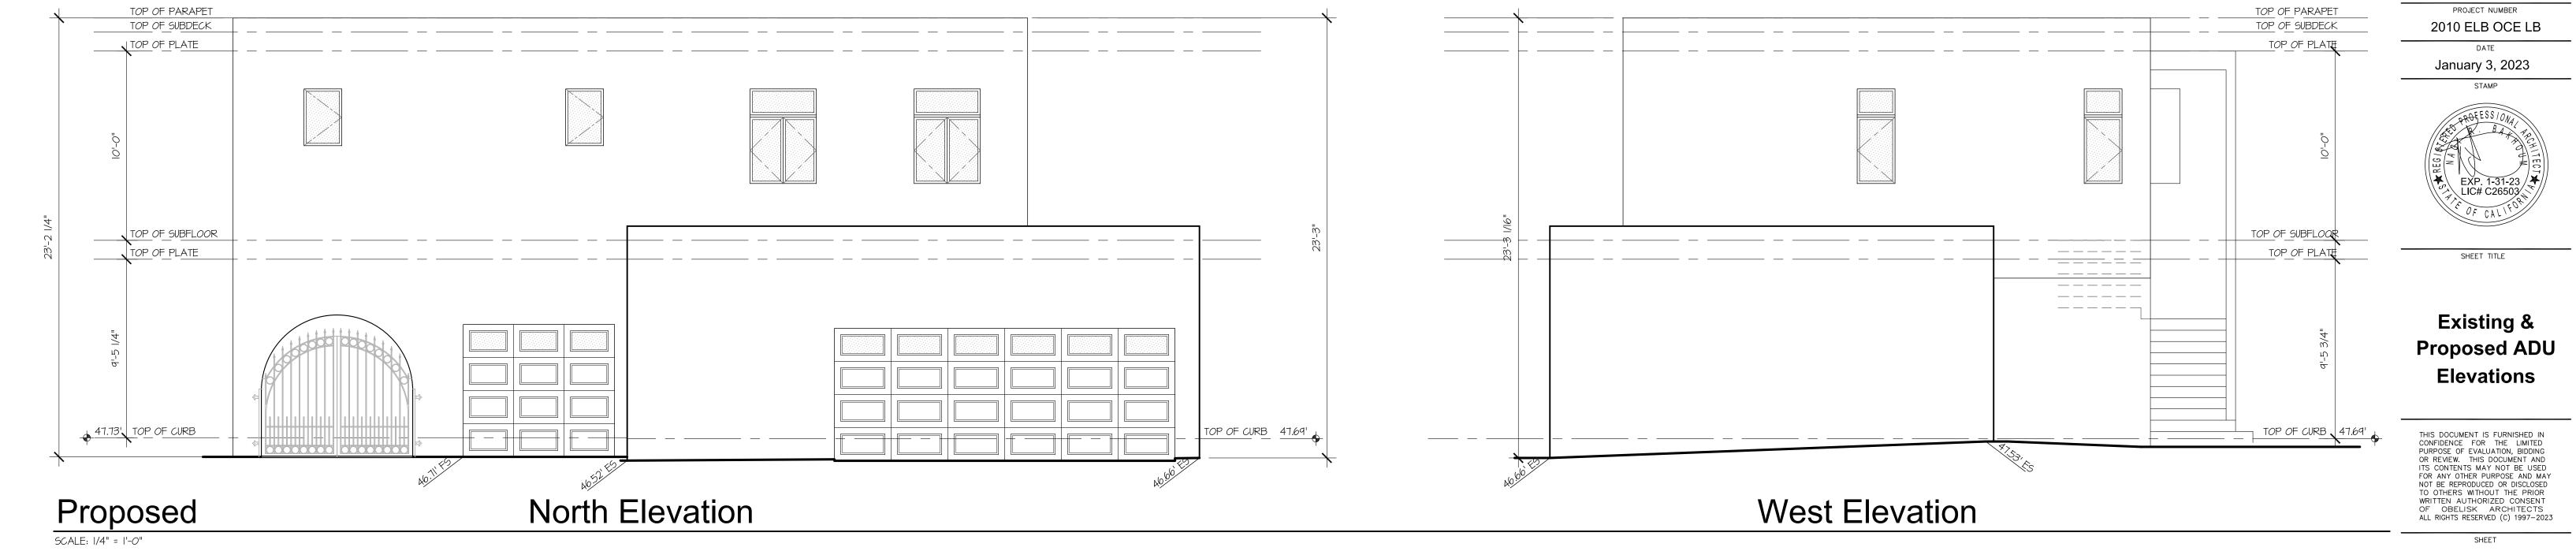




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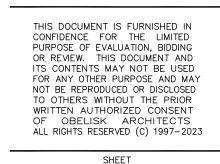
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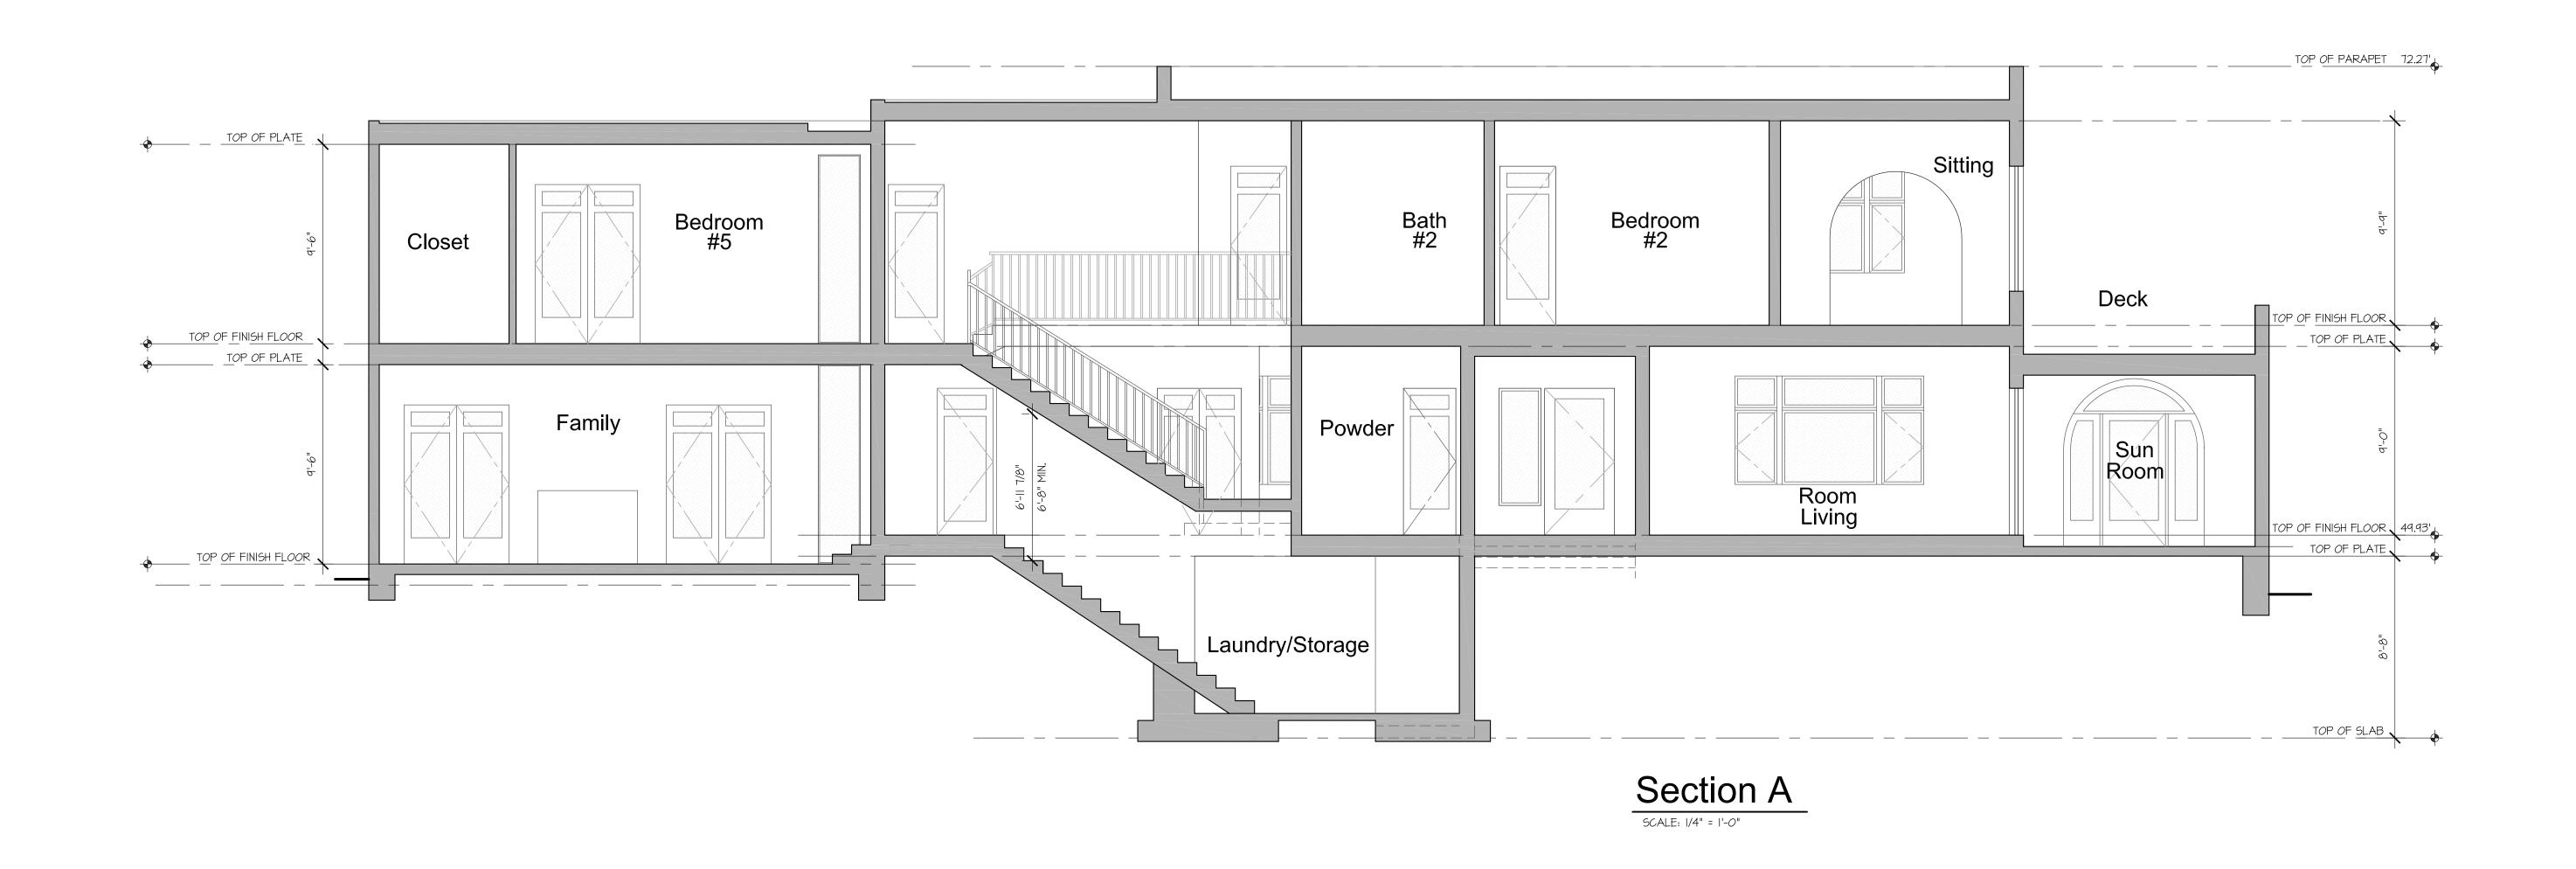
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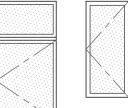





				Wi	ndow \$	HOUSE			
	Key	Width	Height	Туре	Material	Glazing	Head height from F.F.	U/SHGC	Remarks
		2'-0"	9'-6"	G	WOOD		9'-6"	0.32 / 0.23	FIXED
st FL	2	4'-0"	5'-2"	А	WOOD		7'-7"	0.32 / 0.23	TRANSOM / CASEMENT / CASEMENT
18	3	9'-0"	5'-2"	F	WOOD		7'-7"	0.32 / 0.23	TRANSOM / CASEMENT / FIXED/ CASEMENT
	4	2'-0"	9'-6"	G	WOOD		9'-6"	0.32 / 0.23	FIXED
	5	6'-8 1/2"	8'-0"	E	WOOD	TEMPERED	8'-0"	0.32 / 0.23	EMULATE DOOR & WINDOWS ON NEW LOCATION SIMILAR TO THE SUNROOM
	6	2'-0"	9'-0"	G	WOOD		9'-6"	0.32 / 0.23	FIXED
교	7	2'-6"	5'-0"	В	WOOD		7'-7"	0.32 / 0.23	TRANSOM / CASEMENT
2nd	8	3'-6.5"	2'-10"	D	WOOD		6'-9"		RELOCATED WINDOW FROM BATH #3
2	9	2'-0"	9'-0"	G	WOOD		9'-6"	0.32 / 0.23	FIXED
	10	3'-6.5"	4'-0"	С	WOOD		6'-9"		RELOCATED WINDOW FROM BEDROOM #4
	11	4'-0"	5'-2"	А	WOOD		7'-7"	0.32 / 0.23	REPLACE DOOR FOR TRANSOM / CASEMENT / CASEMENT WINDOW
oof	12	2'-0"	2'-0"						SKYLIGHT
8	13	2'-0"	2'-0"						SKYLIGHT
	14	2'-0"	3'-10"						SKYLIGHT

WINDOW TYPES

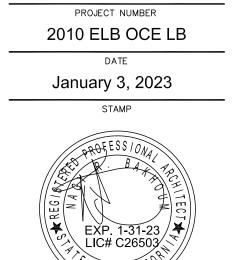





TYPE "B"

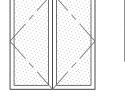


TYPE "C"

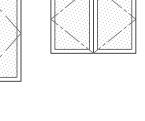

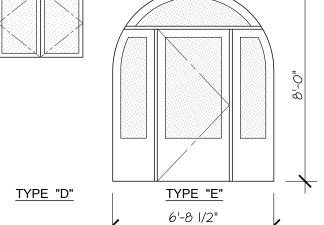

ALL WINDOWS TO MATCH EXISTING

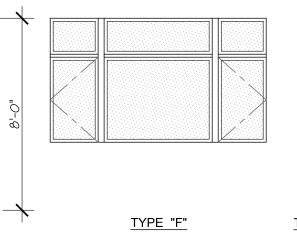


WINDOW NOTES:

- ALIGN TOP OF WINDOWS WITH TOP OF DOORS SO THAT TOP EDGES OF DOORS AND WINDOWS ALIGN
- IN A LEVEL PLANE ABOVE FINISH FLOOR. 2. EMERGENCY EGRESS WINDOW 20"x24" MIN. CLEAR OPENING, OPERABLE AREA 5.7 sq.ft. MIN. AND SILL HEIGHT 44" MAX.
- 3. WINDOWS WITH SILLS LESS THAN 5'-0" ABOVE TUB OR SHOWER FLOOR SHALL BE TEMPERED
- 4. ALL WINDOW GLAZING TO BE DUAL GLAZED, LOW "E" AND TINTED GLASS. CONTRACTOR TO PROVIDE TINTED GLASS SAMPLES TO ARCHITECT FOR SELECTION.
- 5. ALLEY FACING WINDOWS AND SLIDING GLASS DOORS SHALL CONSIST OF DUEL PANELS OF 1/8" - 1/4" GLASS TO MINIMIZE NOISE. TYPE "G" 6. COMPLY WITH SECT. 2406 FOR REQUIRED SAFETY
 - GLAZING 7. MANUFACTURER: MARVIN

Door schedule								HOUSE		
								ПООЗЕ		
	Key	Width	Height	Thick.	Type	Material	Glazing U/SI	HGC	Remarks	
FLOOR		PAIR 2'-6"	7'-7"	2 1/4"	В	STAIN GRADE WOOD	0.32 /	0.23		
	2	PAIR 2'-6"	7'-7"	2 1/4"	В	STAIN GRADE WOOD	0.32 /	0.23		
<u>-</u>	3	2'-6"	7'-0"	1 3/4"	А	STAIN GRADE WOOD	0.32 /	0.23		
st F	4	PAIR 2'-0"	7'-0"	1 3/4"	В	STAIN GRADE WOOD	0.32 /	0.23		
13	5	2'-8"	7'-0"	1 3/4"	А	STAIN GRADE WOOD	0.32 /	0.23	RELOCATED DOOR FROM OFFICE ROOM	
	6	2'-6"	7'-7"	1 3/4"	А	STAIN GRADE WOOD	0.32 /	0.23		
	7	2'-6"	7'-7"	1 3/4"	А	STAIN GRADE WOOD	0.32 /	0.23		
	8	PAIR 2'-6"	7'-7"	2 1/4"	В	STAIN GRADE WOOD	0.32 /	0.23		
	9	2'-8"	7'-7"	1 3/4"	А	STAIN GRADE WOOD	0.32 /	0.23		
	10	2'-8"	7'-7"	1 3/4"	А	STAIN GRADE WOOD	0.32 /	0.23		
	11	PAIR 2'-6"	7'-7"	1 3/4"	В	STAIN GRADE WOOD	0.32 /	0.23	BY PASS	
)R	12	2'-6"	7'-7"	1 3/4"	А	STAIN GRADE WOOD	0.32 /	0.23		
00	13	2'-6"	7'-7"	1 3/4"	А	STAIN GRADE WOOD	0.32 /	0.23		
FLOOR	14	2'-8"	7'-7"	1 3/4"	А	STAIN GRADE WOOD	0.32 /	0.23		
2nd	15	2'-6"	7'-7"	1 3/4"	А	STAIN GRADE WOOD	0.32 /	0.23		
2r	16	2'-0"	7'-7"	1 3/4"	А	STAIN GRADE WOOD	0.32 /	0.23		
	17	PAIR 2'-6"	7'-7"	1 3/4"	В	STAIN GRADE WOOD	0.32 /	0.23	BY PASS	
	18	2'-6"	7'-7"	1 3/4"	А	STAIN GRADE WOOD	0.32 /	0.23		
	19	2'-8"	7'-7"	1 3/4"	А	STAIN GRADE WOOD	0.32 /	0.23		
	20	2'-8"	7'-7"	1 3/4"	А	STAIN GRADE WOOD	0.32 /	0.23		
	21	2'-6"	7'-7"	1 3/4"	А	STAIN GRADE WOOD	0.32 /	0.23		
4		I			1					


DOOR TYPES ALL DOORS TO MATCH EXISTING

7'-7"

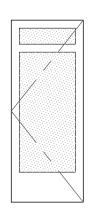

22

2'-6"

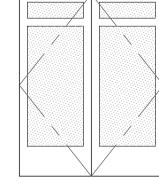

TYPE "A" TYPE "B"

STAIN GRADE WOOD

1. ALL DOORS TO BE SOLID CORE WOOD HAVING STILES AND RAILS NOT LESS THAN 1-3/8 INCH THICK WITH INTERIOR PANEL


0.32 / 0.23


- THICKNESS NOT LESS THAN 1-1/4 INCH THICK.
- 2. BOTTOM OF INTERIOR DOORS TO BE 3/8" ABOVE FIN. FLR. 3. PROVIDE DEAD BOLTS WITH HARDENED INSERTS, DEADLOCKING LATCH WITH KEY-OPERATED LOCKS ON EXTERIOR. LOCKS MUST BE OPENABLE FROM INSIDE WITHOUT KEY, SPECIAL KNOWLEDGE OR SPECIAL EFFORT (LATCH NOT REQUIRED IN B, F, AND S OCCUPANCIES. 91.6709.2)
- 4. EGRESS DOORS SHALL BE READILY OPEN FROM THE EGRESS SIDE WITHOUT THE USE OF A KEY OR ANY SPECIAL
- KNOWLEDGE OR EFFORT. BUILDING CODE 1008.1.8
- 5. VEHICLE ACCESS DOORS SHALL BE NONCOMBUSTIBLE.
- 6. EVERY DOOR SHALL HAVE A LEVEL LANDING ON EACH SIDE. THRESHOLDS AT DOORWAYS SHALL NOT EXCEED 0.75" FOR SLIDING DOORS OR 0.5" FOR OTHER DOORS. THE THRESHOLD MAY BE 7.75" MAXIMUM WHEN THE DOOR IS AN EXTERIOR DOOR THAT IS NOT A COMPONENT OF THE REQUIRED MEANS OF EGRESS AND THE DOOR DOES NOT SWING OVER THE LANDING. EXTERIOR DOORS SHALL HAVE A CONCRETE LANDING (36"X36" MIN.) WITH A MINIMUM SLOPE OF $\frac{1}{4}$ " PER FOOT FOR DRAINAGE. DETAIL LANDING AND THRESHOLD DROP AT DOORS. [CBC 1008.1.4, 1008.1.6]
- 7. MANUFACTURER: MARVIN


				Wi	ndow \$	ADU				
	Key	Width	Height	Type	Material	Glazing		Head height from F.F.	U/SHGC	Remarks
		3'-6"	5'-0"	А	WOOD	OBSCURED		8'-0"	0.32 / 0.23	TRANSOM / CASEMENT / CASEMENT
	2	3'-6"	5'-0"	Α	WOOD	OBSCURED		8'-0"	0.32 / 0.23	TRANSOM / CASEMENT / CASEMENT
	3	2'-0"	3'-0"	В	WOOD	OBSCURED	TEMPERED	8'-0"	0.32 / 0.23	CASEMENT
ADU	4	2'-0"	3'-0"	В	WOOD	OBSCURED	TEMPERED	8'-0"	0.32 / 0.23	CASEMENT
	5	2'-6"	5'-0"	Α	WOOD	OBSCURED		8'-0"	0.32 / 0.23	TRANSOM / CASEMENT / CASEMENT
OOR	6	2'-6"	5'-0"	Α	WOOD	OBSCURED		8'-0"	0.32 / 0.23	TRANSOM / CASEMENT / CASEMENT
FL(7	5'-0"	5'-0"	Α	WOOD			8'-0"	0.32 / 0.23	TRANSOM / CASEMENT / CASEMENT
	8	9'-0"	5'-2"	D	WOOD			8'-0"	0.32 / 0.23	TRANSOM / CASEMENT / FIXED/ CASEMENT
2nd	9	2'-0"	5'-0"	С	WOOD	OBSCURED		8'-0"	0.32 / 0.23	TRANSOM / CASEMENT
	10	2'-0"	5'-0"	С	WOOD	OBSCURED		8'-0"	0.32 / 0.23	TRANSOM / CASEMENT

ALL WINDOWS TO MATCH EXISTING

WINDOW TYPES

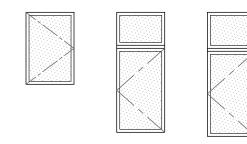

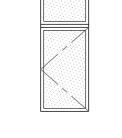

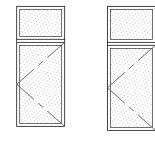



TYPE "D" TYPE "C"

- 1. ALIGN TOP OF WINDOWS WITH TOP OF DOORS SO THAT TOP EDGES OF DOORS AND WINDOWS ALIGN IN A LEVEL PLANE ABOVE FINISH FLOOR.
- 2. EMERGENCY EGRESS WINDOW 20"x24" MIN. CLEAR OPENING, OPERABLE AREA 5.7 sq.ft. MIN. AND SILL HEIGHT 44" MAX.
- 3. WINDOWS WITH SILLS LESS THAN 5'-0" ABOVE TUB OR SHOWER FLOOR SHALL BE
- 4. ALL WINDOW GLAZING TO BE DUAL GLAZED, LOW "E" AND TINTED GLASS. CONTRACTOR
- TO PROVIDE TINTED GLASS SAMPLES TO ARCHITECT FOR SELECTION. 5. ALLEY FACING WINDOWS AND SLIDING GLASS DOORS SHALL CONSIST OF DUEL PANELS OF 1/8" - 1/4" GLASS TO MINIMIZE NOISE.
- 6. COMPLY WITH SECT. 2406 FOR REQUIRED SAFETY GLAZING
- 7. MANUFACTURER: MARVIN

						Door oo	hodul			
						Door sc	nedu	ie	GARAGE / ADU	
	Key	Width	Height	Thick.	Туре	Material	Glazing	U/SHGC	Remarks	
FLOOR		18'-0"	7'-0"	2 1/4"	С	ALUMINUM			ROLL-UP SECTIONAL GARAGE DOOR. PROVIDE AUTOMATIC OPENER W/ 2 HOUR BATTERY BACK UP PER CODE	
	2	8'-0"	7'-0"	2 1/4"	D	ALUMINUM			ROLL-UP SECTIONAL GARAGE DOOR. PROVIDE AUTOMATIC OPENER W/ 2 HOUR BATTERY BACK UP PER CODE	
١	3	3'-0"	7'-0"	2 1/4"	A	STAIN GRADE WOOD		0.32 / 0.23		
1st F	4	2'-8"	7'-0"	2 1/4"	А	STAIN GRADE WOOD		0.32 / 0.23	20 MINUTE RATED w/ AUTOMATIC CLOSER, SELF LATCHING, WEATHER STRIPPING & METAL THRESHOLD	
	5	2'-6"	7'-0"	2 1/4"	A	STAIN GRADE WOOD		0.32 / 0.23		
	6	2'-8"	7'-0"	2 1/4"	А	STAIN GRADE WOOD		0.32 / 0.23	20 MINUTE RATED w/ AUTOMATIC CLOSER, SELF LATCHING, WEATHER STRIPPING & METAL THRESHOLD	
	7	9'-0"	7'-0"	2 1/4"	Е	ALUMINUM			ROLL-UP SECTIONAL GARAGE DOOR. PROVIDE AUTOMATIC OPENER W/ 2 HOUR BATTERY BACK UP PER CODE	
	8	9'-0"	7'-0"	2 1/4"	D	ALUMINUM			ROLL-UP SECTIONAL GARAGE DOOR. PROVIDE AUTOMATIC OPENER W/ 2 HOUR BATTERY BACK UP PER CODE	
	9									
4DU	10	PAIR 1'-6"	8'-0"	1 3/4"	В	STAIN GRADE WOOD		0.32 / 0.23		
	11	2'-6"	8'-0"	1 3/4"	А	STAIN GRADE WOOD		0.32 / 0.23		
	12	3'-0"	8'-0"	1 3/4"	А	STAIN GRADE WOOD		0.32 / 0.23		
ן ר	13	2'-6"	8'-0"	1 3/4"	A	STAIN GRADE WOOD		0.32 / 0.23		

0.32 / 0.23

0.32 / 0.23

0.32 / 0.23


0.32 / 0.23

0.32 / 0.23

0.32 / 0.23

DOOR TYPES

TYPE "A"

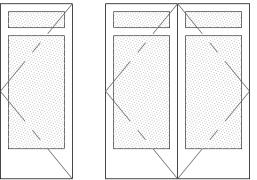

2'-6"

15 |PAIR 2'-6"

16 |PAIR 1'-6"

PAIR 3'-0"

2'-8"

3'-0"

8'-0"


8'-0"


8'-0"

8'-0"


8'-0"

8'-0"

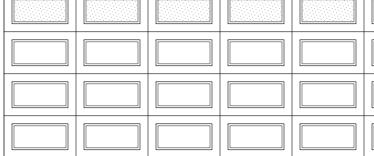

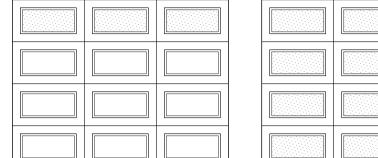

TYPE "D"

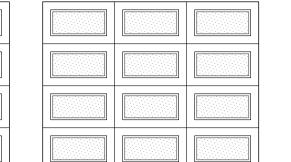

SHEET TITLE

OBELISK

A Professional Corporation

3800 PACIFIC COAST HIGHWAY

TORRANCE, CALIFORNIA 90505

obeliskarchitects.com

310.373.0810 fax

310.373.3568 tel

PROJECT

Goma Elbiali

Residence

2749 E. Ocean Blvd. Long Beach, CA 90803


REVISIONS 1\09/14/22 Application #COAC2203-01

PROJECT NUMBER

2010 ELB OCE LB

January 3, 2023

Door & **Schedules**

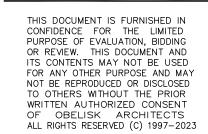



1 3/4"

1 3/4"


1 3/4"


1 3/4"

1 3/4"

2 1/4"

STAIN GRADE WOOD

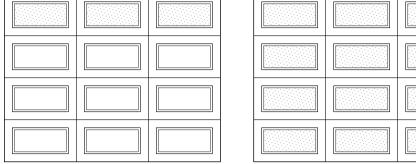

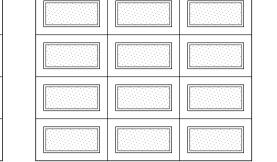

TYPE "E"

1. ALL DOORS TO BE SOLID CORE WOOD HAVING STILES AND RAILS NOT LESS THAN 1-3/8 INCH THICK WITH INTERIOR PANEL THICKNESS NOT LESS THAN 1-1/4 INCH THICK.

TYPE "C"

2. BOTTOM OF INTERIOR DOORS TO BE 3/8" ABOVE FIN. FLR. 3. PROVIDE DEAD BOLTS WITH HARDENED INSERTS, DEADLOCKING LATCH WITH KEY-OPERATED LOCKS ON EXTERIOR. LOCKS MUST BE OPENABLE FROM INSIDE WITHOUT KEY, SPECIAL KNOWLEDGE OR SPECIAL EFFORT (LATCH NOT REQUIRED IN B, F, AND S OCCUPANCIES. 91.6709.2)

4. EGRESS DOORS SHALL BE READILY OPEN FROM THE EGRESS SIDE WITHOUT THE USE OF A KEY OR ANY SPECIAL KNOWLEDGE OR EFFORT. BUILDING CODE 1008.1.8

5. VEHICLE ACCESS DOORS SHALL BE NONCOMBUSTIBLE.

TYPE "B"

6. EVERY DOOR SHALL HAVE A LEVEL LANDING ON EACH SIDE. THRESHOLDS AT DOORWAYS SHALL NOT EXCEED 0.75" FOR SLIDING DOORS OR 0.5" FOR OTHER DOORS. THE THRESHOLD MAY BE 7.75" MAXIMUM WHEN THE DOOR IS AN EXTERIOR DOOR THAT IS NOT A COMPONENT OF THE REQUIRED MEANS OF EGRESS AND THE DOOR DOES NOT SWING OVER THE LANDING. EXTERIOR DOORS SHALL HAVE A CONCRETE LANDING (36"X36" MIN.) WITH A MINIMUM SLOPE OF 1/4" PER FOOT FOR DRAINAGE. DETAIL LANDING AND THRESHOLD DROP AT

DOORS. [CBC 1008.1.4, 1008.1.6] 7. MANUFACTURER: MARVIN