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LEGAL DESCRIPTION:

LOT 15, BLK 46: RESUBDIVISION OF ALAMITOS TOWNSITE (BEACH) ASSESSOR'S PARCEL NO: 7264-024-016

LOT SIZE: 11,000 SF

EXISTING HOUSE:	
FIRST FLOOR:	1824 S
SECOND FLOOR:	1572 S
TOTAL HABITABLE	3396 9
EXISTING HOUSE DECK	230 S
EXISTING GARAGE TO BE DEMOLISHED	1013 S
PROPOSED FIRST FLOOR OF SED:	1203 S
PROPOSED SECOND FLOOR OF SFD:	1812 5
TOTAL HABITABLE AT PROPOSED DWELLING	3015 S
PROPOSED NEW GARAGE	1100 S
DRODOSED NEW DECKS	406.9

OPEN SPACE CALCULATION:	
NEW DWELLING DECKS	406 SF
EXISTING MAIN HOUSE DECK	230 SF
EXISTING MAIN HOUSE PATIO	180 SF
CENTER COURTYARD BETWEEN DWELLINGS	1898 SF
TOTAL OPEN SPACE PROVIDED OPEN SPACE REQUIRED 16% (SFD)	2714 SF 1760 SF

SCOPE OF WORK:

DEMOLISH EXISTING GARAGE AND BUILD NEW TWO-STORY DWELLING UNIT, AND NEW 1100 SF GARAGE

| MAXIMUM LOT COVERAGE: 40% OF LOT SIZE 11,000 =4400 SF LOT COVERAGE PROVIDED: 1824 SF FIRST FLOOR (e) MAIN HOUSE 1824 SF FIRST FLOOR OF PROPOSED SFD 1203 SF PROPOSED GARAGE 1100 SF TOTAL LOT COVERAGE 4127 SF

NON-PERMEABLE CALCULATION: 30% OF LOT SIZE 11,000 = 3300 SF NON-PERMEABLE PROVIDED: 6207 SF EXISTING MAIN HOUSE FIRST LOOP. 1824 SF PROPOSED GARAGE 1100 SF PROF TLOOP OF PROPOSED SFD 1203 SF MAIN HOUSE (e) COVERED PATIO 686 SF 4795 SF

11.000-4793 = 6207 SF

CONTACT INFORMATION:

PROJECT COORDINATOR: SUNBEAM BUILDERS 500BEAM BUILDERS 659 S. STATE COLLEGE BLVD. UNIT 45 FULLERTON, CA 92831 714.234.9497 REP: MICHAEL TALIN

ARCHITECT: OTIS ARCHITECTURE + INTERIORS 16845 E. AVENUE OF THE FOUNTAINS #107 FOUNTAIN HILLS, AZ 85268 714.846.0177 REP: KAREN (OTIS) WEBB, ARCHITECT

STRUCTURAL ENGINEER: CASTILLO ENGINEERING 1205 PINE STREET #201 LONG BEACH, CA 90813 562.961.5600 REP: MARGARITO CASTILLO

CIVIL ENGINEER:

OWNER: PETER AND SUE SIRISUT 2725 E. OCEAN BLVD. LONG BEACH, CA 90803 REP: DIANE SIRISUT 562.987.2932

TITLE 24 ENERGY CONSULTANT:

Project Architect: K. Otis Drawn:

Sheet Number:

Α1

DIVISION 1 - GENERAL REQUIREMENTS:

1-A. ARCHITECT'S STATUS:

The Architect does not augrantee the Contractor's performance, and no provisions of the contract documents shall relieve the Contractor from any liability due to negligence, incompetence or errors of omissions or commission of the Contractor.

The drawings and specifications represent the finished structure. The design adequacy and safety of erection, bracing, shoring, temporary supports, etc. is the sole responsibility of the Contractor, and has not been considered by the Architect or the Structural Engineer. The contractor is responsible for the stability of the structure prior to the application of all shear wall, roof and floor diaphragms and finished materials. He should provide the necessary bracing to provide stability prior to the application of the atorementioned materials.

Observation visits to the job site by the Architect do not include inspection of construction procedures. The Contractor is solely responsible for all constituction methods and for safety conditions at the worksite. These visits shall not be construed as continuous and detailed inspections.

Design, materials, equipment and products other than these described below or indicated on the drawings may be considered for use, provided prior approval is obtained from the Architect and applicable governing code authority.

On site verification of all dimensions and conditions shall be the responsibility of the Contractor, Written dimensions shall take precedence over scaled dimensions, existing dimensions take precedence over written dimensions.

All codes having jurisdiction shall be observed strictly in the construction of the project including all applicable state, city, and county building, zoning, electrical mechanical, plumbing and fire codes. The Contractor shall verify all code requirements before the commencement of construction and bring any discrepancies between code requirements and the construction documents to the attention of the

1-C. ERRORS AND OMISSIONS:

The tentors and unastions: from, omissions, or conflicts which may occur in Construction Documents shall be brought to the attention of the Architect in writing and written instructions shall be obtained before proceeding with the work. The Contractor will be held responsible for the result of any errors, discrepancies, or omissions of which the Contractor failed to notify the Architect before construction and/or fabrication of the work

1-D JOB CONDITIONS

The Contractor and Subcontractor shall verify all dimensions and job conditions at the job sufficiently in advance of work to be performed to assure the orderly progress of the work. The Architect shall be notified of any discrepancy.

DIVISION 2 - SITE WORK

Contractor to complete all demolition work as shown on the drawings. Cap, terminate and reconnect plumbing and electrical utilities impacted by demotifion work. Execute all demotition work in an orderly manner with due consideration for any existing structures, including any parts of the surrounding area which are to remain. Barricade and cover as necessary to protect pedestrians, workmen, and adjacent properties. Protect any existing active service lines, indicated or not. Back fill any trenches caused by demolflion work. Contractor to maintain cleanliness and security on site.

2-B SOILS AND FOUNDATION:

Perform all work in this section in conformance with the soils figures and/or reports approved by the Building Department. The location of and protection of all utilities is the Contractor's responsibility.

DIVISION 3 - CONCRETE

It shall be the responsibility of the Contractor to locate all existing utilities whether shown hereon or not and to protect them from damage. The contractor shall bear all expense of repair or replacement in conjunction with the prosecution of this work.

Localion of construction or pour joints must be approved by the Structural Engineer. All pipes or ducts through concrete shall be sleeved. Pipes or ducts exceeding one third the slab or wall thickness shall not be place detailed by Structural Engineer. Foundation below ground shall be made waterlight and damp proof. Refer to structural drawings for details and specifications.

3-B WORKMANSHIP:

All work shall comply with the requirements set forth in the "Manual of Standard Practice for Detailing Reinforced Concrete Structures," published by the American Concrete Institute except where more exacting requirements are specified in the Construction Documents.

- All bending of reinforced steet shall conform to the latest edition of the international Building Code.
 Anchor Bolts shall be manufactured of ASTM A307 steet and placed per Engineer's

4-A. GENERAL:

Provide labor, materials, equipment, and other services to complete masonry where indicated on drawings. Walls shall be straight, plumb, and true, with all courses true to line and level, to dimension shown, Cells shall be filled solid with arout as indicated, Blocks shall be laid up with waterproof Type M or S mortar. Clean units before replacing. Use masonry saw for cutting.

DIVISION 5 - METALS

All work shall comply with A.I.S.C. Manual of Steel Construction, latest edition. Welding to be done per American Welding Society Structural Weld Code, All field welding shall be performed by a county or city approved welder and inspected and approved by a deputy inspector.

5-B MISCELLANEOUS ITEMS:

Miscellaneous metal items and their related components are not necessarily individually described. The most important and those requiring detailed description are inflaviously described. The most important and mose requiring defauled description specified. Miscellaneous items not described shall be furnished and installed in accordance with the intent of the drawings and specifications and as required to complete work. Shop drawings to be submitted for Architect's approval prior to

DIVISION 4 - WOOD

6-A. ROUGH CARPENTRY:

6-A. NOUGH CARTENINT: 1. All structured lumber shall be grade marked and conform with the standard grading and dressing rules of the Western Wood Products Association.
2. All wood resting on concrete or within 6 inches of flinish grade shall be pressure

treated Doualas Fir. Fireblocking: Fire block stud walls and partitions (including turred spaces) at the floor. ceiling, soffit, and at mid-height of walls over 0".0" in height.

4. Roof Sheathing: 1/2"CDX Plywood Index 3224 PS 1-95. Nail with 10d nail at 6" OC at

intermediate supports. Lay panels with face grain across supports. Stagger panel joints. Nailing shall be inspected prior to covering.
5. Blocking: Provide 2X solid blocking between joist or rafters at all supports.
6. Wood Insses: It shall be the responsibility of the manufacturer to obtain Building Department approval of Calculations and shop drawings prior to fabrication. The manufacturer shall be an Approved Fabricator, as currently listed by ICBO. Trusses shall be designed in accordance with the latest Building Code for all loads imposed,

including lateral loads and mechanical equipment loads. 7. New subfloor to be 1-1/8"plywood unless remadel condition does not permit

Manufacture millwork and casework per Manual of Millwork Institute of California custom grade unless noted otherwise. Install all shelving, casework, millwork, doors, hardware, railing, tirm, counters, utility backboards and other finish carpentry. All maple cabinets and surfaces to be sealed prior to stain or color lacquer in order to prevent irregular color absorption into wood.

- 3/4" Solid wood (see plans for wood specification)
- 2. Melamine cabinet interior
- Concealed European hinges 5mm holes at sides of cabinets for adjustable shelves.

- 9. Pyp maple at drawers with Lock joints and European side guides.
 Melamine and aider at pull-out trays with European side guides.
 Alder Interior pull-out trash tray with drop-in 32 qt, trash can pull extension guides.

Cabinet fabricator to submit shop drawings prior to fabrication. Verify all dimensions

DIVISION 7 - THERMAL AND MOISTURE PROTECTION

7-A ROOFING

nall be installed per CBC and in accordance with the manufacturer's listing. Refer plans for manufacturer.

7-B SHEET METAL.

Verify all dimensions shown on drawings by taking field measurements; proper fit and attachment on all parts is required. All work included in this section shall be performed Graculture of the state of the

Shall be provided and installed per Title 24, California Administrative Code, Dwelling units shall receive a minimum of R19 blanket insulation at roots and R11 at walls. Unless noted otherwise, provide thermal insulation in all exterior and interior stud walls and ceilings, extending full height of walls, fitted tightly between studs.

DIVISION 8 - DOORS AND WINDOWS

8-A. WOOD DOORS:

All doors shall comply with the requirements of the woodwork Institute of California, standard grade (CBC): Title 24, California Administrative Code.

8-B. DOORS AND WINDOWS:

All exterior windows and glass door shall comply with T-24 calculations: Refer to T-24 Report, Finish per owner's specifications, Caulk at exterior, Provide aluminum framed fiberglass screen at each open vent. Glazing shall be sized per U.B.C. Tempered glass shall be installed when required by CBC

Exterior doors and their hardware shall conform to the security provisions of the applicable chapter of CBC and local city codes.
 All exterior doors and lower leaf of Dutch door shall have dead bolt and dead

locking latch, both key operated from the outside, Deadbotts shall have a hardened insert with 1" min, throw and 5/8" min, embedment into jamb, Inactive leaf shall have flushbotts top and bottom with 1/2" embedment exterior door hinge pins

Overhead and sliding doors shall be secured with a cylinder lock padlock with hardened steel shackle or slide bolt.

DIVISION 9 - FINISHES

9-A. GYPSUM DRYWALL CONSTRUCTION:

Scope: Furnish and install all gypsum wallboard work complete.
 Standards:

a.All work and materials shall comply with the applicable chapter of CBC. b.All work and materials shall comply with American Standard Association's Specification for Gypsum Wallboard Finishes".

- a.5/8" gypsum wallboard typical throughout
- a.3/e gypsum wallboard "greenboard" typical at all plumbing walls.
 c.Tape and Compound: As recommended by gypsum board Manufacturer.
 d.Attachments Screw attachments per code.
 4. Installation: Installation and finishing shall conform to American Standard A97.165
- and as specified herein: a.Wallboard: Apply wallboard first to ceilings and then to walls, horizontally. Use
- board of maximum practical lengths and stagger end joints. Apply metal edge trim to all exposed gypsum board edges and outside comers. b.Finishing: Tape and finish joints, comers and edges in accordance with Manufacture's recommendations. Leave surfaces smooth, free of visible joints, nail
- holes and sanding marks. c Finish Textures: Smooth no texture-feather all joints with special care
- d. All Slate and/or Stone: Clean and seal prior to grouting.

1. Reference Specifications: Lathing materials and their application and plaster materials and their application shall be in strict accordance with the applicable sections for Lathing, Furring and Plastering of the National Gypsum Association. 2. Building Paper: Install Type 15 felt or other approved. Under exterior trim and siding apply so as to form a watertight membrane. Overlap each course below 2 inches minimum horizontal joints and 6 inches minimum at vertical joints. 3. Flashing at Wall Penetrolions: Install isladikraft paper as flashing in a weatherboard fashion. Slip window under horizontal head sisalkraft and secure metal window and door fin over sealant on interface of fins at side and bottom. Note: Provide a bead of Butyl sealant on interface of fins at side and bottom, also exterior face of top fin. before inserting metal frames.

9-C. PAINTING

1. Application of paint or other coating shall be in strict accordance with manufacture's directions. Ready-mixed paint shall not be thinned, except as permitted

- in the application instructions. 2. Top and bottom of all doors to be sealed and painted. 3. All surfaces to be finished shall be clean and free of foreign materials (dirt. grease.
- asphalt, rust, etc.) aspirati, rust, etc.)

 A. Application shall be in a workmanlike manner providing a smooth surface.

 Application rote shall be that recommended by the manufacturer. Application may be by brush or roller or by spray if paint is formulated for spray application.
- be dy unso for foliat or usy spruy plants i amoniated in spray deputication.

 5. All stucco finish to be painted with elastomeric paint or equivalent.

 6. Exterior wood to be properly flashed and catalled, and all nindl and staple holes filled.

 7. All exposed paint grade wood to have 2 coats of primer and 2 coats of acrylic paint finish unless otherwise specified. All stain grade wood to be filled, sanded, and sealed with specified stain and finish. All interior wood to be sprayed, all other rolled or
- 8. All metal surfaces and joints to be sealed prior to paint. All exposed metal to be properly primed with red-oxide. Apply 2 coats of paint and 1 coat of clear sealer

DIVISION 11 - EQUIPMENT (APPLIANCES)

11-A. MEASUREMENTS:

Verify all dimensions shown on the Drawings by taking field measurements; proper fil and attachment of all parts is required. Notify Architect if any discrepancies appear.

DIVISION 15 - MECHANICAL:

1. Rules and Regulations: All work and materials shall be in full accordance with the 1. Notes and regiptations. At work that indentities shall be in ord-declarate with mell latest federal, state, and local codes and regulations. Nothing in these plans or specifications shall be construed to permit work not conforming to these codes. 2. Materials and Equipment: Ducthows shall comply with the miliminum weight standards as set forth in the California Building Code and the return ducts shall be galvanized sheet metal. Ducts and fittings shall be insulated with fiberglass. Provide automatic fire dampers where required.

 Fabrication and Installation: Furnace closets shall be sized to provide per CBC clearances from furnace unit at sides, front, rear, and other requirements per CBC and

15-B. VENTILATION:

. Rules and Regulations: All work and materials shall be in full accordance with the

latest CBC and local codes.

2. Materials and Equipment: Provide mechanical exhaust ventilation, five air changes per hour for bathrooms containing a bathtub or shower or combination thereof, laundry rooms and similar rooms. Two air changes per hour are required in all guest rooms, habitable rooms and public corridors. Bathrooms which contain only a watercloset or lavatory or combination thereof may be ventilated with an approved mechanical recirculating fan or similar device designed to remove odors. 15-C. PLUMBING:

In Copper to Steel Connections: All copper pipe connections to ferrous piping shall be made with dielectric coupling or isolation flanges. All waste lines between floors to be

- Waste and Vent Systems: All soil, waste, and vent piping shall be approved ABS or 2. A value and verify sylvaphens. Autobit water all constructions are deproved that of the value of the verifying sylvaphens are equipment of the value of value of the value of value of the value of the value of valu be cast iron for noise abatement.
- Domestic Water Piping System: All water supply lines shall be copper. Type L below slab and Type M above slab. Not fitting shall occur below slab. All hot water lines to be
- Water Heating System: Furnish, install and connect piping and equipment required to
- 4.Water Healing system: Furnish instruments of the complete the water healing system.
 5. Domestic Gas Service: Provide gas line to gas-fired equipment including water healer, pool equipment, furnaces, Flumbing to be recessed in wall.
- neater, pool equipment, fundacs, runnioning to be recessed in wait.

 6. Plumbing Futures and Equipment:

 a. General: Furnish and install all fixtures and equipment shown on the drawings or specified herein. All exposed brass tubing supplies, cast brass haps, hose bibs, waste pieces and other brass tim shall be heavily polished chrome plated. Firish all piping through walls, floors or ceiling with chrome plated wall flanges or escutcheons.
 b. Compression stops, strainers, tall pieces, trim etc., are included to make a complete fixture, whether or not specified. Provide approved one-piece waste overflow and trap
- unit with glued fittings at tubs.
 c. Galvanized pipe shall not be used for waste or water supply.
 d. Water supply lines shall be installed with approved anti-sound devices where

DIVISION 16 - ELECTRICAL:

16A.-GENERAL

Electrical system layouts are generally diagrammatic, location of outlets and equipment is approximate. Exact routing of witing, location of outlet to be governed by structural conditions and constructions. Witing for equipment requiring maintenance and inspection to be readily accessible

1. Conduit piping located within planting areas shall be placed a minimum of 18 inches below finished grades.

2. Labeling: All electrical equipment, main and sub-panel breakers and time clock controls shall be properly labeled.
3. Materials: Materials and equipment shall be new and listed by Underwriter's Laboratorias: Inc., and bear their label wherever standards have been established and their service is regularly furnished. All electrical equipment shall be listed, labeled, and installed as per a recognized electrical testing labs standards.

4. Miscellaneous Electrical Notes:

h. All recessed down lights to be HALO unless otherwise specified

- Verify and locate receptacles prior to installation of drywall. b. Install receptacles at 1°-0° to center line above finish floor unless otherwise noted. c. Install light swiches at 3°-8° to center lines above finish floor unless otherwise noted.
- d. All swiched outlets shall be one-half hot. d. All swiched outlets shall be one-half hof.
 e. Locate receptacles in accordance with California Building Code.
 f. All extenior outlets, outlets in garages, outlets in bathrooms and outletchen sink or utility sink shall be a ground fault interrupter (or GFI). d outlets within 6 feet of
- a. All switches and outlets to be Decora unless otherwise specified.

Confirm with Owner sound system location, wiring and components, include into bids as directed.

16-C. SECURITY SYSTEM: Confirm with Owner security system location, wiring and components, include into bids

as directed ROOF DECK SURFACING

FLOOR DRAINS Note to Specifier: Floor drains, clean-outs, etc. should be of the "floor-flange" type as manufactured for use with composition floors by most major drain manufacturers. Drain flange shall be finished flush with substrate.

SHEET METAL FLASHING-Note to Specifier: Sheet metal flashing shall be minimum 26 gauge galvanized. All joint or seems shall be overlapped approx, 3" and caulked with Dex-O-Tex Elastex 500

PLYWOOD SUBSTRATE INCLUDING FRAMING AND BLOCKING

Note to Specifier: Plywood shall be a minimum 5/8" (preferably 3/4 inch) exterior grade plugged and sanded or filled with Dex-O-Tex G-26 Underlayment. Plywood shall be supported 16" on center and properly blocked. Plywood shall be attached with either screws, screw type or ring shank nails.

SLOPE FOR DRAINAGE-

SLOPE FOR DRAINAGE:

Note to Specifier: Slope of 1/4 inch per horizontal foot to drain is recommended. A slope to drain of less than 1/4 inch per horizontal foot may result in water ponding on the deck surface and must be designed to show that adequate slope exists to prevent ponding. This can be provided for in the substrate or by application of Dex-O-Tex G 26 Underlayment. Care must be taken to provide adequate elevation at thresholds to

Blvd.

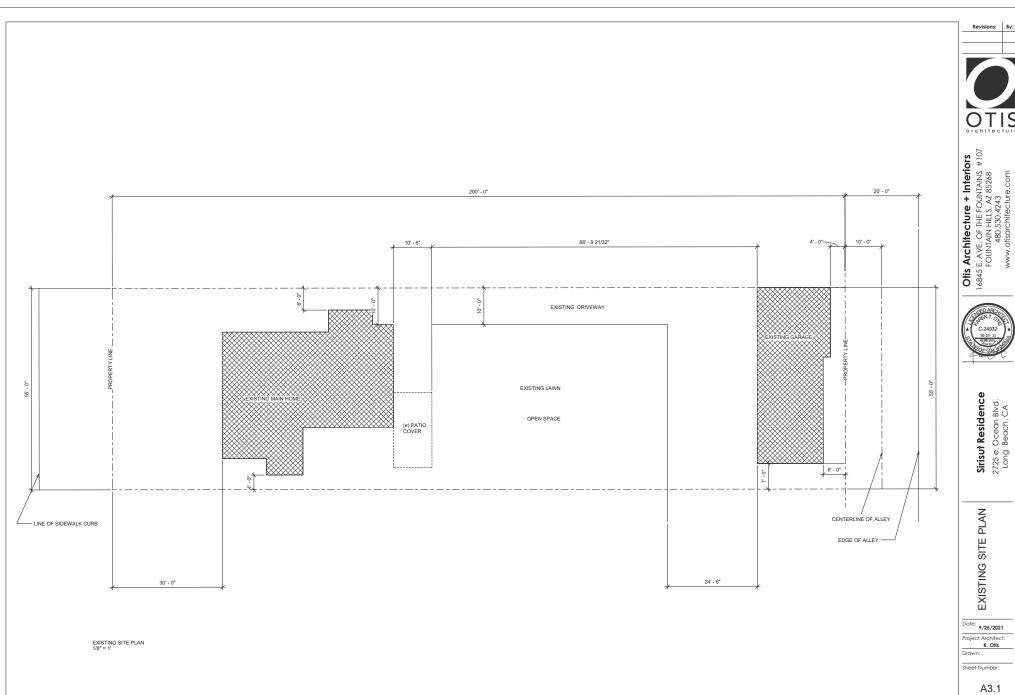
GENERAL NOTES

Project Architect

Drawn:

Sheet Number:

A2




Sirisut Residence 2725 e. Ocean Blvd. Long Beach, CA

EXISTING SITE PLAN

Date: 9/25/2021 Project Architect: K. Ofis

Sheet Number:

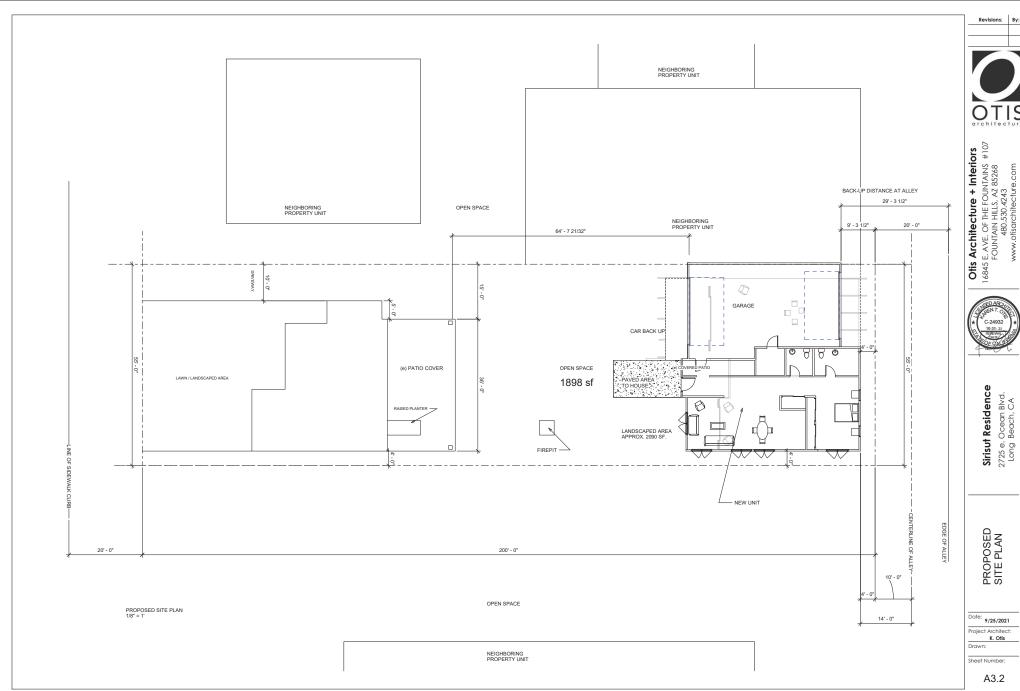A3.1







Otis Architecture + Interiors
16845 E. AVE. OF THE FOUNTAINS #107
FOUNTAIN HILLS, AZ 88288
480.530.4243
www.oisarchitecture.com

Sirisut Residence 2725 e. Ocean Blvd. Long Beach, CA

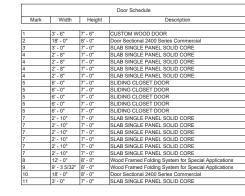
FIRST FLOOR PLAN

Date: 9/25/2021 Project Architect:

Drawn:


Sheet Number:





Window Schedule								
Mark	Width	Height	Sill Height	Description				
1	6' - 0"	5" - 0"	3' - 0"	PR CASEMENT, WOOD				
1	6' - 0"	5" - 0"	3' - 0"	PR CASEMENT, WOOD				
2	5' - 6"	5' - 0"	3' - 0"	PR CASEMENT, WOOD				
2	5' - 6"	5' - 0"	3' - 0"	PR CASEMENT, WOOD				
2	5' - 6"	5' - 0"	3' - 0"	PR CASEMENT, WOOD				
2	5' - 6"	5' - 0"	3' - 0"	PR CASEMENT, WOOD				
2	5' - 6"	5' - 0"	3' - 0"	PR CASEMENT, WOOD				
2	5' - 6"	5' - 0"	3' - 0"	PR CASEMENT, WOOD				
3	3' - 0"	4' - 6"	3' - 6"	CASEMENT, WOOD				
3	3' - 0"	4' - 6"	3' - 6"	CASEMENT, WOOD				
4	4' - 0"	2" - 0"	6' - 0"	AWNING WOOD TEMPERED				
4	4' - 0"	2" - 0"	6' - 0"	AWNING WOOD TEMPERED				
4	4' - 0"	2" - 0"	6' - 0"	AWNING WOOD TEMPERED				
5	2' - 0"	4' - 0"	4' - 0"	PR CASEMENT, WOOD				
5	2' - 0"	4' - 0"	4' - 0"	PR CASEMENT, WOOD				
6	6' - 0"	2" - 6"	5' - 6"	PR CASEMENT, WOOD				
7	3' - 0"	2" - 0"	6' - 0"	AWNING WOOD TEMPERED				
8	3' - 0"	3' - 0"		SKYLIGHT				

	Keynote Legend					
Key Value	Keynote Text					
1	WOOD CUSTOM DOOR					
2	SMOOTH STUCCO - DUNN EDWARDS COLOR WHITE (DEW380)					
3	MARVIN ULTIMATE COLLECTION WOOD WINDOWS WITH TRIM TYP.					
4	INDULGY SLATTED WOOD GARAGE DOOR, STAINED					
5	METAL CAP AT PARAPET WALL TO MATCH STUCCO					
6	42" TALL IRON GUARDRAIL					
7	DECORATIVE WOOD BEAMS WITH CORBEL END					
8	DURANGO STONE TRAVERTINE FINISH ROMANO					
9	SPANISH S-TILE ROOF SIMILAR TO MAIN HOUSE- MCA CLAY ROOF TILE. CLASSIC "S" MISSION FINISH: VINTAGE CARMEL BLEND CB364-R GROU' FILLED					
10	FLAT ROOF 1/4":1' SLOPE TO DRAINS					

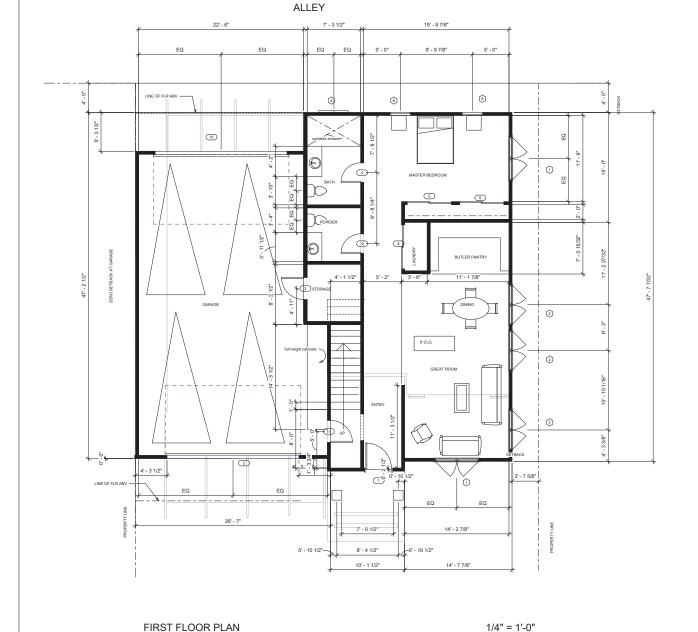

1/4" = 1'-0"

A4

Project Architect: K. Otis Drawn:

Sheet Number:

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PR CASEMENT, WOOD PR CASEMENT, WOOD PR CASEMENT, WOOD CASEMENT, WOOD

CASEMENT, WOOD AWNING WOOD TEMPERED

AWNING WOOD TEMPERED

AWNING WOOD TEMPERED PR CASEMENT, WOOD

PR CASEMENT, WOOD PR CASEMENT, WOOD

Door Schedule

CUSTOM WOOD DOOR
DOOT Sectional 2400 Series Commercial
SLAB SINGLE PANEL SOLID CORE

SLIDING CLOSET DOOR SLIDING CLOSET DOOR SLIDING CLOSET DOOR

SLIDING CLOSET DOOR SLIDING CLOSET DOOR SLAB SINGLE PANEL SOLID CORE

SLAB SINGLE PANEL SOLID CORE SLAB SINGLE PANEL SOLID CORE SLAB SINGLE PANEL SOLID CORE SLAB SINGLE PANEL SOLID CORE

Description

Mark Width Height

6' - 0" 6' - 0"

2' - 10" 2' - 10" 2' - 10" 2' - 10"

> 5' - 6" 3' - 0"

3' - 0"

4' - 0"

4' - 0" 2' - 0" 2' - 0" 6' - 0" 4' - 6"

2' - 0" 2' - 0"

2' - 0" 4' - 0"

4' - 0" 2' - 6"

 0"
 2' - 0"
 6' - 0"
 AWNING WOOD TEMPERED

 0"
 3" - 0"
 SKYLIGHT

WOOD WINDOWS BY PELLA
GARAGE DOOR BY AMARR IN WOOD MAHOGANY TONE


3' - 6"

4' - 0" 5' - 6"

	Keynote Legend
Key Value	Keynote Text
1	WOOD CUSTOM DOOR
2	SMOOTH STUCCO - DUNN EDWARDS COLOR WHITE (DEW380)
3	MARVIN ULTIMATE COLLECTION WOOD WINDOWS WITH TRIM TYP.
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8	DURANGO STONE TRAVERTINE FINISH ROMANO
9	SPANISH S-TILE ROOF SIMILAR TO MAIN HOUSE-MCA CLAY ROOF TILE- CLASSIC "S" MISSION FINISH: VINTAGE CARMEL BLEND CB364-R GROUT FILLED
10	FLAT ROOF 1/4":1' SLOPE TO DRAINS

	4'-0"	15' - 5 7/8"	4' - 9 5/8"	5' - 8 1/2"	7' - 1 1/2"	7' - 0"	4' - 10 3/8"	4' - 0"	
PROPERTY LINE	SETBACK	4' - 7 3/4"	# 1		EQ EQ	6' - 1"	*	SETBACK	
	+	2 2	 	4	2		1		
						SKYLIGHT			ETBACK
*					71/	(1)			-05
			pantry	POWDER	LAUNDRY		$\mathbb{T} \times \mathbb{P}$		
	!	KITCHEN		$\mathbb{O}[/]$		*			-
						BATHRM	2/01	$+\psi$	g
				7	2' - 0" 1' - 3'	BATHAM]	g
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	<u> </u>	8						PROPE	
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12 - 7"		DECK							_
				1					
*				7					
		EQ	EQ	\downarrow		EQ	EQ	. !	
						12' - 0 29/3	12"		
		20' - 0"		<u>-</u>					
	4' - 0"	22' - 8 1/2"		9'	- 11"	14' - 10 3	/8"	*	
	İ			55' - 5 7/8"					

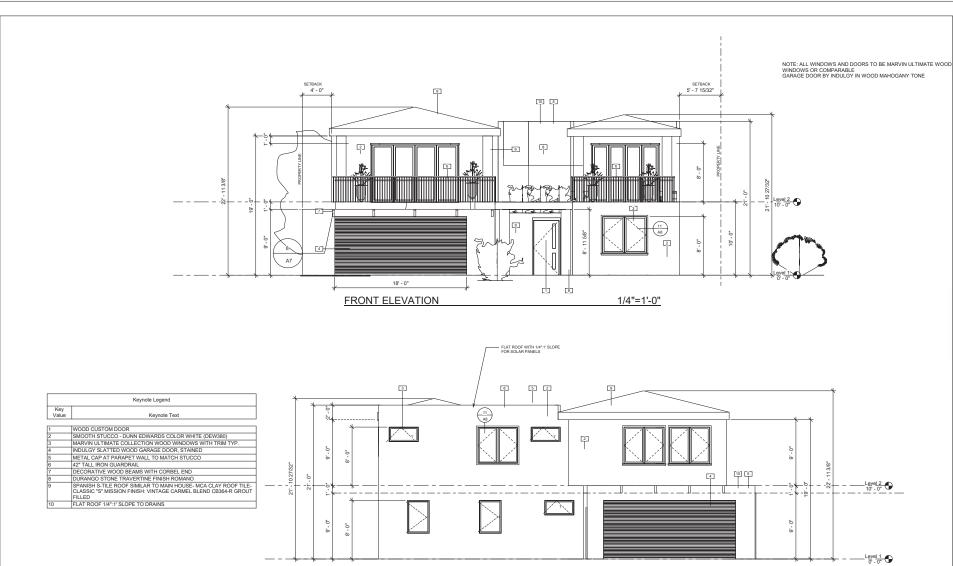SECOND FLOOR PLAN



1/4"=1'-0"

REAR (ALLEY) ELEVATION

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FOUNTAIN HILLS, AZ 88288
480.530.4243
www.oisarchitecture.com

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FRONT AND REAR ELEVATIONS

Date: 9/25/2021

Project Architect: K. Otis Drawn:

Sheet Number:

A6



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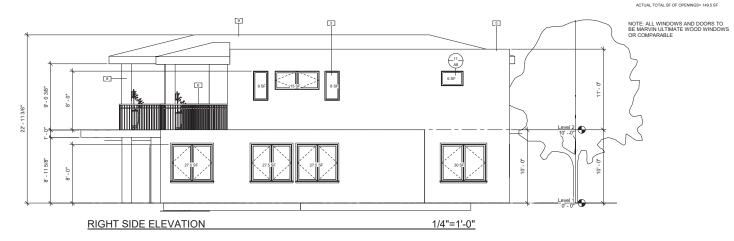
SIDE ELEVATIONS


Date: 9/25/2021


Project Architect: K. Otis Drawn:

Sheet Number:

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LEFT SIDE ELEVATION 1/4"=1'-0"

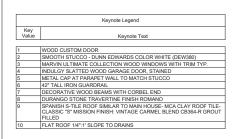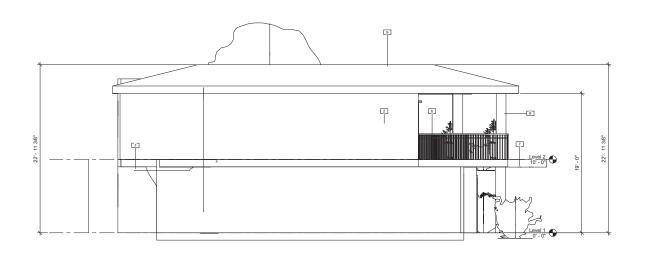