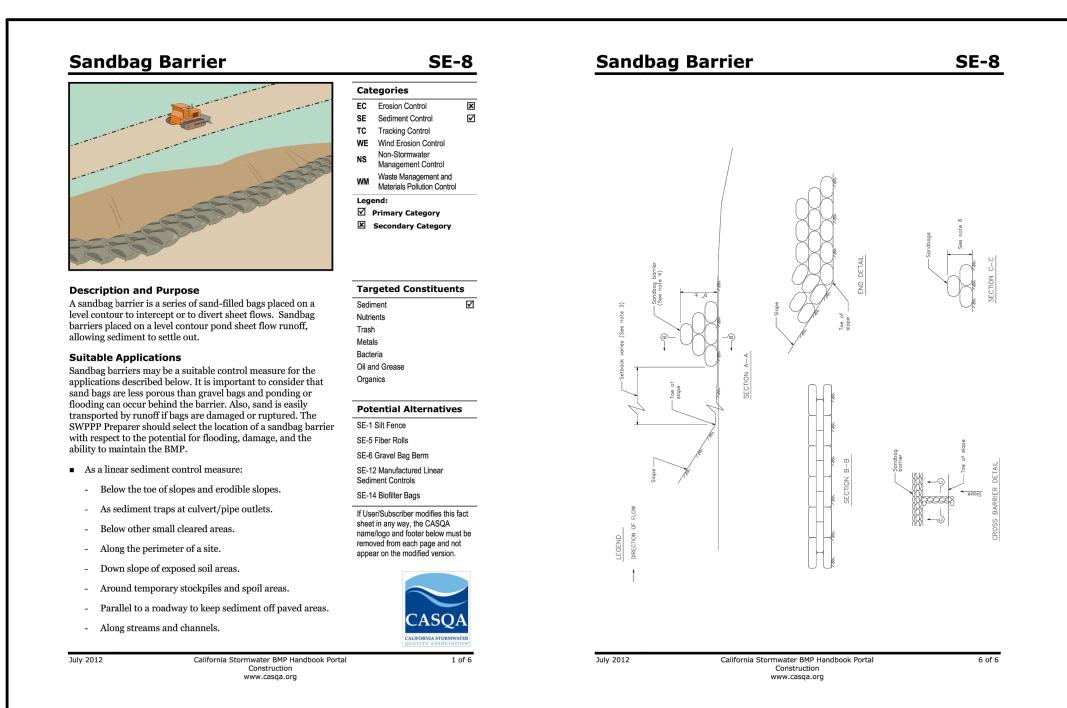


SCOPE OF WORK	PROJECT CONTACTS		
 NEW ADU ABOVE 331 SQ. FT. (E) GARAGE ADU'S ENTRANCE WITH STAIRWELL FOR NEW ADU ABOVE (E) GARAGE REMOVE FRONT DRIVEWAY SLAB, PORE NEW SLAB TO CONTINUE EXISTING RIBBON 	OWNER DEBORAH 3754 LEWIS AVE. LONG BEACH,CA 90807 ATTN: DEBORAH TEL: FAX: E-MAIL:	DESIGNER LONG BEACH DESIGNERS 5252 LONG BEACH BLVD. LONG BEACH CA. 90805 ATTN: LEOH SANDOVAL TEL: 310.749.3195 FAX: E-MAIL: LEOH@LBDESIGNERS.COM	
UTILITY NOTES	CODES		PLAN NOTES:
CONTACT THE LOCAL GAS COMPANY FOR NEW GAS SERVICE INSTALLATION CONTACT THE LOCAL WATER DEPARTMENT FOR NEW METER SERVICE NSTALLATION CONTACT THE LOCAL ELECTRIC UTILITY COMPANY FOR A METER SPOT	ALL WORK SHALL CONFORM TO THE CITY OF LONG BEACH MUNICIPAL CO CODE ,		PRE-CONSTRUCTION MEETING WITH CITY BUILDING INSPE REQUIRE PRIOR TO COMMENCING WORK CONTRACT INSP AT (562)570-6194 TO SCHEDULE AN INSPECTION.




NORTH

	SHEET INDEX		REVISIONS
	A-1 SITE PLAN		
	A-1.1 BMP A-2 DEMO PLAN		CITY COMMENTS 10.25.21
	A-3 PROPOSED PLAN		Δ
	A-3.1 PROPOSED PLAN SECOND FLR		$\overline{\Delta}$
	A-4 PROPOSED CEILING PLAN A-5 ROOF PLAN		Δ
	A-6 ELEVATION PLAN		
	PROJECT DATA MAIN HOUSE		
SPECTION IS			RESIDENTIAL COMMERCIAL
ISPECTION LINE		TYPE V - B	DESIGN
	FIRE SPRINKLERS	NO	
	OCCUPANCY GROUP		
	APN		
	ZONE TRACT		3080 5
	BLOCK		
	LOT		ACH R S -CALIFORNIA 90805
	SITE AREA		
	EXISTING GARAGE ADU'S ENTRANCE AREA		BEACH BEACH
	NEW ADU 2ND FLOOR	331 SQ. FT.	
IM. FROM ALLEY TO PL.	OPEN SPACE REQUIRED OPEN SPACE PROVIDED		
15'-0"	LOT COVERAGE		E S I
		0.00	
	FRONT SETBACK		
	SIDES REAR SETBACK		DES DES WWW.LB
	PROPOSED BUILDING HEIGHT		5252
			310-749-3195
9			
1			
ALLEY			-
A A	KEY NOTES		_
	1 • (E) GATE 9 2 • HOUSE PERIMETER 10	EXISTING FENCE EXISTING AREA PER PERMIT NUMBER	1
2	(E) GAS METER	BRMD249733	
	4 (E) ELECT. PANEL [1]	 STREET TREES : JACARANDA MIMOSIFOLIA (N) TANKLESS WATER HEATER 	
	(E) WATER METER	CORNER CUT-OFF	RAGE
	7 0 0 14	REMOVE FRONT DRIVEWAY SLAB, PORE NEW SLAB TO MATCH EXISTING RIBBON	AR/
	8 (E) WATER HEATER		
			ADU ABOVE GAI S.SMITH RE 3754 LEWIS AVE. LONG BEACH CA 90807
	LEGEND		
	X:XX ROOF SLOPE GAR	AGE PERIMETER	
		PPERTY LINE	NEW ADU ABOVE MR.&MRS.SMITH F 3754 LEWIS AV LONG BEACH CA
	ELEVATION SYMBOL SHADING IN		
		DVE 331 SQ. FT.	Z Z
		ADING INDICATES	
	ADU'S ENTR	RANCE 113 SQ. FT.	\geq
			-
1	GENERAL NOTES		_
	1. PROVIDE HOUSE STREET NUMBER VISIBLE AND LEG		
	 FINISH GRADE AROUND THE NEW STRUCTURE/ ADDI FOR DRAINAGE PURPOSES. 	ITION SHALL BE SLOPED AWAY FROM THE BUILDING	DESIGNER
	3. THE DISCHARGE OF POLLUTANTS TO ANY STORM DF PETROLEUM BYPRODUCTS, SOIL PARTICULATE, CON		1.4
		STRUCTION ACTIVITIES SHALL BE PLACED, CONVEYED OR	M
	 CONTRACTOR TO REPLACE CLAY SEWER LINE IF IT F ADDITION) 		LEOH SANDOVAL 10/27/21
	ADDITIONS & OR REMODEL AND PROVIDE HOME OW		
	ELECTRICAL , MECHANICAL, & PLUMBING TO BE DES	IGN BUILD & TO CODE)	
	 SEPARATE PERMIT(S) IS/ARE REQUIRED FOR ACCES RETAINING WALL, DEMOLITION, ETC. 	SORY BUILDING, PATIO COVERS, FENCES, SWIMMING POOL,	
	AS-BUILT NOTES		-
			-
	ALTHOUGH ALL REASONABLE EFFORTS WERE MADE TO E AS-BUILT CONDITIONS AND ARE NOT INTENDED TO REPR	ESENT AN EXACT AND ACCURATE LAYOUT. THE OWNER	
	SHOULD ANTICIPATE UNFORESEEN CONDITIONS AND SHO	UULD BE EXPECTED DURING CONSTRUCTION.	
	OWNER		
	OWNER		JOB NUMBER: ##
	THE CONTRACTOR SHALL VERIFY ALL DIMENSIONS ON TH NOTES AND DIMENSIONS ON ARCHITECTURAL PLANS SHA	HE JOB SITE ACCORDING TO THE CONTRACT DOCUMENTS. ALL BE CHECKED AND VERIFIED WITH STRUCTURAL,	PLOT DATE: 10/27/21
	MECHANICAL, PLUMBING AND ANY OTHER DRAWINGS INC DISCREPANCIES IN NOTES AND OR DIMENSIONS SHALL B	CLUDED IN THE CONTRACT DOCUMENTS. ANY E BROUGHT TO THE IMMEDIATE ATTENTION OF THE	DRAWN BY: Leoh
	DESIGNER PRIOR TO COMMENCING WORK, SO THAT ANY		SHEET TITLE:
	ALL DRAWINGS, SPECIFICATIONS AND OTHER DOCUMENT FOR THIS PROJECT ARE INSTRUMENTS OF THE DESIGNER		Site Plan SHEET NO:
	PROJECT AND UNLESS OTHERWISE PROVIDED, THE DESIGNED DOCUMENTS AND SHALL RETAIN ALL COMMON LAW, STAT	GNER SHALL BE DEEMED THE AUTHOR OF THESE	
	,	PECIFICATIONS AND OTHER DOCUMENTS FOR INFORMATION	
			FILE NAME: -



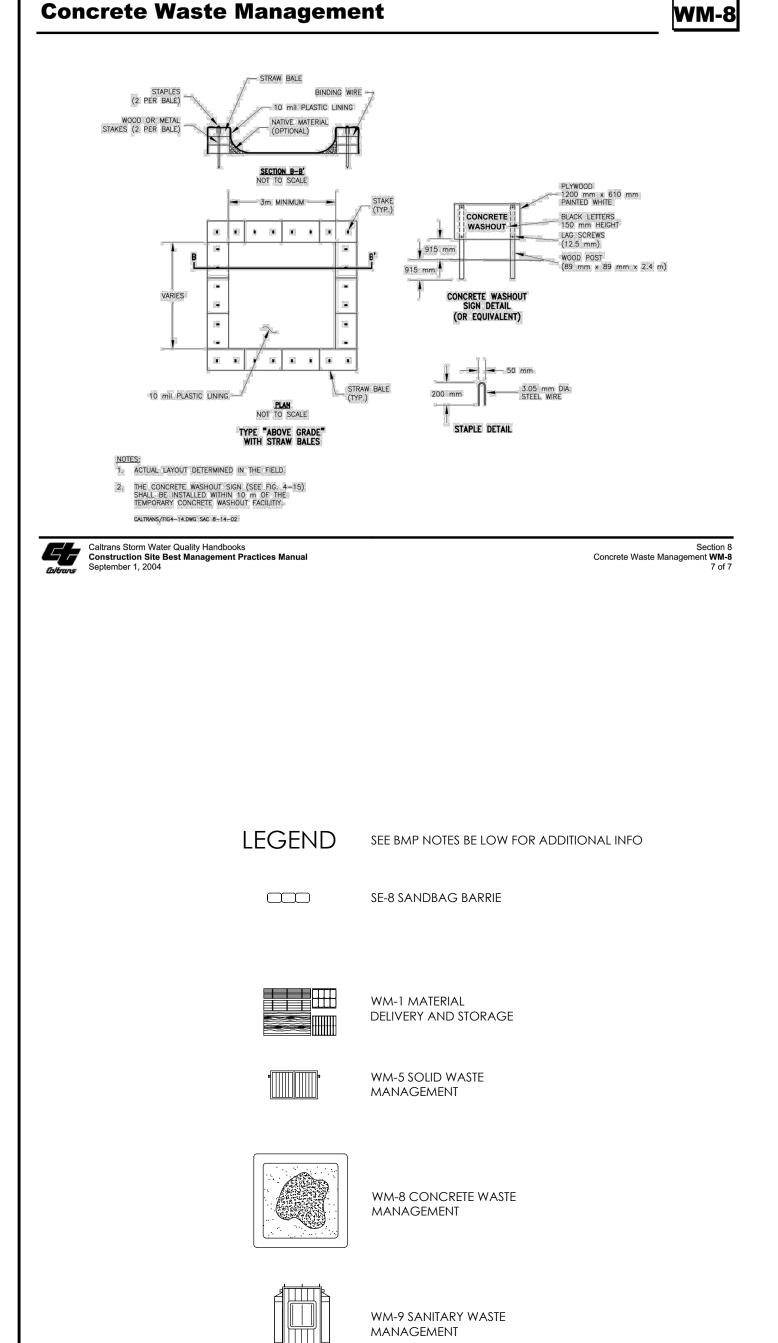
Concrete Waste Management




Solid Waste Management

WM-5

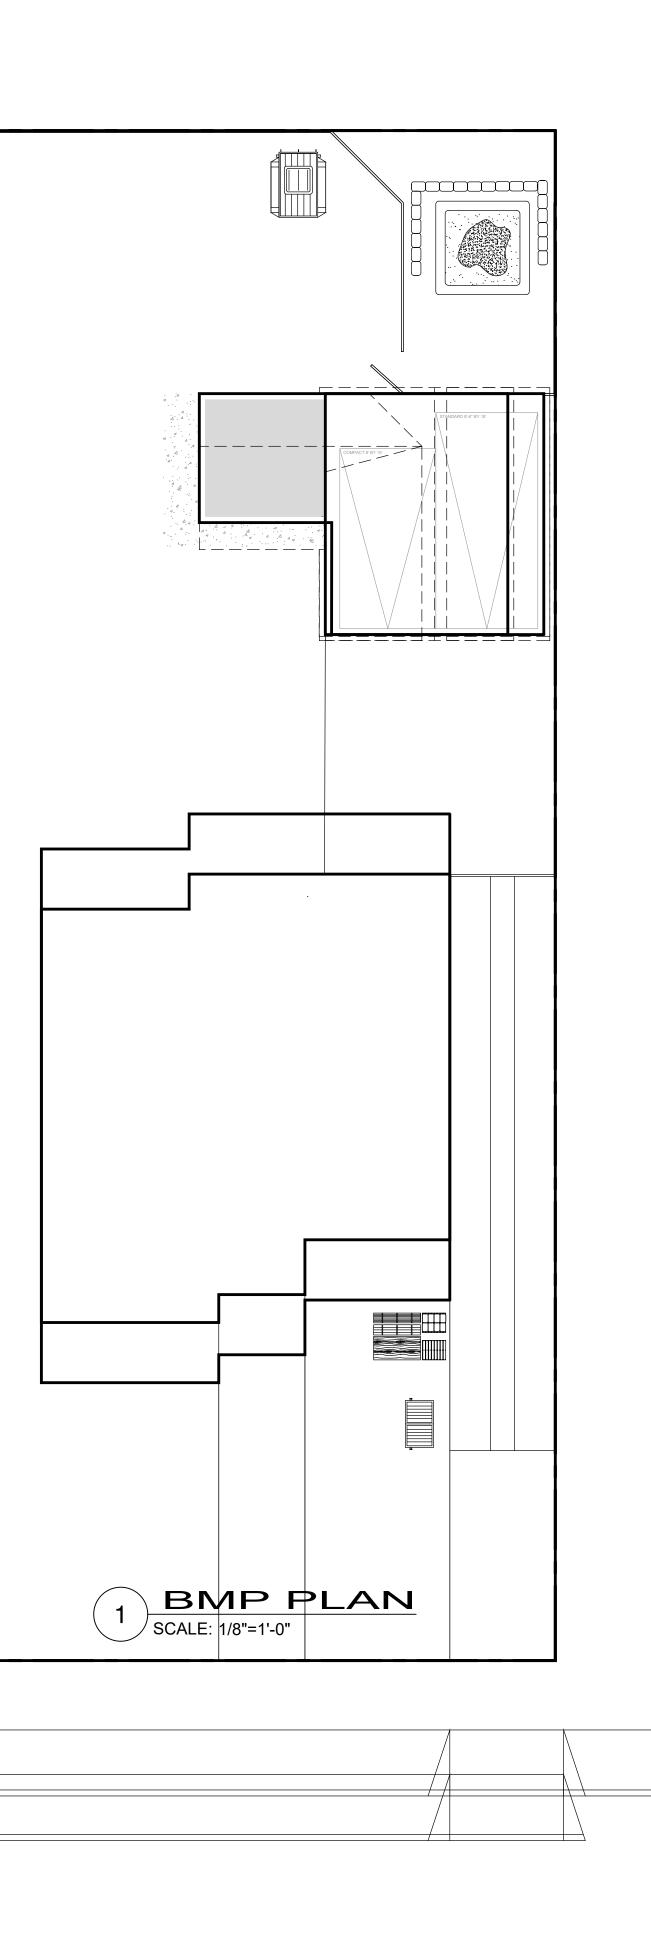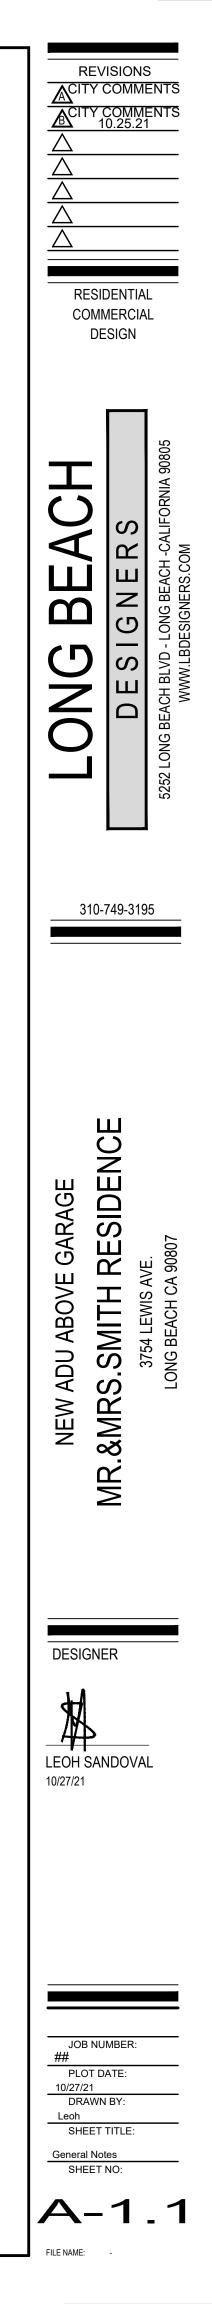- Standards and Education Specifications
 The Contractor's Water Pollution Control Manager (WPCM) shall oversee and enforce proper solid waste procedures and practices.
 - Instruct employees and subcontractors on identification of solid waste and hazardous waste.
 - Educate employees and subcontractors on solid waste storage and disposal procedures.
 - Hold regular meetings to discuss and reinforce disposal procedures (incorporate into regular safety meetings).
 - Require that employees and subcontractors follow solid waste handling and storage procedures.
 - Prohibit littering by employees, subcontractors, and visitors.
 - Wherever possible, minimize production of solid waste materials.
 - Collection, Storage, and Disposal
 - Dumpsters of sufficient size and number shall be provided to contain the solid waste generated by the project and properly serviced.
 - Littering on the project site shall be prohibited.
 - To prevent clogging of the storm drainage system litter and debris removal from drainage grates, trash racks, and ditch lines shall be a priority.
 - Trash receptacles shall be provided in the Contractor's yard, field trailer areas, and at locations where workers congregate for lunch and break periods.
 - Construction debris and litter from work areas within the construction limits of the project site shall be collected and placed in watertight dumpsters at least weekly regardless of whether the litter was generated by the Contractor, the public, or others. Collected litter and debris shall not be placed in or next to drain inlets, storm water drainage systems or watercourses.
 - Full dumpsters shall be removed from the project site and the contents shall be disposed of outside the highway right-of-way in conformance with the provisions in the Standard Specifications Section 7-1.13.
 - Litter stored in collection areas and containers shall be handled and disposed of by trash hauling contractors.
 - Construction debris and waste shall be removed from the site every two weeks or as directed by the RE.









4 WEST MAIN HOUSE ELEVATION SCALE: 1/4"=1'-0"



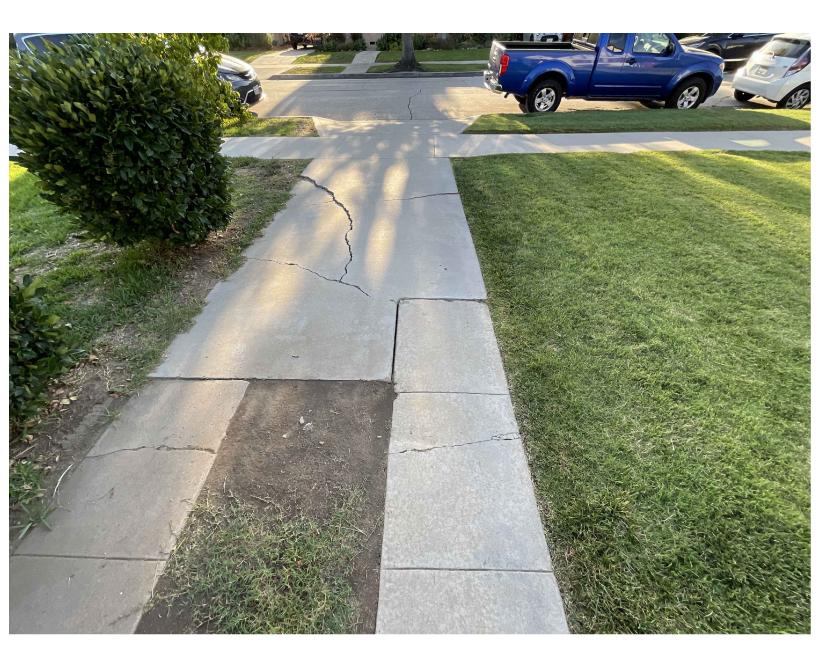5 SCALE: 1/4"=1'-0"




6 SCALE: 1/4"=1'-0"

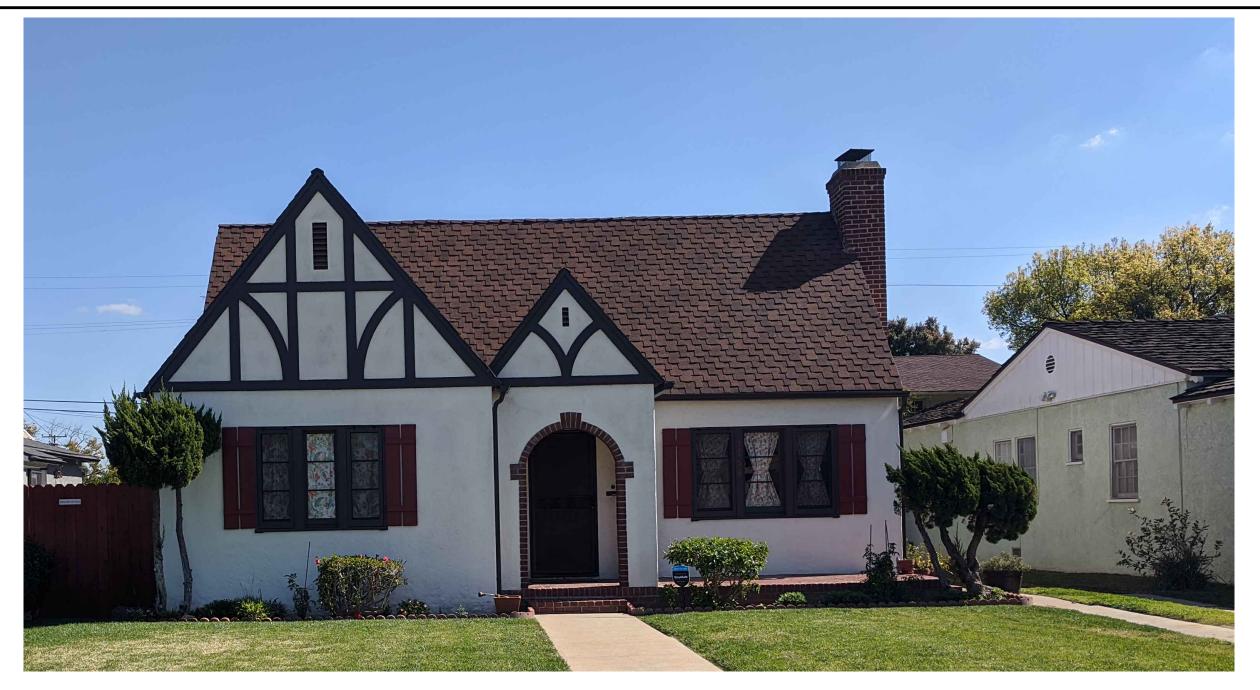







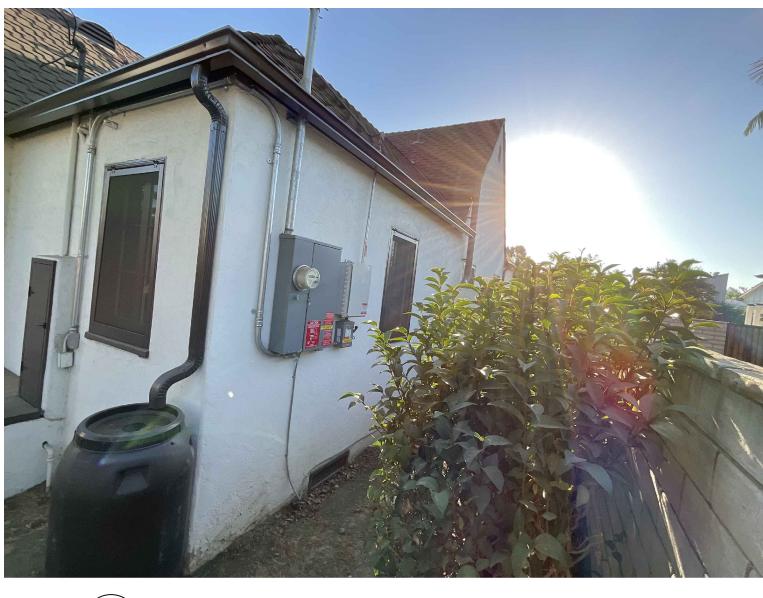





1 WEST MAIN HOUSE PICTURE SCALE: 1/4"=1'-0"

2 EAST MAIN HOUSE PICTURE SCALE: 1/4"=1'-0"

3 NORTH MAIN HOUSE PICTURE SCALE: 1/4"=1'-0"

REVISIONS CITY COMMENTS CITY COMMENTS CITY COMMENTS CITY COMMENTS CITY COMMENTS COMMENTIAL COMMERCIAL DESIGN								
LONG BEACH	DESIGNERS	5252 LONG BEACH BLVD - LONG BEACH -CALIFORNIA 90805 WWW.LBDESIGNERS.COM						
310-7	749-319	5						
AGE		LONG BEACH CA 90807						
DESIGNE LEOH SAN 10/27/21		 						
JOB NU ## PLOT D. 10/27/21 DRAWN Leoh SHEET PICTURES SHEET SHEET	ATE: BY: TITLE:							

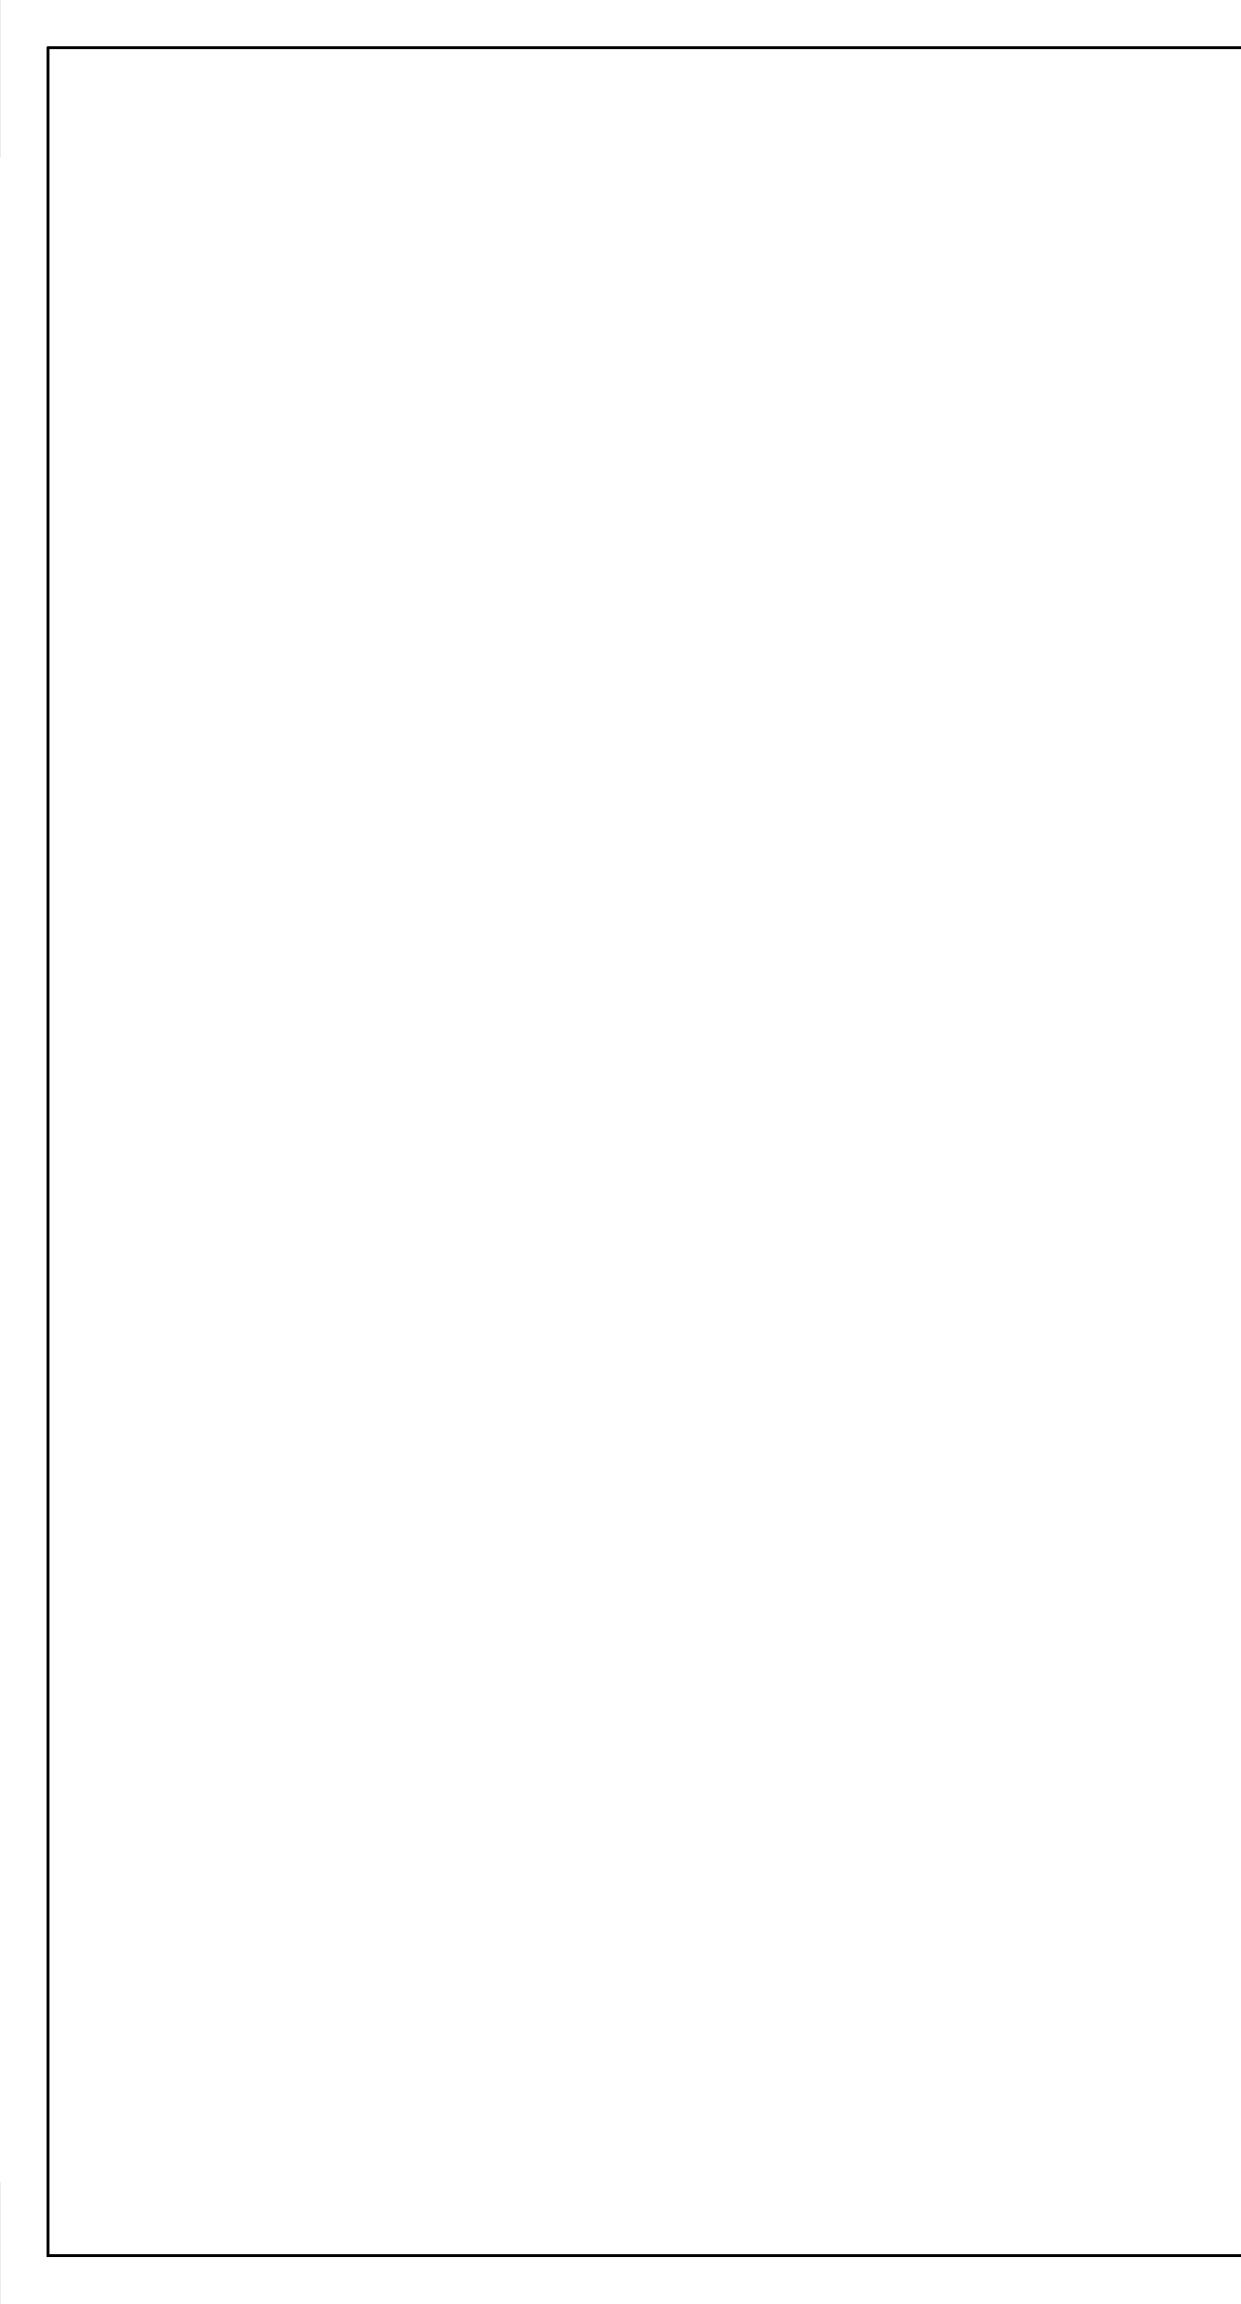


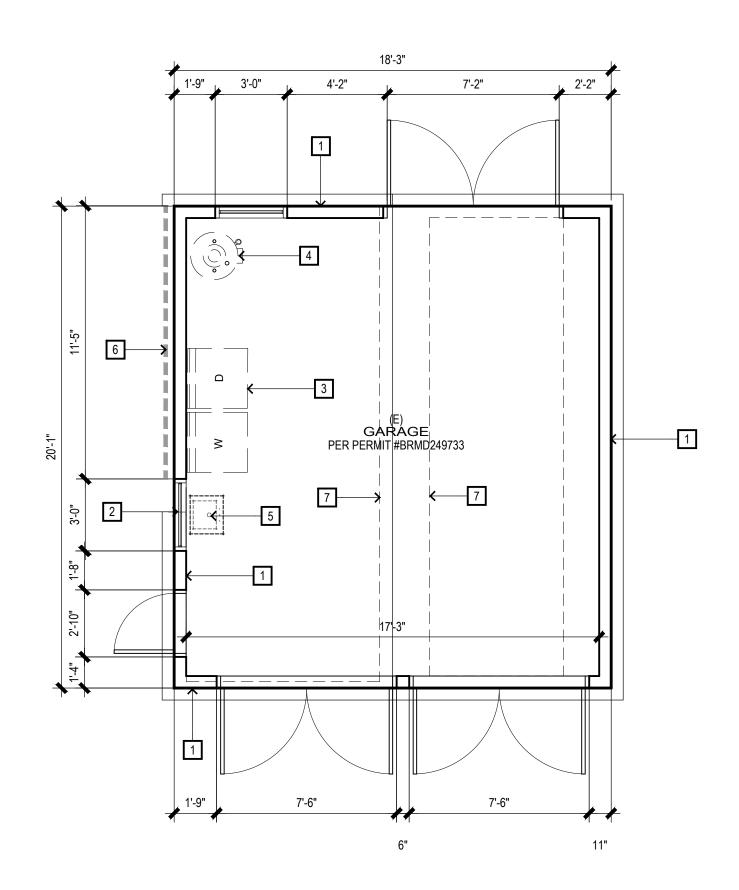







KEYNOTES	
 PROTECT EXISTING WALL IN PLACE PROTECT EXISTING WINDOW IN PLACE RELOCATE DRYER AND WASHER REMOVE WATER HEATER RELOCATE SINK REMOVE STUCCO. TO BE REPLACED BY DRYWALL DEMO PORTION OF THE ROOF TO ACCOMMODATE ADU'S DORMER 	$ \begin{array}{c} \underline{\Delta} \\ \underline{A} \\ \underline$
DEMO PORTION OF THE ROOF TO ACCOMMODATE ADD'S DORMER	RESIDENTIAL COMMERCIAL DESIGN
PRIOR TO BID, CONTRACTOR SHALL VISIT THE SITE TO ADEQUATELY DETERMINE ALL PREEXISTING CONDITIONS AND THE FULL EXTENT OF ALL REQUIRED DEMOLITION. BY THE ACT OF SUBMITTING A B THE CONTRACTOR WILL BE DEEMED TO HAVE COMPLIED WITH FORGOING, TO HAVE ACCEPTED SUC CONDITIONS, AND TO HAVE MADE ALLOWANCES THEREFORE IN PREPARING HIS BID.	
 CONTRACTOR SHALL PROVIDE ALL TEMPORARY BRACING AS REQUIRED TO MAINTAIN STRUCTURAL STABILITY OF THE EXISTING STRUCTURE DURING ALL PHASES OF CONSTRUCTION. CONTRACTOR TO COORDINATE REMOVAL AND STORAGE OF ALL EQUIPMENT AND FIXTURES WITH OWNER. WHERE ANY PLUMBING, MECHANICAL, OR ELECTRICAL ITEMS, LINES CONDUITS, PIPES, FIXTURES, E HAVE BEEN REMOVED; PLUG AND CAP CEILING AS NECESSARY TO CONCEAL ABANDONED ITEMS, PATCH AND REPAIR FLOOR, CEILING AND/OR WALLS AS NECESSARY. CONTRACTOR TO PATCH AND REPAIR ANY DAMAGED PORTIONS OF THE BUILDING TO REMAIN AND MATCH NEW OR EXISTING WORK AT NO ADDITIONAL COST TO OWNER. THIS PLAN INDICATES A GENERAL DEMOLITION SCOPE OF WORK TO BE PERFORMED AND DOES NOT RELIEVE THE CONTRACTOR FROM OTHER INCIDENTAL DEMOLITION WORK REQUIRED TO COMPLET THE BUILDING MODIFICATIONS AS SHOWN AND REQUIRED BY THE CONTRACT DOCUMENTS INCLUD 	TC., T <u>310-749-3195</u> TE
 BUT NOT LIMITED TO PLUMBING, ELECTRICAL, AND HVAC. ANY ITEMS SALVAGED BY THE CONTRACTOR SHALL BE DISPOSED OF PROPERLY OFF-SITE AND IN A EXPEDITIOUS MANNER. DO NOT BURN ANY DEMOLISHED MATERIALS ON SITE. PROTECT ALL PEDESTRIAN TRAFFIC AFFECTED BY THE DEMOLITION AND CONSTRUCTION WORK, AS SET FORTH IN THE BUILDING CODE. HEIGHT AND BARRICADE CONSTRUCTION, IF ANY, TO BE DETERMINED BY LOCAL PUBLIC AGENCY. IF CONTRACTOR ENCOUNTERS ANY HAZARDOUS MATERIALS DURING DEMOLITION OR CONSTRUCTION HE SHALL IMMEDIATELY STOP WORK AND NOTIFY OWNER. DURING REMOVAL OF OVERHEAD ELEMENTS, PROVIDE PROPER PROTECTION FROM FALLING OBJECTION IN AN ORDERLY AND CAREFUL MANNER. ENSURE THAT NO EXISTING CONSTRUCTION IS DISMANTLED, DEMOLISHED OR REMOVED WITHOUT KNOWING SPECIFICALLY WH 	оn, cts. Щ
 IT IS, HOW IT SHOULD BE HANDLED, AND WHAT IMPACT ITS REMOVAL OR DEMOLITION MAY HAVE ON EXISTING CONSTRUCTION, STRUCTURE AND BUILDING SERVICES. IF THERE ARE ANY QUESTIONS CONCERNING THE DEPOSITION OF EXISTING CONSTRUCTION ENCOUNTERED, NOTIFY ARCHITECT IN WRITING BEFORE PROCEEDING. ASSUME ALL RESPONSIBILITY AND LIABILITY, INCLUDING RESPONSIBLE FOR MAINTAINING STRUCTURAL INTEGRITY OF ALL WORK. CONSEQUENTIAL DAMAGES RESULTANT OF FAILURE TO PROCEED WITHOUT REASONABLE CAUTION. 12 CEASE OPERATIONS AND NOTIFY OWNER IMMEDIATELY IF SAFETY OF STRUCTURE APPEARS ENDANGERED. DO NOT RESUME OPERATIONS UNTIL SAFETY IS RESTORED AND ASSURED. 13 STATE HEALTH & SAFETY CODE SEC. 17921.9 BANS THE USE OF CHLORINATED POLYVINYL CHLORIDE (CPVC) FOR INTERIOR WATER-SUPPLY PIPING. 14 PROVIDE HOUSE STREET NUMBER VISIBLE AND LEGIBLE FROM STREET. 	DU ABOVE GARAGE SMITH RESIDE 3754 LEWIS AVE.
 15 FINISH GRADE AROUND THE NEW STRUCTURE/ ADDITION SHALL BE SLOPED AWAY FROM THE BUILD FOR DRAINAGE PURPOSES. 16 THE DISCHARGE OF POLLUTANTS TO ANY STORM DRAINAGE SYSTEM IS PROHIBITED. NO SOLID WASTE, PETROLEUM BYPRODUCTS, SOIL PARTICULATE, CONSTRUCTION WASTE MATERIALS, OR WASTEWATER GENERATED ON CONSTRUCTION SITES OR BY CONSTRUCTION ACTIVITIES SHALL BE PLACED, CONVEYED OR DISCHARGED INTO THE STREET, GUTTER OR STORM DRAIN SYSTEM. 17 SEPARATE PERMIT(S) IS/ARE REQUIRED FOR ACCESSORY BUILDING, PATIO COVERS, FENCES, SWIMMING POOL, RETAINING WALL, DEMOLITION, ETC. 	$-\infty$
LEGEND (E) WALL TO REMAIN	
2x4 WOOD STUDS @ 16" O.C. [] (E) WALL TO BE REMOVED 2x4 WOOD STUDS @ 16" O.C.	DESIGNER LEOH SANDOVAL 10/27/21
UNDERGROUND SERVICE ALERT	
	JOB NUMBER: ## PLOT DATE:
TWO WORKING DAYS BEFORE YOU DIG Section 4216/4217 of the Government Code requires a Dig Alert Identification Number be issued before a Permit	PLOT DATE: 10/27/21 DRAWN BY: Leoh SHEET TITLE: A-2 Demo Plan SHEET NO:
to Excavate will be valid. For your Dig Alert Identification Number call	

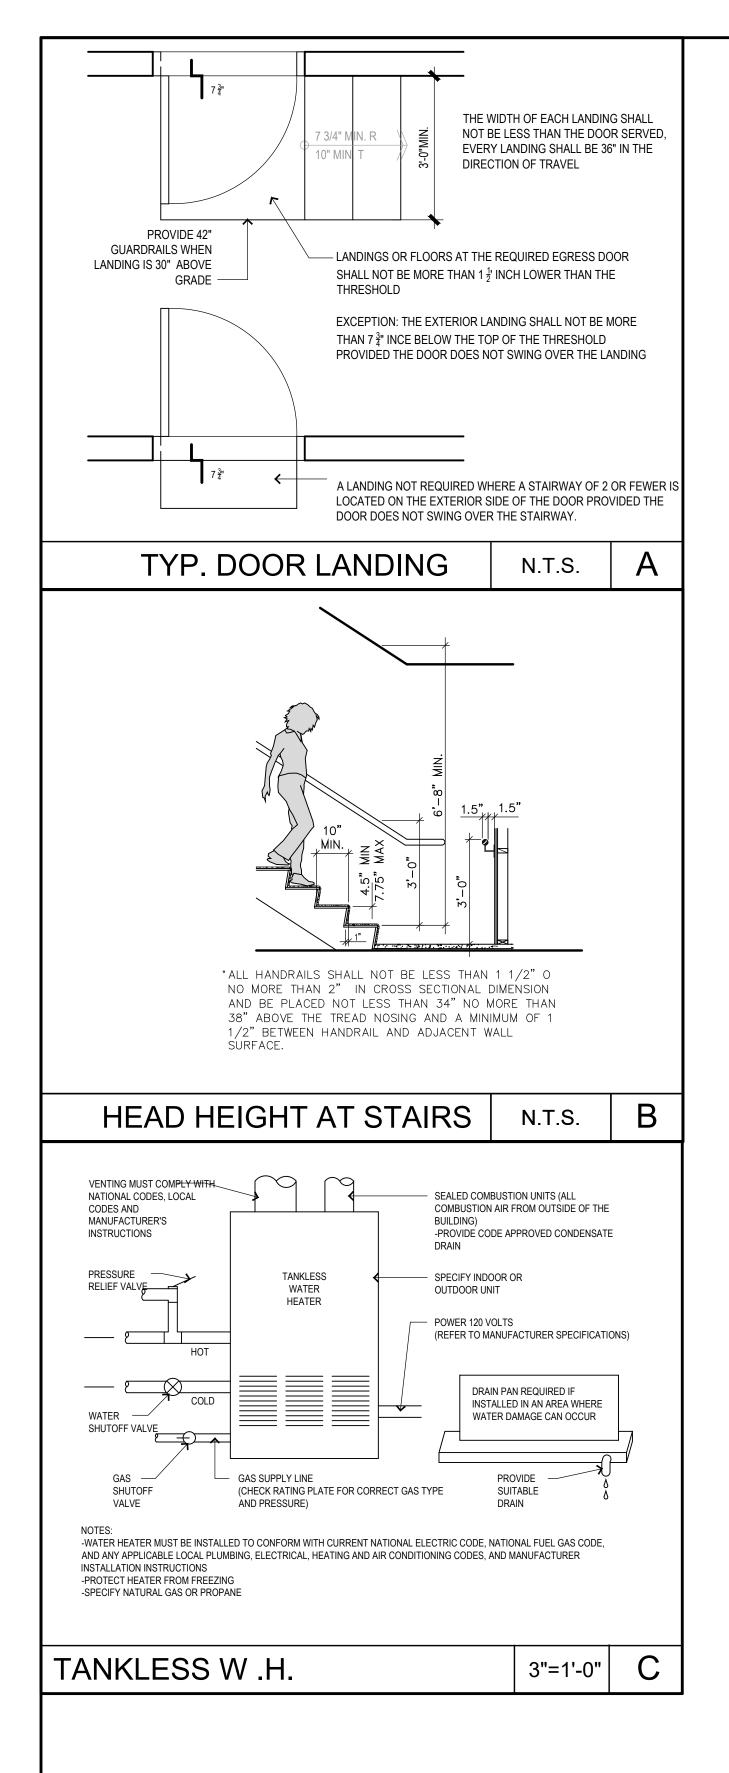
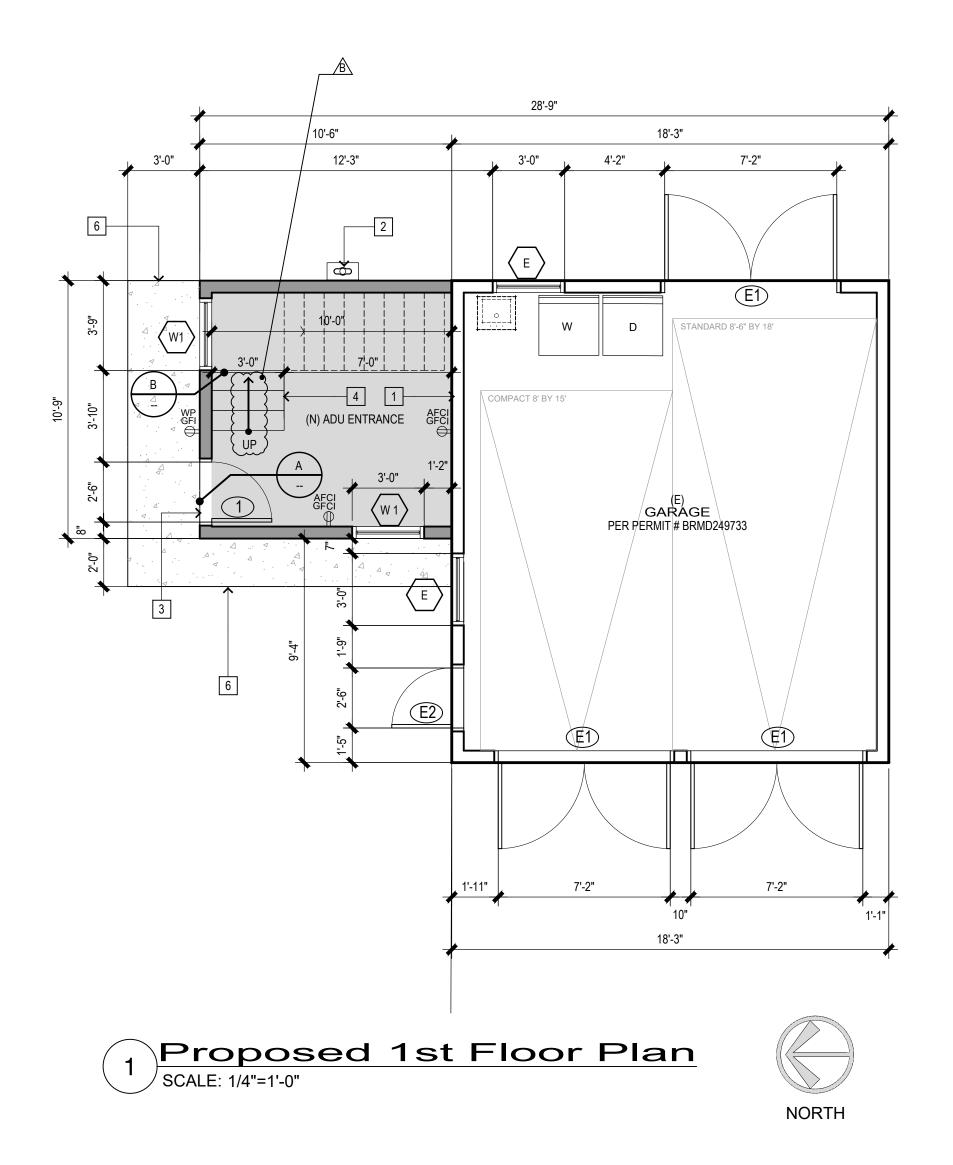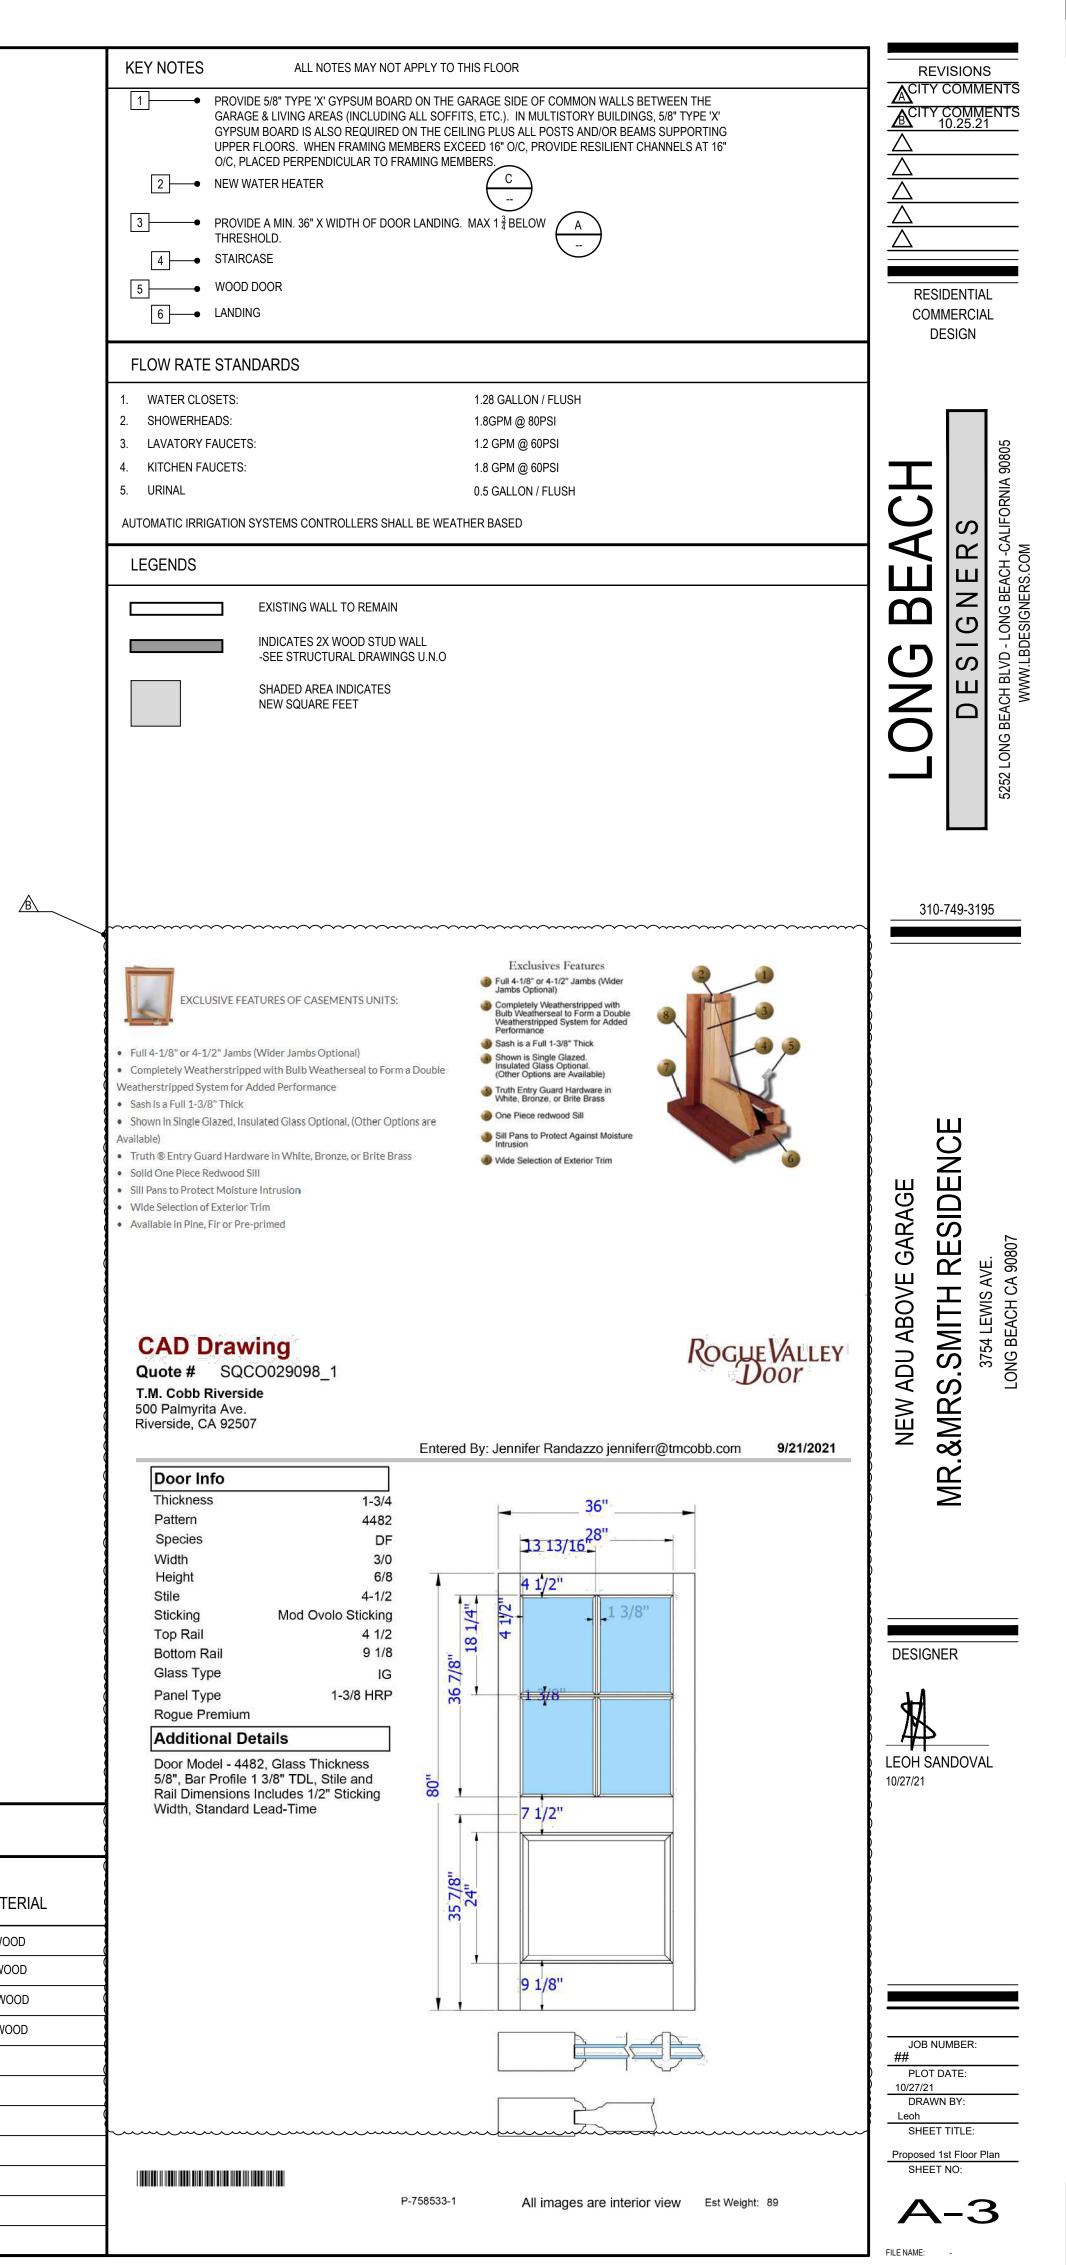
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	OR SCHEDULE	MANUFACTURE : Five Sta	ar French I	Doors & V	Vindows					WINDOW SCHEDULE MANUFACTURE : Five Star French Doors & Windows Q# 293093								
		SIZE	MATERIAL FIRE		TYPE	DEMADIZS			WINDOW NO.			SIZE						
#	LOCATION	WIDTH x HEIGHT	CORE	THK	LABEL		REMARKS	OPERATION	MATERIAL	< <u>w</u> #>	LOCATION	WIDTH x HEIGHT	OPERATION	HEAD HEIGHT	REMARKS	U-FACTOR	SHGC	MATER
E1	EXISTING	7'-2"X 6'-8"	SC	-	-	HINGED	PANEL	DOUBLE HUNG	WOOD	E	EXISTING	3'-0" X 3'-0"	CASEMENT	6'-8"	TEMPERED	1.2	.81	WOOD
E2	EXISTING	3'-0" X 6'-8"	SC	-	-	HINGED	PANEL	SINGLE HUNG	WOOD	W1	ADU ENTRANCE	3'-0" X 3'-0"	CASEMENT	6'-8"	TEMPERED	1.2	.81	WOOI
1	ADU ENTRANCE	3'-0" X 6'-8"	SC	1-3/4	-	HINGED	PANEL 1-3/8 HRP	SINGLE HUNG	WOOD	W2	ADU	3'-0" X 3'-0"	CASEMENT	5'-9"	TEMPERED	1.2	.81	WOO
2	ADU	3'-0" X 6'-8"	SC	-	-	HINGED	FLUSH	SINGLE HUNG	WOOD	W3	ADU	2'-4" X 2'-4"	CASEMENT	5'-9"	OBSCURE	1.2	.81	WOO
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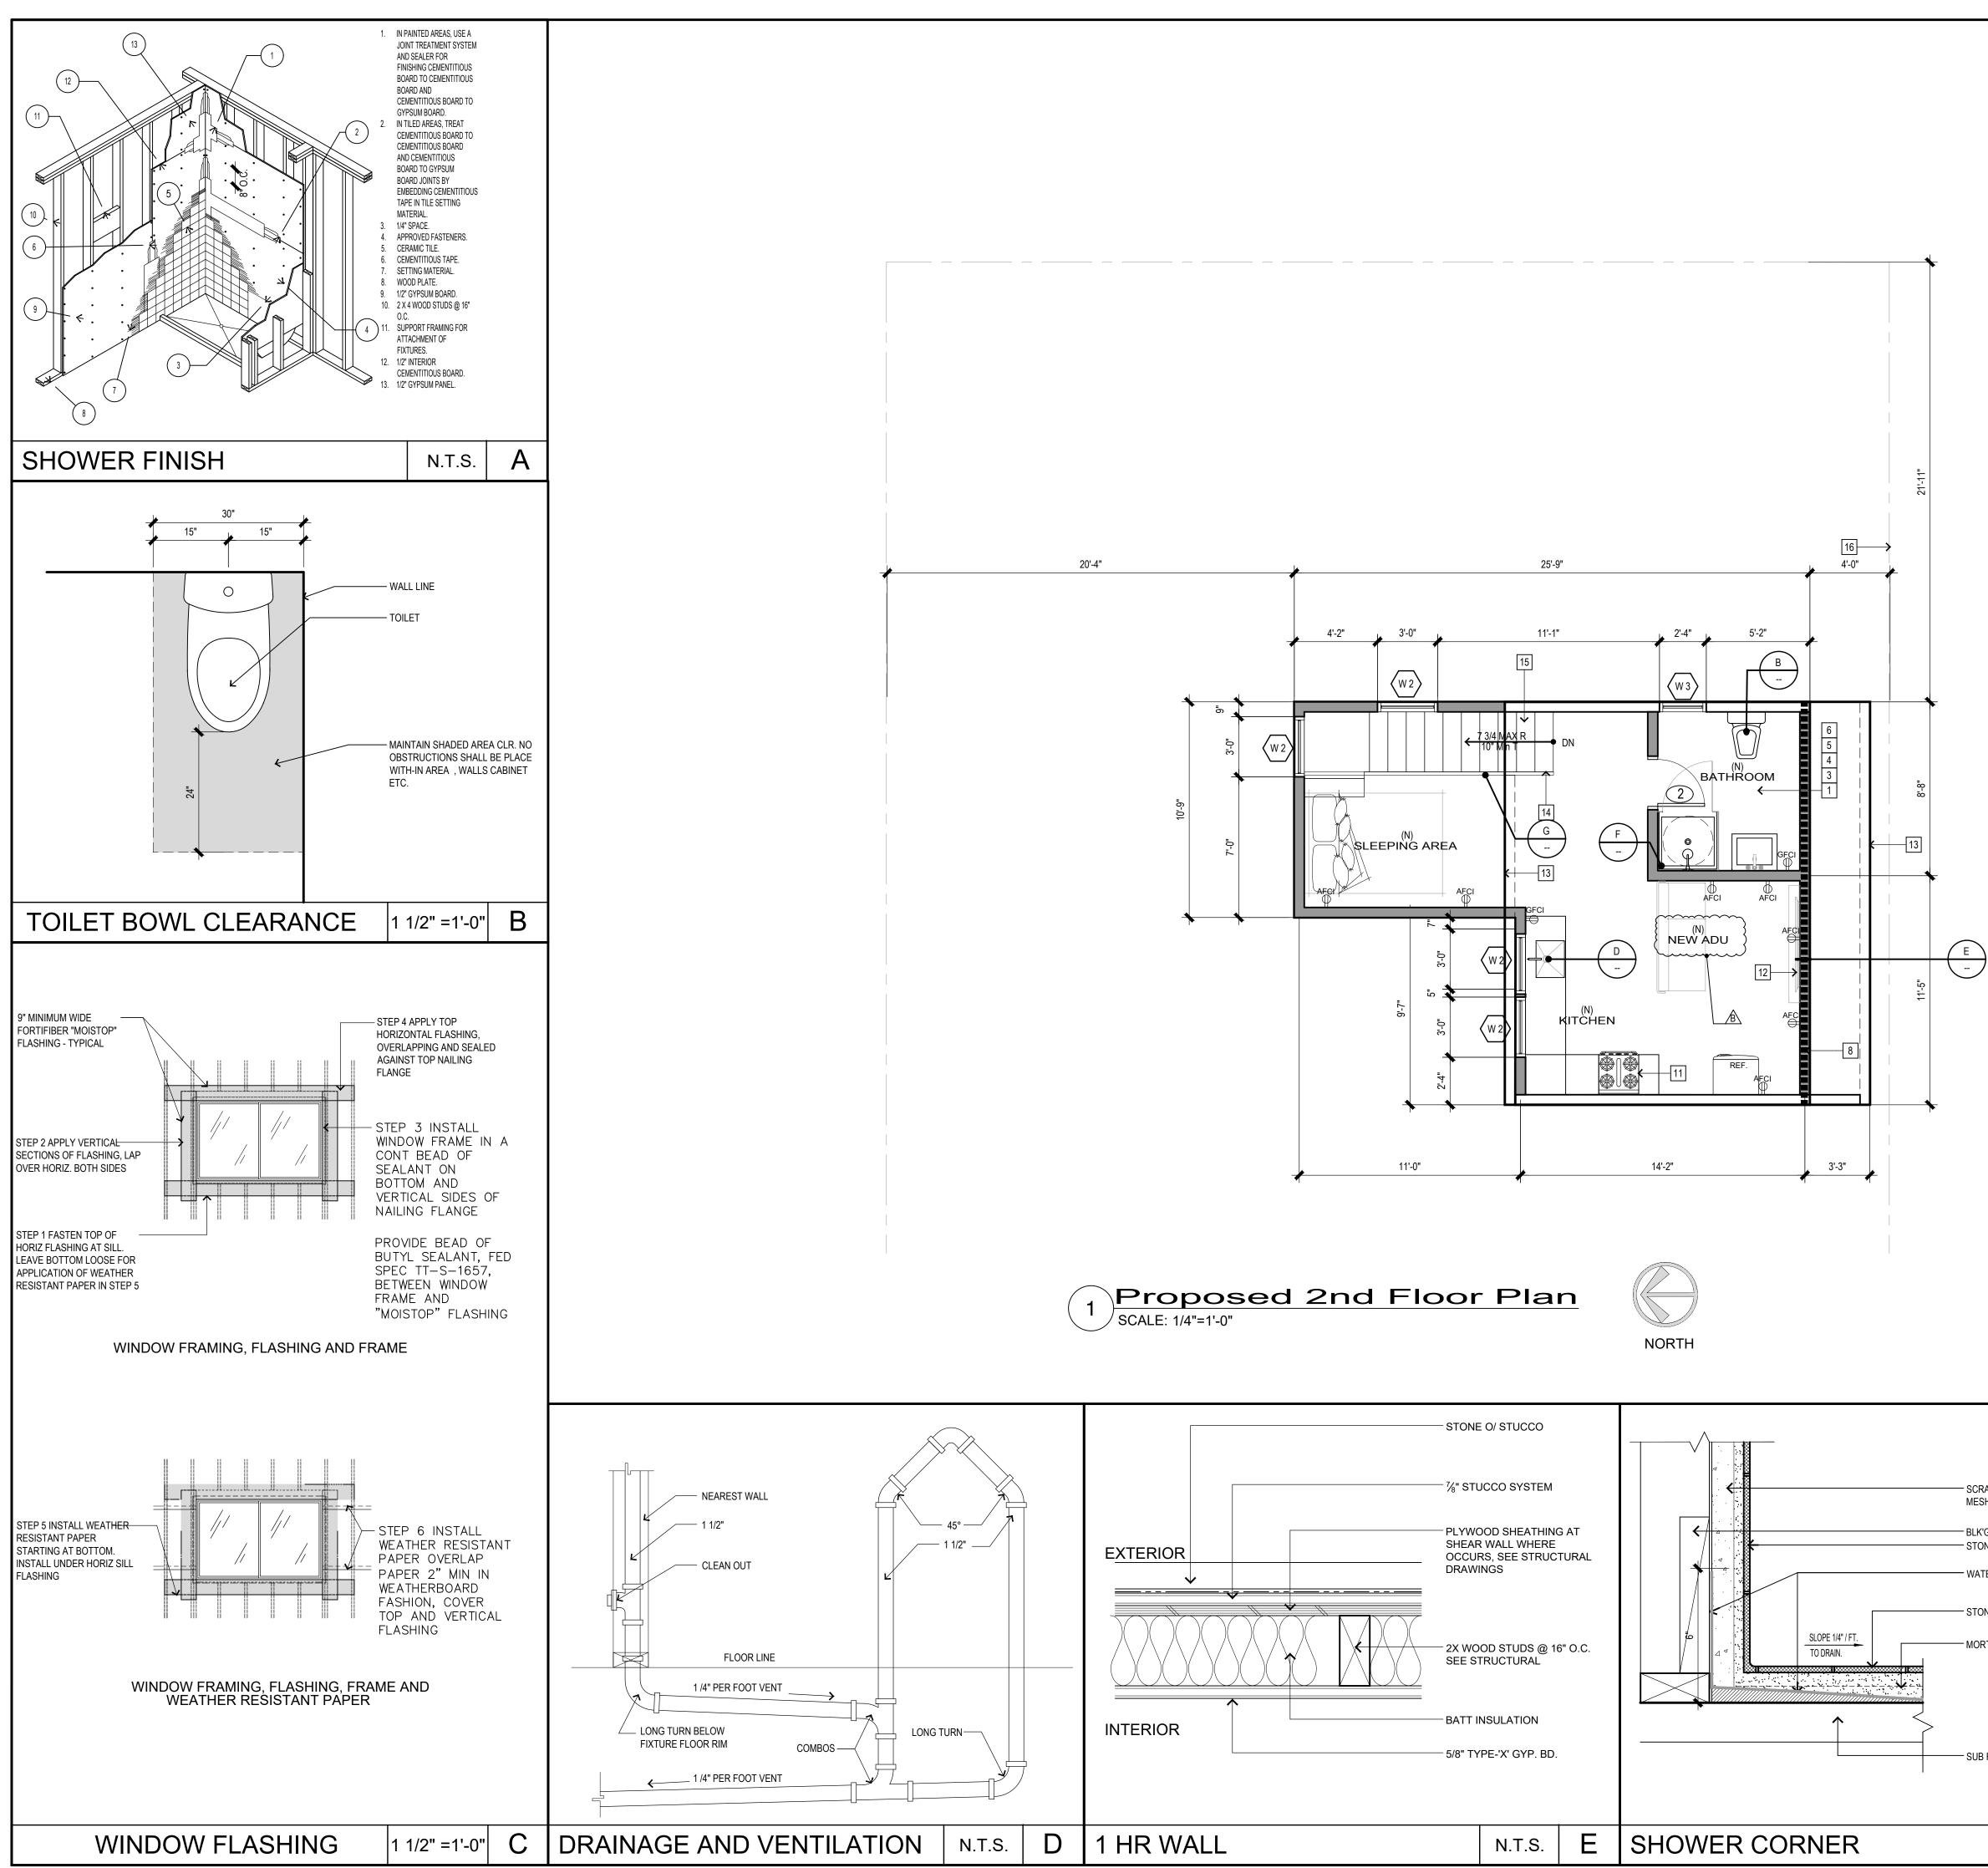
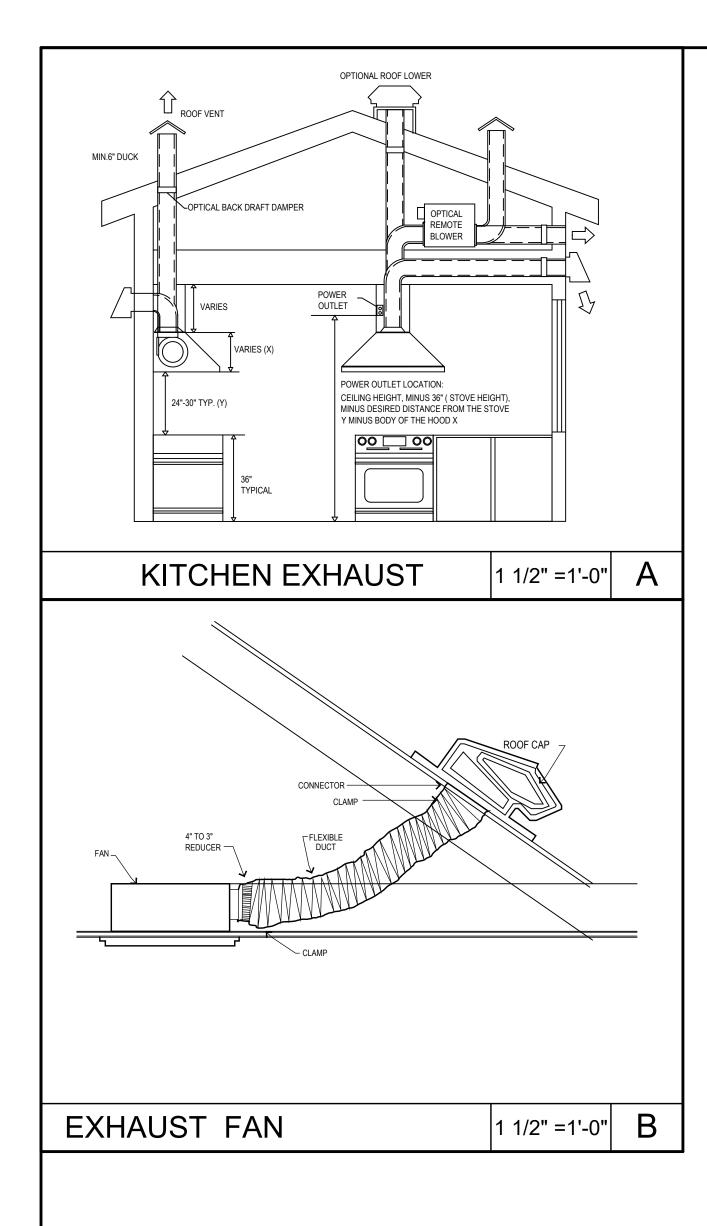
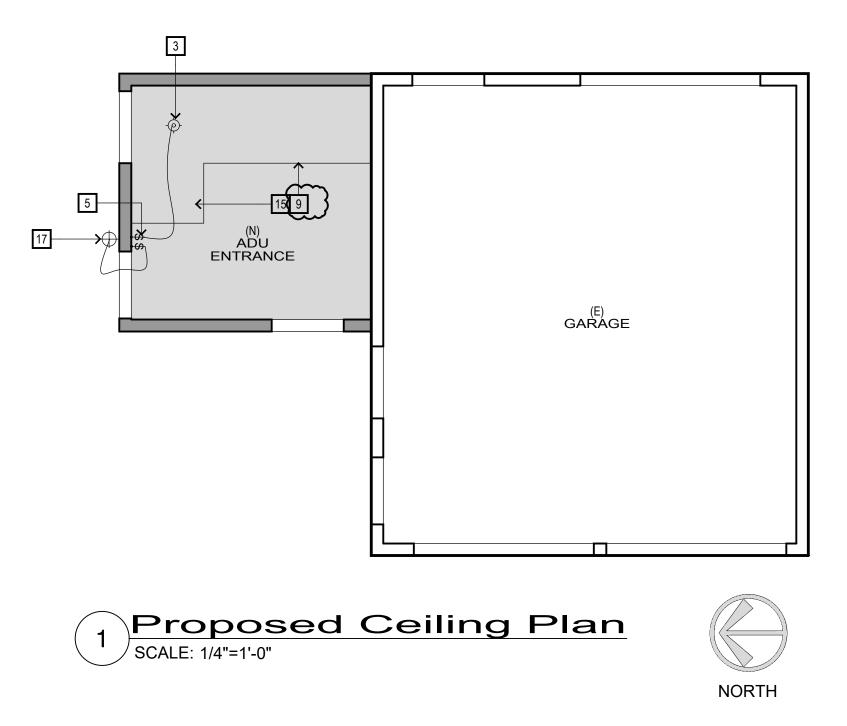
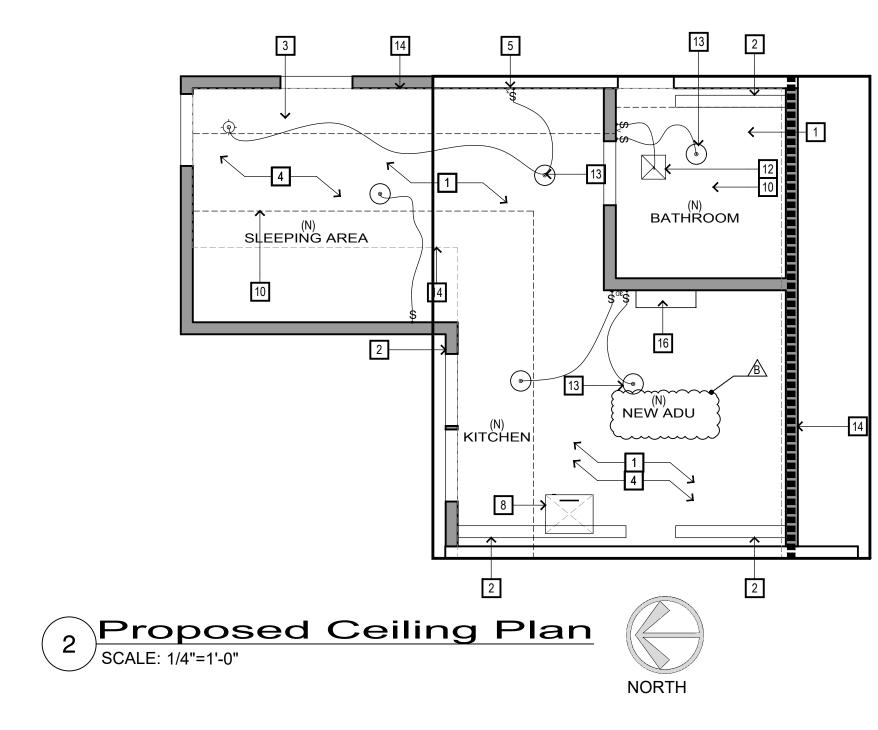
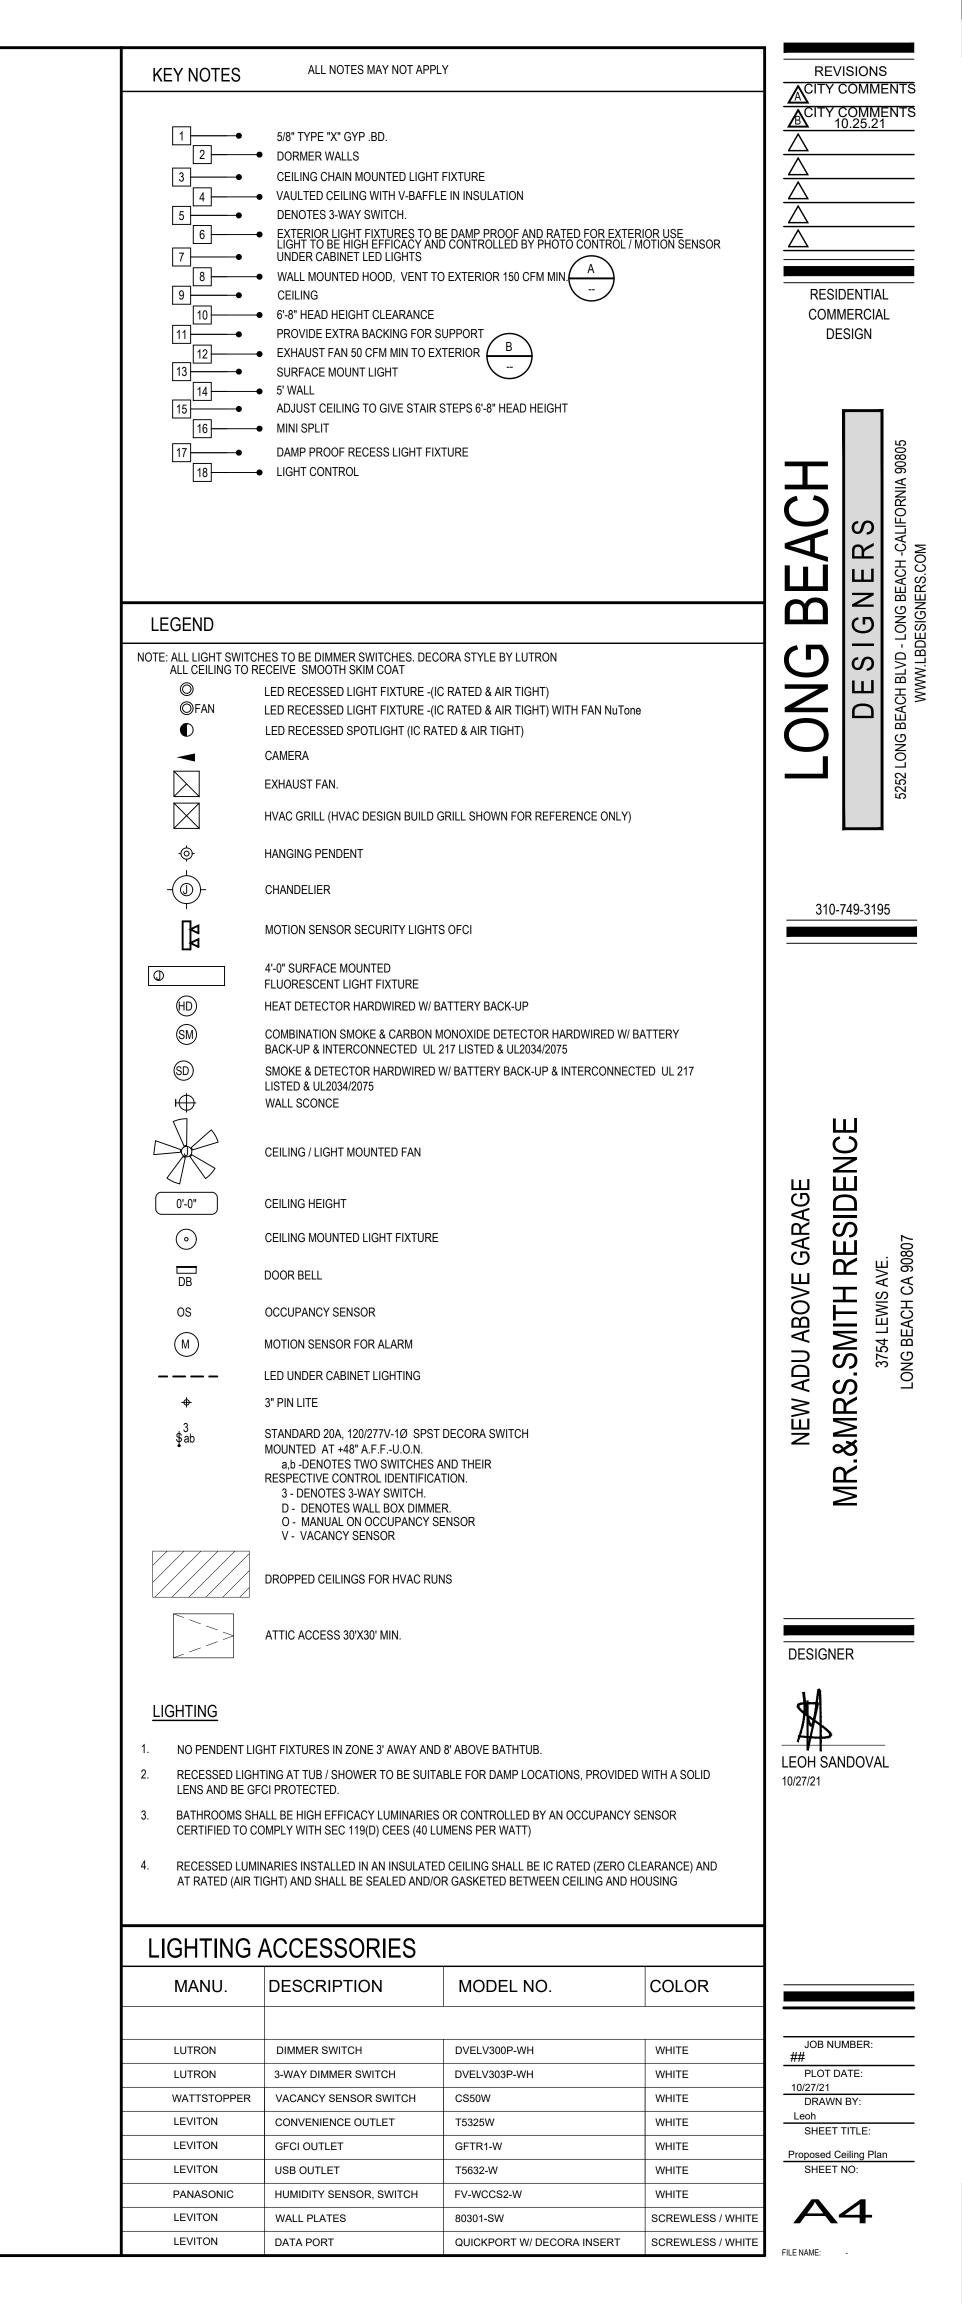



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WOOD WINDOWS TYP: C PROVIDE 30° LEAR WIDTH TOT WATER CLOSET COMPARTMENTS AND 24° CLEARANCE IN FRONT OF WATER CLOSET PROVIDE 30° LEAR WIDTH BEINCLOSINES SHALL BE TEMPERED. LAWNATED OR APPROVED PRASTIC INCLUDING WINDOWS WITH STEET OF TUR OR SHOWER ROOM THE PROVIDE AULT INGS MIN STEED FOR THE STEED CLEAR WIDTH STEET OF TUR OR SHOWER ROOM THE PROVIDE AULT INGS MIN STEED FOR THE STEED CLEAR WIDTH STEET OF TUR OR SHOWER ROOM THE STEED FOR THE STEED FOR THE STEED CLEAR WIDTH STEET OF TUR OR SHOWER ROOM THE STEED FOR THE STEED FOR THE STEED FOR SHOWER ROOM THE STEED FOR THE STEED FOR THE STEED FOR SHOWER ROOM THE STEED FOR THE STEED FOR SHOWER ROOM STEED FOR THE STEED FOR THE STEED FOR SHOWER ST. SILL HEIGHT STEED FOR SHOWER FEE WITH HE STEED FOR STEED FOR SHOWER ST. SILL HEIGHT STEED FOR SHOWER FEE WITH HE STEED FOR SHOWER ST. SILL HEIGHT STEED FOR SHOWER FEE WITH HE STEED FOR STEED FOR SHOWER ST. SILL HEIGHT STEED FOR SHOWER ST.
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			LONG BEAGH BEAGH DE SIGNERACH CALIFORNIA 90805 S252 LONG BEACH BLVD - LONG BEACH -CALIFORNIA 90805 WWW.LBDESIGNERS.COM
			310-749-3195
LEGEND			
SLOPE ROOF SLOPE X PER FO	OT MIN.	SOFFIT VENTS	
O'HAGINS FLAT VENTS		SHADED AREA INDICATES NEW ROOF AREAS	
AIR VENT INC. LINEAR F	RIDGE VENT		
			RAGE SIDENCE
			AGE IDE
NOTES			E GAR RES VE.
 ROOF EAVES OR ANY PROJECTION PROPERTY LINE. ALL GUTTERS, DOWNSPOUT AND ATTICS SHALL BE VENTILATED N CURRENT CALIFORNIA BUILDING BUILT UP FLAT ROOF AREAS SHA ALL OPENINGS IN ATTIC AREAS SWITH AN OPENING NOT GREATER PLYWOOD ROOF SHEATHING SH 	ALL HAVE A MINIMUM SLOPE OF 1/2" PEF SHALL BE PROTECTED BY A CORROSIVE	ESS THAN 5 FT. TO THE NIZED METAL. IG VENTILATED PER R FOOT. E RESISTANT WIRE MESH CKING AND BE INSTALLED	NEW ADU ABOVE GARAGE MR.&MRS.SMITH RESIDE 3754 LEWIS AVE. LONG BEACH CA 90807
			DESIGNER
АТТІС	VENT CALCULA	TION:	
TOTAL RO	OF AREA (RA):	502	
	VENTABLE ATTIC SPACE S.F.	3.3 S.F.	
REQUIRED Vent Type	VENTABLE ATTIC SPACE S.I. VENT FREE AREA PROVIDED	482 S.I. # VENTS TOTAL S.I.	JOB NUMBER: ##
RIDGE VENT	18 sq. in. net free vent area	11 198 S.I.	PLOT DATE: 10/27/21 DRAWN BY:
SOFFIT VENT	17.8 sq.in. net free vent area	8 142.4 S.I.	Leoh SHEET TITLE: Proposed Roof Plan
			SHEET NO:
	TOTAL PROVIDED	340.4 S.I.	FILE NAME: -



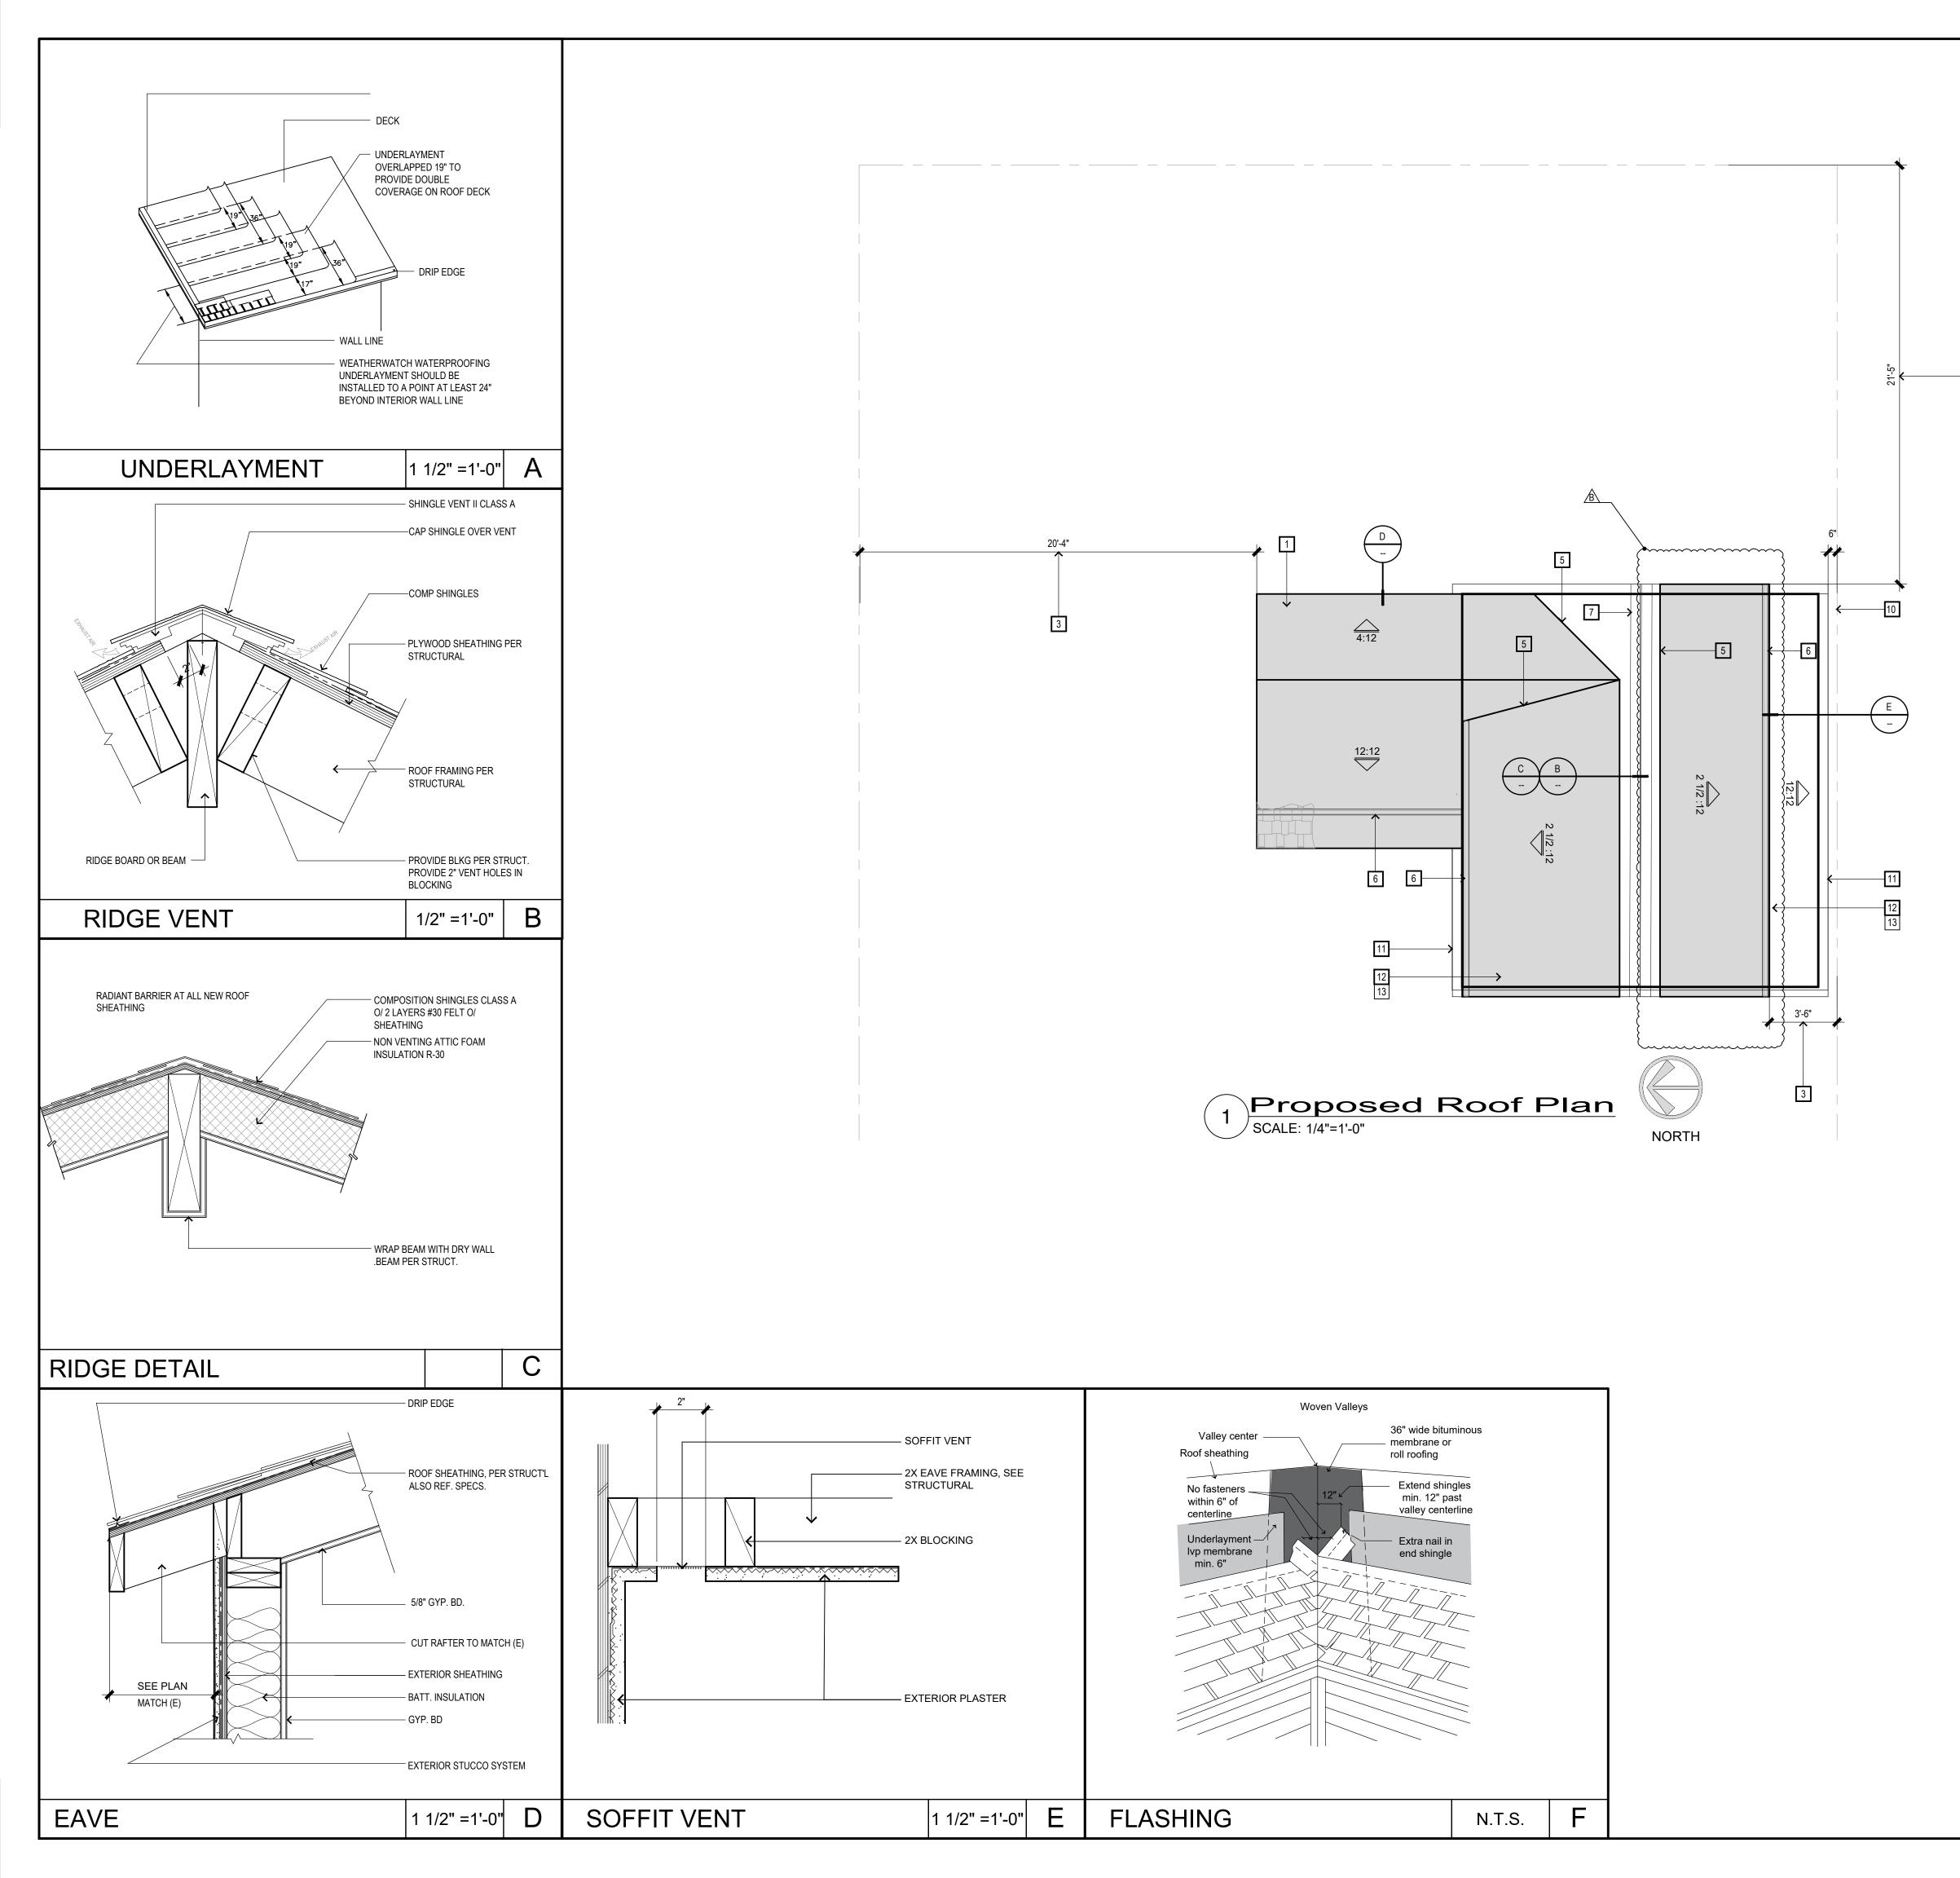