
SHELL AND CORE / TENANT IMPROVEMENT SUBMITTAL

# **OLYMPIX**

# **FITNESS**

4100 E. OCEAN BLVD. LONG BEACH, CA. 90803



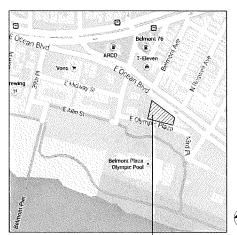

4100 E. OCEAN BLVD.-LONG BEACH, CA. 90803

VICINITY PLAN SCALE: N.T.S.

# **PROJECT SUMMARY**

## PROJECT DESCRIPTION:

THIS PROJECT IS A - CORE AND SHELL / TENANT IMPROVEMENT OF THE BUILDING INSTALL NEW AUTOMATIC FIRE EXTINGUISHING SYSTEM COMPLYING WITH (NFPA-13, EDITION 2013)

# ALL SIGNAGE UNDER SEPARATE PERMITS.

# SITE ADDRESS:

4100 E. OCEAN BLVD LONG BEACH, CA. 90803

AIN #: 7256-039-006

RESUB OF PART OF ALAMITOS BAY TOWNSITE LOTS 8,9,10,11,12 AND LOT 13 BLK 37

OCCUPANCY GROUP:	GROUP - B (E)	FIRST FLOOR					
	GROUP - A-1 (NEW)	PERFORMANCE ROOM:					
		GYM (FITNESS):					
		TRAINERS/BREAK ROOM/KIDS	3				
FIRST FLOOR:	15.312 SQ FT.	COMMON AREAS:	1				
SECOND FLOOR:	8,040 SQ FT.	(RESTROOMS, LOCKERS, RECEPTION)					
MEZZANINE :	1.258 SQ FT.	TOTAL 1st. FLOOR AREA:	1.				
****	.,	1					
TOTAL FLOOR AREA:	24,610 SQ FT.	2ND FLOOR AREA):					
		GYM (FITNESS):	9				
ennikiri enen.	VEC	BUSINESS (OFFICE):					

USE OF BUILDING:

4 NUMBER OF LEVELS: 2 (1ST, 2ND FLOOR AND MEZZANINE.)

5 CONSTRUCTION TYPE: TYPE - III-B

# 1,305.00 6,739.00 3,532.00 3,736.00 15,312.00 8,040.00 MEZZANINE AREA / FLAT ROOF: BUSINESS (OFFICE):

ROOF DECK COMMON AREAS (STAIRS, STORAGE, ELEVATOR)
TOTAL MEZZANINE AREA: 5,180.00

# DIRECTORY

# OWNER:

STRUCTURAL

ANDREW C. PARKER, P.E. 1635 38TH PLACE LOS ANGELES, CA. 90062 PH: (310) 522-7092

ELECTRICAL

Neil Tillson Foster Contact: Shane Foster 6477 El Paseo St. Long Beach, CA. 90815 T: (909) 241-8370

## CONSTRUCTION MANAGEMENT

PLUMBING / MECHANICAL

# **CODE NOTES**

PROJECT LOCATION 4100 E. OCEAN BLVD. LONG BEACH, CA. 908

# JURISDICTION CITY OF LONG BEACH

FERENCE CODES	
ILDING CODE:	2013 CALIFORNIA BUILDING CODE/ IBC WITH STATE ADMEND
	2013 CALIFORNIA PLUMBING CODE/ UPC IAPMO WITH STATE ADMEND
CHANICAL CODE:	2013 CALIFORNIA MECHANICAL CODE/ UMC IAPMO WITH STATE ADME
ECTRICAL CODE:	2013 CALIFORNIA ELECTRICAL CODE/ NEC IAPMO WITH STATE ADMEN
RE CODE:	2013 CALIFORNIA FIRE CODE/ IFC
E SAFETY CODE:	2013 CALIFORNIA FIRE CODE/ IFC
CESSIBILITY CODE:	2013 CALIFORNIA BUILDING CODE (TITLE 24, PART 2)
ERGY CODE:	2013 CALIFORNIA ENERGY CODE
CAL CODE:	CITY OF LONG BEACH ZONING MUNICIPAL
LGREEN:	2013 CALIFORNIA GREEN BUILDING CODE

# **DEFERRED SUBMITTALS**

- Automatic Fire Sprinkler Systems NFPA-13, 2013 Edition
- Fire Sprinkler Monitoring System NFPA-72, 2013 Edition

# **SHEET INDEX**

	SHEET INDEX
ID	Name
ARCHIT	ECTURAL SET
4.00.00	COVER SHEET
A.00.20	GENERAL NOTES_ABBREVIATIONS
4.00.30	TYPICAL INFORMATION
A.00.31	ADA
1.00.32	ADA (2)
A.00.40	SITE PLAN / EXITING PLAN
1.00.50	AS-BUILTS / DEMO PLAN
4.01.10	1ST. FL. FLOOR PLAN
01.11	RCF - FIRST FLOOR
1.01.12	1ST. FL. FURNITURE / FINISH PLAN
1.01.20	2ND. FLOOR PLAN
4.01.21	RCP - SECOND FLOOR
1.01.22	2ND. FL. FURNITURE / FINISH PLAN
A.01.30	MEZZANINE/ROOF LEVEL FLOOR PLAN
4.01.31	MEZZANINE/ROOF FINISH FL. / FURNITURE PLAN
1.01.32	RCP MEZZANINE/ROOF LEVEL
A.01.33	BOW TRUSS ROOF LEVEL PLAN
4.03.00	EXTERIOR ELEVATIONS
1.04.00	INTERIOR SECTIONS/ELEVATIONS
4.04.01	EAST-WEST SECTIONS
A.05.10	PLAN TYP. DETAILS
1.05.11	PLAN TYP. DETAILS
A.06.00	DOOR / WINDOW SCHEDULE
	TURAL SET
3.00.01	GENERAL NOTES
5.00.02	GENERAL NOTES, SYMBOLS, ABBREV.
.00.03	INSPECTIONS & STR ABBREVIATIONS
6.00.05	STEEL MOMENT FRAME STD. QUALITY ASSURANCE PLAN
3.00.06	STEEL MOMENT FRAME STD. QUALITY ASSURANCE PLAN
5.00.07	STEEL MOMENT FRAME STD. QUALITY ASSURANCE PLAN
3.00.10	TYP. CONCRETE DETAILS
3.00.11	TYP. CONCRETE AND CMU DETAILS
3.00.20	TYP, WOOD FRAMING DETAILS
6.00.22	SHEAR WALL DETAILS & SCHEDULE
5.00.90	EXISTING FNDN & DEMOLITION PLAN
5.00.91	EXISTING ROOF FRAMING & DEMOLITION PLAN
5.01.00	FNDN & 1ST FLR FRAMING PLAN
5.01.01	SECOND FLR FRAMING PLAN
3.01.02	FLAT ROOF LEVEL FRAMING PLAN
5.01.20	HIGH ROOF FRAMING PLAN
5.03.00	EXTERIOR ELEVATIONS
3.03.01	EXTERIOR ELEVATIONS
3.03.10	SMRF ELEVATIONS
5.03.20	WALL SECTIONS
3.04.00	ENLARGED PLANS
3.05.00	DETAILS
.05.01	DETAILS
3.05.03	DETAILS
3.05.04	DETAILS
	CAPE SET
1.0	COVER SHEET / NOTES
.1.1	GROUNDLEVEL PLANTING
1.2	ROOF PLANTING
.1.3	PLANTING DETAILS
2.0	IRRIGATION COVER SHEET / CALCULATIONS
.2.1	IRRIGATION GROUNDLEVEL PLANTING
2.2	IRRIGATION ROOF PLANTING
2.3	IRRIGATION DETAILS
CIVILE	NGINEERING
	BOUNDARY ESTABLISHMENT
!	IMPROVEMENT LOCATIONS
<u> </u>	TOPOGRAPHIC SURVEY
	ALLEY IMPROVEMENTS
:	ALLEY IMPROVEMENTS

# **PARKING TABULATION**

STORY	DESCRIPTION	SQFT.	SPACES REQUIRED		
	PERFORMANCE ROOM	1,305	4/1000		
	WEIGHT AREA	6,739	4/1000		
	TRAINERS OFFICE/RECEPTION				
1ST. FLOOR	BREAK ROOM / COMMON AREA	3,532	4/1000		
	KIDS ROOM / JUICE BAR				
	LOCKER ROOMS	3,736			
	BATHROOMS / STORAGE	3,/30			
	SUBTOTAL:	15,312			
STORY	DESCRIPTION	SQFT.	SPACES REQUIRED		
	OFFICE	599	4/1000		
	WORKOUT AREA	2,052	4/1000		
	BIKING	810	20/1000		
2ND. FLOOR	STRETCHING / COMMON	961	4/1000		
	AEROBICS / MIND BODY	2,125	20/1000		
	RESTROOMS / ELEVATOR / STAIRS	1,493	-		
	SUBTOTAL:	8,040			
STORY	DESCRIPTION	SQFT.	SPACES REQUIRED		
	OFFICE	999	4/1000		
MEZZANINE /	ROOF DECK	3,922	20/1000		
FLAT ROOF	STAIRWELL / STORAGE /	259			
	ELEVATOR	259			
	SUBTOTAL:	5,180	***************************************		



425 East 4th St. Unit E Long Beach California, 90802

Voice: (562) 450-0495 Fax: (562) 436-5222

**OLYMPIX FITNESS** 

4100 E. OCEAN BLVD LONG BEACH, CA. 90803

Revision Schedule Revision Revision Revision Number Description Date

01 BLDG, DEPT, SUBMITTAL 6/5/15

Drawn by:

# **CITRON DESIGN** GROUP

As noted

Sheet Description:

**COVER SHEET** 

Project No: KS-01 6/5/2015

A.00.00

# **GENERAL NOTES**

- VISIT THE SITE TO BECOME FAMILIAR WITH THE EXISTING CONDITIONS TO BETTER UNDERSTAND THE REQUIREMENTS OF THE CONTRACT DOCUMENTS. VERIFY ALL DIMENSIONS, ELEVATIONS AND CONDITIONS PRIOR TO BEGINNING ANY WORK AND NOTIFY THE ARCHITECT OF ANY DISCREPANCIES. DO NOT SCALE DRAWINGS.
- UNLESS OTHERWISE INDICATED ON THESE DRAWINGS OR IN THE PROJECT MANUAL AS BEING N.I.C. OR EXISTING, ALL ITEMS, MATERIALS, ETC. AND INSTALLATION OF THE SAME ARE PART OF THE CONTRACT DEFINED BY THESE DRAWINGS AND SPECIFICATIONS.
- SOLELY AS A CONVENIENCE TO THE OWNER AND CONTRACTOR, THE ARCHITECT MAY INCLUDE DOCUMENTS (OR INCORPORATE RECOMMENDATIONS) PREARABED BY CERTAIN OWNER CONSULTANTS INTO THE DOCUMENTS ISSUED BY THE ARCHITECT. IT IS EXPRESSLY UNIDERSTOOD AND AGREED THAT FOR ANY INFORMATION PROVIDED BY SAID CONSULTANTS, THE ARCHITECT ASSUMES NO LIDABILITY, REGARDLESS OF SUCH
- THE SOIL REPORT FOR THIS PROJECT IS FOR REFERENCE ONLY. NOTIFY THE ARCHITECT, ENGINEER AND OWNER OF ANY DISCREPANCY BETWEEN THIS REPORT AND THE PLANS OR SPECIFICATIONS PRIOR TO BEGINNING WORK.
- IN THE EVENT OF A DISCREPANCY BETWEEN PLANS AND SPECIFICATIONS, THE MORE STRINGENT REQUIREMENT SHALL APPLY.
- ALL WORK AND MATERIALS SHALL CONFORM TO THE LATEST ADOPTED UNIFORM BUILDING CODE (AS AMENDED), ALL ORDINANCES AND REGULATIONS OF THE CITY OR COUNTY WITH JURISDICTION, AND ANY SPECIAL REQUIREMENTS INDICATED IN THE BUILDING SUMMARY OR THESE GENERAL NOTES.
- ALL EXTERIOR SIGNAGE IS EXCLUDED FROM THIS CONTRACT. THE SIGN CONTRACTOR WILL OBTAIN SEPARATE APPROVALS AND PERMITS FROM GOVERNING AGENCIES FOR SIGNAGE.
- BE RESPONSIBLE FOR OBTAINING AND PAYING FOR ALL PERMITS, LICENSES, INSPECTIONS AND TESTING AS REQUIRED BY THE CONTRACT DOCUMENTS OR ANY GOVERNMENT AGENCY.
- PROVIDE ALL LABOR, MATERIALS, EQUIPMENT, TOOLS, TRANSPORTATION, UTILITIES, OTHER SERVICES AND RELATED TASKS NECESSARY FOR PROPER EXECUTION OF THE CONSTRUCTION REQUIRED BY THE CONTRACT DOCUMENTS.
- 10. ASSUME SOLE AND COMPLETE RESPONSIBILITY FOR JOBSITE CONDITIONS. COMPLY ASSUME SIZE AND COMPLETE RESPONSIBILITY FOR JOSSITE CONDITIONS. COMPLY WITH SAFETY REGULATIONS AND RESTRICTIONS AS REQUIRED FOR WORKER AND PEDESTRIAN PROTECTION DURING THE COURSE OF CONSTRUCTION OF THIS PROJECT. PROVIDE PROFIDECTION AS REQUIRED TO PREVENT ANY DAMAGE TO EXISTING CONSTRUCTION WITHIN AND ADJACENT TO THE JOSSITE. WHERE DAMAGE OCCURS, REPAIR OR REPLACE DAMAGED AREA AND/OR MATERIAL AS REQUIRED TO THE OWNER'S APPROVAL AT NO ADDITIONAL COST. THESE REQUIREMENTS SHALL APPLY CONTINUOUSLY AND NOT BE LIMITED TO NORMAL HOURS.
- BRING ANY REVISION OR ADDITIONAL WORK REQUIRED BY FIELD CONDITIONS OR LOCAL GOVERNING AUTHORITIES TO THE ATTENTION OF THE ARCHITECT BEFORE PROCEEDING.
- 12. VERIFY THE SIZE AND LOCATION OF ALL UTILITY LINES AND STUBS TO THE BUILDING(S) THAT ARE INDICATED ON THE PLANS. BRING ALL UTILITY LINES (WATER, SEWER, GAS AND ELECTRICAL, ETC), INTO THE BUILDING, FROM TERMINATION POINTS AS INDICATED ON THE SITE PLANS, READY FOR SERVICE PRIOR TO THE COMMENCEMENT OF THIS WORK, BRING ANY DISCREPANCIES TO THE ATTENTION OF THE ARCHITECT.
- 3. PRIOR TO PLACEMENT OF CONCRETE FOOTINGS AND SLABS, RETAIN THE SERVICES OF A PRIOR TO PROCEEDING OF CONCENT OF FOUR INSURED THE FORMS REGISTERED CIVIL ENGINEER OR LICENSED LAND SURVEYOR TO INSPECT THE FORMS FOR FOOTING PLACEMENT, LOCATION OF BUILDING PAD AND ELEVATION OF FINISHED FLOOR. SUBMIT SIGNED DOCUMENTATION TO THE ARCHITECT THAT THE FOREGOING CONFORM WITH THE APPROVED DRAWINGS. (SEE SAMPLE FORM IN THE PROJECT
- 14. NO ADDITIONAL ROOF OPENINGS OR ROOF MOUNTED EQUIPMENT BEYOND THAT WHICH IS SHOWN ON THESE PLANS SHALL BE ALLOWED WITHOUT WRITTEN CONSENT OF THE ARCHITECT ANDION STRUCTURAL ENGINEER.
- NO STRUCTURAL MEMBER SHALL BE CUT FOR PIPES, A.C. DUCTS, ETC., UNLESS SPECIFICALLY DETAILED AND/OR APPROVED BY THE STRUCTURAL ENGINEER.
- 6. ALL SHOP WELDING IS TO BE DONE IN A CERTIFIED LICENSED SHOP. ALL FIELD WELDING SHALL BE DONE ONLY BY LICENSED WELDERS UNDER CONTINUOUS SPECIAL INSPECTION, WITH CERTIFICATE ISSUED AS REQUIRED BY THE BUILDING OFFICIAL.
- WHERE LARGER STUDS AND/OR FURRING ARE REQUIRED TO COVER DUCTS, PIPING, COL UMNS, SADDLES, BOLTS, CONDUIT, ETC., THE LARGER SIZE STUD AND/OR FURRING SHALL EXTEND THE FULL LENGTH AND HEIGHT OF THE SURFACE WHERE THE FURRING OCCURS.
- SHOULD ANY ASPHALTIC CONCRETE REQUIRE PATCHING ADJACENT TO BUILDINGS, IT SHALL BE OF THE SAME SECTION AND DRAINAGE PROFILE AS THE ADJACENT PAYED AREAS.
- SEALALL OPEN JOINTS IN THE EXTERIOR BUILDING ENVELOPE TO PREVENT AIR AND WATER INFILTRATION. COMPLY WITH ANY FIRE RATING REQUIREMENTS.
- 20. ALL FLOORS IN PUBLIC AREAS SHALL HAVE NON-SLIP SURFACES IN COMPLIANCE WITH DIVISION 18 OF THE "HEALTH AND SAFETY CODES" OF THE STATE OF CALIFORNIA.
- 21. WHERE EXIT DOORS SWING OUT OVER THE LANDING, THE LANDING SHALL NOT BE MORE THAN 1/2" BELOW THE THRESHOLD.
- 22. ALL EXTERIOR OPENINGS SHALL COMPLY WITH THE CITY SECURITY ORDINANCES.
- 23. NO BUILDING OR PORTION OF A BUILDING SHALL BE OCCUPIED OR USED FOR STORAGE PRIOR TO THE ISSUANCE OF THE CERTIFICATE OF OCCUPANCY, APPROVAL FOR OCCUPANCY IS ONLY GRANTED AFTER ACCEPTANCE BY GOVERNING AGENCIES.
- SITE DEVELOPMENT AND GRADING SHALL BE CONSTRUCTED TO PROVIDE ACCESS TO ALL ENTRANCES AND EXTERIOR GROUND FLOOR EXITS, AND ACCESS TO NORMAL PATHS OF TRAVEL, AND WHERE NECESSARY TO PROVIDE ACCESS, SHALL INCORPORATE PEDESTRIAN RAMPS, CURB RAMPS, ETC.
- DURING PERIODS OF PARTIAL OR RESTRICTED USE OF A BUILDING OR FACILITY, THE ENTRANCES USED FOR PRIMARY ACCESS SHALL BE ACCESSIBLE TO AND USABLE BY PERSONS WITH DISABILITIES.
   SEE SHEETS AGO OF TO AGO OF FOR TYPICAL ACCESSIBILITY DETAILS AND NOTES.

INCLUDED AS A DEPARTMENT OF FIRE PREVENTION REQUIREMENT.

**FIRE NOTES** 

- THE MAXIMUM FLAME SPREAD CLASSIFICATION OF FINISH MATERIAL USED ON INTERIOR WALLS AND CEILINGS SHALL NOT EXCEED THAT SET FORTH IN THE UNIFORM BUILDING CODE (UBC).
- PROVIDE FIRE STOPPING TO CUT OFF ALL CONCEALED DRAFT OPENINGS (BOTH VERTICAL AND HORIZONTAL) AT 10' 0" O.C. EACH WAY.
- FOR EACH BUILDING SPACE PROVIDE 4" HIGH ADDRESS NUMBERS, REVERSE READING, CONTRASTING COLOR: SIMILAR TO LETTERSET "FUTURA BOLD." MOUNT DIRECTLY ABOVE ENTRANCE DOORS OR CONSPICUOUS LOCATION SO THEY ARE VISIBLE FROM THE STREET. PROVIDE FRONT READING AT REAR DOORS. FOR EACH MAJOR TENANT PROVIDE 12" HIGH, 34" THICK, INTEGRALLY COLORED ACTYLIC NUMBERS. VERROY SIZE AND LOCATION WITH FIRE DEPARTMENT.
- PROVIDE A COMPLETE SUPERVISED AUTOMATIC FIRE SPRINKLER SYSTEM IN STRICT ACCORDANCE WITH THE FIRE DEPARTMENT REGULATIONS. SUBMIT PLANS BY A LICENSED FIRE SPRINKLER CONTRACTOR DIRECTLY TO THE FIRE DEPARTMENT. BUILDING DEPARTMENT AND TENANT INSURANCE COMPANY FOR REVIEW AND APPROVAL. SUBMIT SHOP DRAWINGS TO THE ARCHITECT PRIOR TO INSTALLATION, WITH ALL APPROVALS STAMFED THEREON.
- EXIT SIGNS SHALL MEET THE REQUIREMENTS OF THE BUILDING AND FIRE CODES. SEE FLOOR PLANS, REFLECTED CEILING PLANS, AD ELECTRICAL LIGHTING PLANS FOR LOCATION OF EXT LIGHTING. PROVIDE EXIT PATH LIGHTING GIVING A VALUE OF ONE FOOT CANDLE MINIMUM AT FLOOR LEVEL. ILLUMINATED EXIT SIGNS SHALL BE POWERED FROM SEPARATE CIRCUITS AND SEPARATE SOURCES.
- ALL EXIT DOORS SHALL BE OPENABLE FROM THE INSIDE WITHOUT THE LISE OF A KEY. ALL EXIL SOCIOS SHALL OF OPENABLE FROTT. THE MAIN EXIT DOOR MAY HAVE KEY OFERATED HARDWARD AND SHALL BE LABELED "THIS DOOR TO REMAIN EXIT DOOR TO THE MAIN EXIT DOOR TO THE MAIN KEY OFERATED HARDWARD SHALL BY LABELED "THIS DOOR TO REMAIN CONTRASTING BACKGROUND. EFFORT TO OFERATE IS NOT TO EXCEED 5 LBS. FOR EXTERIOR AND INTERIOR DOORS AND IS LBS. FOR IS NOT REATED BOORS.
- WITHIN A STRUCTURE MAINTAIN AISLES LEADING TO REQUIRED EXITS CONTINUOUSLY TO A PUBLIC WAY OR APPROVED REFUGE AREA.
- INTAIN A EXTERIOR WALKWAYS WITH A MINIMUM WIDTH OF 48" TO A PUBLIC WAY.
- 10. ONE-HOUR FIRE RATED CORRIDORS SHALL HAVE DOOR OPENINGS PROTECTED BY TIGHT-FITTING SMOKE AND DRAFT CONTROL ASSEMBLIES WITH A 20 MINUTE LABEL. DOORS SHALL BE MAINTAINED SELF-CLOSING. DOORS SHALL BE GASKETED TO PROVIDE A SMOKE AND DRAFT SEAL.
- PROVIDE FIRE DAMPERS WHERE DUCTWORK PENETRATES A FIRE RATED WALL OR CEILING ASSEMBLY
- DURING CONSTRUCTION AND/OR DEMOLITION, PROVIDE A PORTABLE FIRE EXTINGUISHER WITH A RATING OF NOT LESS THAN 2A OR 2A 10BC WITHIN 75' TRAVEL DISTANCE OF ALL PORTIONS OF THE BUILDING ON EACH FLOOR.
- 3. AT THE TIME OF OCCUPANCY PERMIT, PROVIDE EXTINGUISHERS OF THE SIZE AND TYPE REQUESTED BY THE FIRE OFFICIAL. FIRE EXTINGUISHERS LOCATIONS SHALL BE DETERMINED BY FIELD INSPECTION IF NOT INDICATED ON THE APPROVED PLANS. LOCATIONS SHALL BE AGREED UPON BY THE INDIVIDUAL TENANTS AND THE FIRE OFFICIAL. ALL PIRE EXTINGUISHERS TO HAVE UL. APPROVAL
- PRIOR TO DELIVERY OF COMBUSTIBLE BUILDING MATERIAL TO THE PROJECT SITE, THE SITE WATER SYSTEM SHALL PASS ALL REQUIRED TESTS AND BE CONNECTED TO THE PUBLIC WATER SUPPLY SYSTEM. IN ADDITION, AN APPROVED ALL WEATHER ROAD SHALL BE IN PLACE TO PROVIDE ADEQUATE AND PERMANENT ACCESS FOR EMERGENCY VEHICLES.
- MAINTAIN GOOD HOUSEKEEPING AT ALL TIMES. ACCUMULATION OF COMBUSTIBLE WASTE MATERIALS IN THE BUILDING IS NOT ALLOWED.
- PROTECT ABOVE GROUND GAS METERS, REGULATORS, SWITCHGEAR AND PIPING EXPOSED TO VEHICULAR TRAFFIC IN AN APPROVED MANNER.
- . ALL INSULATION MATERIAL, INCLUDING FACINGS, SUCH AS VAPOR BARRIERS OR BREATHER PAPERS INSTALLED WITHIN FLOOR-CEILING ASSEMBLIES, ROOF-CEILING ASSEMBLIES, WALLS, CRAWL SPACES OR ATTICS SHALL HAVE A FLAME-SPREAD RATING NOT TO EXCEED 28 AND A SMOKE DENSITY NOT THE EXCEED 48).
- PER LBMC, ADDRESSES SHALL BE EITHER INTERNALLY OR EXTERNALLY ILLUMINATED.

	AND	M M.B.	MACHINE BOLT
	ANCHOR BOLT ASPHALTIC CONCRETE	M.H. M.O.	MANHOLE MASONRY OPENING
	ACOUSTICAL CEILING TILE	M.T.T.	MAIN TELEPHONE TERMIN
	AREA DRAIN ABOVE FINISH FLOOR	MAX.	MAXIMUM MECHANICAL
~~~~~	AIR CONDITIONING	MEZZ.	MEZZANINE
	ABOVE ACOUSTICAL	MFR. MIN.	MANUFACTURER MINIMUM
	ALUMINUM	MISC.	MISCELLANEOUS
OX.	APPROXIMATE ARCHITECTURAL	MTD. MTL.	MOUNTED METAL
	PROTITECTORAL	LR II I	MULLION
	BOTTOM OF	N	
	BOARD BUILDING	N. N.I.C.	NORTH NOT IN CONTRACT
	BLOCK	N.T.S.	NOT TO SCALE
	BLOCKING BEAM	NO. NOM.	NUMBER NOMINAL
	воттом	o o	Promine.
l	BETWEEN	O.A.	OVERALL
	CATCH BASIN	O.C.	ON CENTER OUTSIDE DIAMETER
	CASTIRON	O.F.D.	OVERFLOW DRAIN
	CONTROL JOINT CONCRETE MASONRY UNIT	O.H. O/	OVERHEAD OVER
	CENTER OF	OPNG.	OPENING
	CLEANOUT	OPP.	OPPOSITE
	CABLE TELEVISION CEMENT	OPPH.	OPPOSITE HAND
	CERAMIC	<del> </del>	POUND OR NUMBER
ST	CENTERLINE CEILING JOIST	P.L.	PROPERTY LINE
<u></u>	CEILING	P.O.C. P.T.	POINT OF CONNECTION PRESSURE TREATED
JB	CLEAR	PLAS.	PLASTER
НВ	CONCEALED HOSE BIBB CONDUIT	PLBG. PLYWD.	PLUMBING PLYWOOD
	COUNTER	PR.	PAIR
).	CONCRETE	PTN.	PARTITION
TR.	CONSTRUCTION	Q.T.	QUARRY TILE
	CONTINUOUS		QUARAT TILE
R.	CONTRACTOR	R R.	RADIUS
	DRINKING FOUNTAIN	R.D.	ROOF DRAIN RIGHT HAND
	DOWNSPOUT	R.H.B.	RECESSED HOSE BIBB
	DOUBLE DEPARTMENT	R.O.	ROUGH OPENING
	DETAIL	R.O.W.	RIGHT OF WAY RESAWN
3)	DIAMETER DIMENSION	REF.	REFERENCE
~~~~	DOWN	REFG.	REFRIGERATOR REINFORCED
. FIR	DOUGLAS FIR DOOR	REQD.	REQUIRED
	DETAIL	RESIL.	RESILIENT
	DRAWING	REV.	REVISION ROOM
		RWD.	REDWOOD
	EAST EVP. COOLING UNIT	s	
	EXTERIOR INSULATION	S.	SOUTH
	FINISH SYSTEM EXPANSION JOINT	S.A.T. S.B.	SUSP. ACQUISTICAL TILE SPLASH BLOCK
	ELECTRICAL PANEL	S.C.	SOLID CORE
	EACH WAY EACH	S.D. S.F.	STORM DRAIN SQUARE FOOT/FEET
	ELEVATION	S.O.V.	SHUT OFF VALVE
	ELECTRICAL	SCHED. SECT.	SCHEDULE SECTION
<b>&gt;</b> .	EQUAL EQUIPMENT	SHT.	SHEET
·	EXISTING	SHTHG.	SHEATHING SIMILAR
	EXTERIOR	SPEC.	SPECIFICATION
	FLOOR DRAIN	SQ.	SQUARE
	FIRE HYDRANT	SS.	SERVICE SINK STAINLESS STEEL
	FLOW LINE	STD.	STANDARD
	FACE OF MASONRY FACE OF STUD	STL.	STEEL
	FINISH SURFACE	STOR. STRUCT	STORAGE STRUCTURAL
	FINISH FLOOR FOUNDATION	SYM.	SYMBOL
	FINISH	SYMM.	SYMMETRICAL
	FIXTURE	T&G	TONGUE AND GROOVE
иT	FLOOR MOUNTED	T.G.	TEMPERED GLASS
SK.	FLOOR SINK	T.J. T.O.	TRUSS JOIST TOP OF
R	FLUORESCENT FOOT/FEET	T.O.B.	TOP OF BEAM
	FOOTING	T.O.C.	TOP OF CURB TOP OF PARAPET
	FURRING	T.O.P. T.O.S.	TOP OF SHEATHING
	FUTURE	T.O.W.	TOP OF WALL
	GROUND	T.S.	TUBE STEEL TELEPHONE
	GENERAL CONTRACTOR	THK.	THICK
	GALVANIZED IRON GAUGE	TYP.	TYPICAL.
	GALVANIZED	U	LINI ESS OTHERWISE MOT
AM.	GLASS GULLIAM BEAM	U.O.N.	UNLESS OTHERWISE NOTE
- IVI	GLU-LAM BEAM GRADE	V.T.R. VERT.	VENT THROUGH ROOF
	GYPSUM	VERT.	VERTICAL.
	Nich	W.	WEST
	HIGH HOSE BIBB	W.C.	WEST WATER CLOSET
	HOLLOW CORE	W.H.	WATER HEATER
	HOLLOW METAL HEADER	W.W.F.	WELDED WIRE FABRIC WITH
		W/O	WITHOUT
	HARDWARE		
	HARDWOOD	WD.	WOOD
	HARDWOOD HORIZONTAL HEIGHT		WOOD
`	HARDWOOD HORIZONTAL HEIGHT		WOOD
	HARDWOOD HORIZONTAL HEIGHT HEATING, VENTILATION & AIR CONDITIONING		WOOD
	HARDWOOD HORIZONTAL HEIGHT		WOOD
). Z.	HARDWOOD HORIZONTAL HEIGHT HEATING, VENTILATION & AIR CONDITIONING HIGHWAY INSIDE DIAMETER		WOOD
2.	HARDWOOD HORIZONTAL HEIGHT HEATING, VENTILATION & AIR CONDITIONING HIGHWAY		WOOD

**GRAPHIC SYMBOLS** CONSTRUCTION (A)GRID LINE (FACE OF STUD, FACE OF MASONRY, AND CENTERLINE OF COL.) (1) SECTION CALLOUT (BUILDING) SECTION CALLOUT (PARTIAL) EXTRIOR ELEVATION INDICATOR INTERIOR ELEVATION IDENTIFICATION ## A##.## DETAIL IDENTIFICATION ROOM NAME ## A: ###.# sq ft H: ###.##\* ROOM NAME AND NUMBER (SEE INTERIOR FINISH SCHEDULE) **(##**) KEYNOTE SYMBOL DOOR NUMBER - SEE DOOR SCHEDULE

WINDOW TYPE ELEVATION

CEILING HEIGHT MATERIAL/FINISH SYMBOL

DATUM


(X-X\*)


 $\langle x \rangle$ 

SITE PLAN

PROPERTY LINE PARCEL LINE WATER METER BOX, REFER TO CIVIL PLANS GAS METER, REFER TO BUILDING PLANS LITELITY PULL BOX DOUBLE DETECTOR CHECK FIRE DEPARTMENT CONNECTION, REFER TO CIVIL PLANS FIRE HYDRANT, REFER TO CIVIL PLANS POST INDICATOR VALVE, REFER TO CIVIL PLANS IRRIGATION CONTROLLER, REFER TO LANDSCAPING PRESSURE REGULATOR PRESSURE REGULATOR
PARKING LOT LIGHT, REFER TO ELECTRICAL PLANS
AND CIVIL PLANS FOR NUMBER OF HEADS
ADA PATH OF TRAVEL
FIRE LANE MARKINGS (PAINTED RED CURBS) 

# FLOOR PLAN

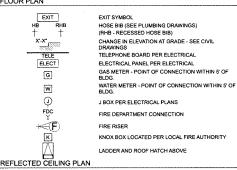

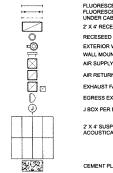

FLUORESCENT STRIP FIXTURE FLUORESCENT PENDANT FIXTURE UNDER CABINET FLUORESCENT FIXTURE 2' X 4' RECESSED FLUORESCENT LIGHT FIXTURE RECESEED DOWNLIGHT EXTERIOR WALL SCONCE LIGHTING FIXTURE VALL MOUNTED EXTERIOR WALL PACK AIR SUPPLY - SEE MECHANICAL PLANS AIR RETURN REGISTER - SEE MECHANICAL PLANS EXHAUST FAN - SEE MECHANICAL PLANS EGRESS EXTERIOR WALL LIGHTING FIXTURE J BOX PER ELECTRICAL PLANS

2' X 4' SUSPENDED T-BAR CEILING GRID WITH ACOUSTICAL TILE

CEMENT PLASTER SOFFIT GYPSUM BOARD CEILING



ROOF PLAN

SKYLIGHT WHERE OCCURS

ROOF HATCH VERTICAL LOUVERED VENTS



425 East 4th St. Unit E Long Beach California, 90802

Voice: (562) 450-0495 Fax: (562) 436-5222

WALL TYPE IDENTIFICATION STRUCTURAL COLUMN - SEE STRUCTURAL DRAWINGS CHANGE IN ELEVATION AT GRADE - SEE CIVIL DRAWINGS

**FITNESS** 4100 E. OCEAN BLVD LONG BEACH, CA. 90803 OLYMPIX

Revision Schedule Revision Revision Revision Number Description Date

01 BLDG, DEPT, SUBMITTAL 6/5/15

Drawn by:

**CITRON DESIGN GROUP** 

As noted

Sheet Description:


**GENERAL NOTES ABBREVIA** TIONS

Project No:

KS-01 6/5/2015

A.00.20



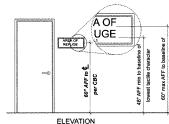

LOCATION FOR PERMANENT & TACTILE SIGNS

EATI DUON SISTED.

Doors at exit passageways, discharge, and stairways shall have <u>reised charact</u>
era and <u>brallle</u> signage stating "Exit", "Exit stair down", "Exit ramp down",
"Exit route" (fl door exits directly to exterior win ostairs/ramp). "To
Exit" (if door exits thru horizontal exit) etc as appropriate per CBC

INFORMATIONAL SIGNS
- Informational signs (ie occupant load, rules of conduct, etc) shall have visual ch

# aracters - Building directories & building addresses do not need to comply

DIRECTIONAL SIGNS

- Directional signs (le directions to rooms or spaces including ider ass routes shall have <u>visual</u> characters

AREAS OF REFUGE
Instructions in areas of refuge shall have <u>visual</u> characters
Space shall be indentified as a permanent room sign stating "Area of Refuge"

along with an ISA at door

# RESTROOM SIGNS

Restroom signs to have <u>raised characters</u>, <u>braille</u>, <u>pictogram</u>, and 6" min <u>ISA</u>

Additional restroom ID signs to be located on doors per CBC

# LOCATION OF PERMANENT ROOM AND/OR TACTILE SIGNS - Provide sign at latch side of door - Double doors - tocate on right side of right door - Double doors with one inactive leaf - locate sign on inactive leaf

If there is not enough space on latch side of single door or right side of double d

oors, locate sign on nearest adjacent wall *preferably on right per CBC*- Signs with tactile characters shall be permitted on the push side of doors that h

position

Mounting location should allow a person to appendent of the person of the pe

# - Provide ISA

Provide a sign stating "This check stand to be open at all times for customers with disabilities" per CBC



**PICTOGRAM** 



FUG BRAILLE DETAIL

AREA OF REFUGE

RAISED CHARACTER

Upper case

- Sans Serf - not italics, script, or highly decorative

- Sans Serf - not italics, script, or highly decorative

- Width of uppercase letter "I": width:ht ratio of
3:5 to 1:1 per CBC

3.5 to 1.1 per CBC

Height shall be 56" to 2" based on the uppercase letter "I"; if visual characters with the same information are provided, raised characters can be ½" min.

Stroke thickness shall be 15% of uppercase letter "I"; width:ht ratio of 1:5 to 1:10 per CBC.

Characters to be separated from raised borders 36" min.

TACTILE - BRAILLE
Farille to be Contracted Grade 2 Braille; CA Contracted Grade 2 Braille per CBC
Braille lots be Contracted Grade 3 Braille per CBC
Braille lots that have counted or domed shape and comply with ADA Table 703.3.1

CA Braille dots to be 1/10° on centers in each call with 2/10° space between cells and rail sed 1/40° per CB

Be positioned below the text; Braille shall be separated ½ min from any raised borders or letters & ½; max per CBC

Where raised characters are multi-lined, braille should be placed together below the text

VISUAL CHARACTERS

Required signs to have visual characters

Visual characters do not need to be used if the sign has both raised characters and braille

If visual only, characters can be upper or lower case or combination and can not be italics or hi

ghly decorative

- Width of uppercase letter "O" is 55% to 110% of the uppercase letter "I"; width:ht ratio of 3:5 to 1:1 per CBC

hin AFF

40° - 70° AFF and < 72° viewing distance - 5i8° ht characters

40° - 70° AFF and < 72° viewing distance - 5i8° ht + 18° ft of viewing distance

70° - 120° AFF and ≥ 72° viewing distance - 2° ht + 18° ft of viewing distance

70° - 120° AFF and ≥ 180° weing distance - 2° ht + 18° ft of viewing distance

> 120° AFF & 2 12° viewing distance - 3° HT characters

> 120° AFF & ≥ 21° viewing distance - 3° HT it 18° FT of viewing distance

Suspended or overhead to have a ht of 3° min measured using an uppercase \*X° per CBC

Stroke thickness shall be 10%-30% of uppercase letter 11°; width:ht ratio of 1:5 to 1:10 per 2BC

CBC

Character spacing to be 10%-35% of character ht

Line spacing to be 35%-70% of character ht

Character and their beckground shell have a non-glare finish and shall contrast (i.e. light on d ark or dark on light) PICTOGRAMS

- If pictograms are required they shall be located in a separate field with 6° min ht
- Pictograms and their fields shall have a non-glare finish and shall contrast (i.e. light on dark or

SYMBOLS

- Symbolis & their backgrounds shall have a non-glare finish & shall contrast (le light on dark or dark or light)

Symbols are for International Sysmbol of Accessibility (ISA), International Symbol of TTY, volume control telephones, & assistive listening systems

# spaces at a min of every 200 LF per CBC 60° min for corridors over 200' per CBC

GRATES & OPENINGS IN WALKING SURFACES

CARPET PILE HEIGHT

**LEVEL CHANGES** 

1/2" max 1/2

-- Long dimension of opening


# 36\* min 42" min access width to

MAXIMUM VERTICAL

LEVEL CHANGE

# CLEAR WIDTH OF ACCESSIBLE ROUTE

if X≥42" then end aisle width is 48" min

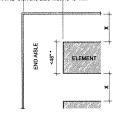

\* If element ≥ 48\*, end aisle shall comply with min clear width of accessible route (see above

# AISLES AT 180° TURNS AROUND AN ELEMENT

 Floor and ground surfaces shall be stable, firm, and slip resistant
 Carpet shall be securely attached with a firm pad or no pad, with a pile thickness of ½ max measured to backing or pad, and exposed edges shall have trim and be fastened to floor reen 1/4" and 1/2" should be vertical and beveled; greater than 1/2" should

be ramped or sloped 


Walking surfaces to be sloped 1:20 (5%) or less in the direction of travel and 1:48 maximum for cross slope.

Accessible routes less than 60° wide to have passing spaces at 200° intervals of 60° x 60° 
Sloped walkways shall have a 60° level landing at a min. of 400 linear feet per CBC 
Alises shall be a 15° m init il serving one side and 44° wif serving both sides per CBC 
If an accessible route has a drop of greater than 4" not adjacent to a street or driveway, a 5° high curb or a guard/hand rail shall be provided with an intermediary rail centered at 2" to 4" above grade per CBC

at 2 ° to 4 above grade per c.Sc. Slopes > 5% and 5 6% to be equivalent to medium salted finish slip resistant, slopes > 6% shall be slip resistant per CBC

WALKING SURFACES

3

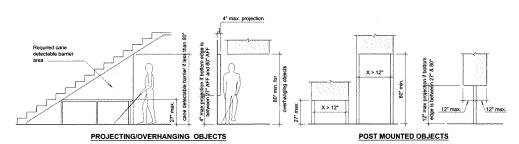

- A cane detectable barrier starting at 27" or below is required where bottom edge is less than 80" and >4" projection
 - A cane detectable barrier of a maximum of 27" high is required with over hanging or protruding objects where the bottom edge is between 27" and 80"
 - Door closers and door stops can be at 78" rim without cane detectable barrier

Bottom edges starting at 27" or below - no limitations on projections
- 98" or h at van accessible space, its accessible aisle, and vehicular route to the space
- 114" or h at a passenger loading one, its accessible aisle, and vehicular route to entrance and exit
- Edges of post-mounted signs to have %" min radius if < 80" above grade per CBC

# PROTRUDING OVERHANGING OBJECTS (11



Where not all entrances are accessible, all other accessible entries shall have an International Symbol of Accessibility (ISA); provide directional signage indicating nearest

International Symbol of Accessibility (ISA), provide directional signage introducing incides accessible entry at all inaccessible entrances.

All accessible building entrances shall be identified with an ISA per CBC

Alloy functions along accessible routes leading to entries shall also have an ISA with directional signs per CBC

The symbol shall be a white figure on a blue background matching color \$15090 in Federal Standard 5956 or other colors that provide contrast & approved by enforcement agency

except at parking per CBC - ISA shall identify accessible facilities per CBC

**BUILDING ENTRY SIGN - ISA** 

FRONT APPROACH

pull side

48" min


# -Clear width of 32" min measured from face of door in the 90" open position to the door stop -Clear width of 36" for penings 22" deep -Door closers and stops shall be 78" AFF min -Door hardware shall not require light grasping, pinching, o hisisting of the wrist -Closers, if present, shall require a closing time of 5 seconds min from 90" to 12"; 3 seconds min from 70" to 3" to latch per GBC to 3" to latch per CRC Force for push or pull side of door is 5# max except on fire doors which shall comply with appropriate administrative authority

nappropriate administrative authority inging doors shall have a smooth surface on push side extending 10" AFF for the full width, any joints shall have a 1/15" max differential; tempered glass doors without still and with a bottom rail with a 60° min taper along top edge do not need an additional kick

One entrance min from a tunnel or elevated walkway to a building shall be accessible One entrance min to a tenant space shall be accessible

In addition to above a minimum of 60% of public entrances shall be accessible and of an accessible route; 100% of exterior ground floor entrances to be accessible & shall be on an accessible route per CBC Within a building, a minimum of one door serving each room shall be accessible Revolving doors, gates & turnstiles shall not be part of an accessible route


# DOORS AND GATES

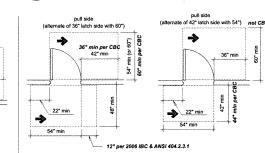


push side, with both closer and latch

HINGE APPROACH

push side

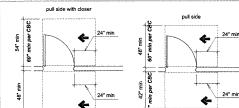

push side with close

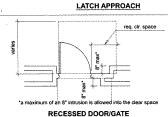

Note: All required clearances to have a maximum of 1:48 slope in any direction

DOOR CLEARANCES

**DOORS IN SERIES** 

ተ

12° min



425 East 4th St. Unit E Long Beach California, 90802

Voice: (562) 450-0495 Fax: (562) 436-5222

S

S

FITNES

OLYMPIX

4100 E. OCEAN BLVD LONG BEACH, CA. 90803

Revision Schedule Revision Revision Revision Number Description Date

01 BLDG. DEPT. SUBMITTAL 6/5/15

**CITRON DESIGN** GROUP

As noted

Sheet Description:


**TYPICAL INFORMATION** 

KS-01 6/5/2015

A.00.30

NOT FOR CONSTRUCTION


SIGNAGE

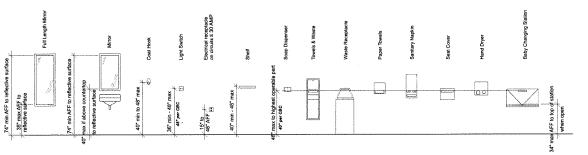

One of each provided type should be accessible if present
 All controls including coin slots shall be operable with one hand and not require tight grasping, pinching, or twisting of

the wrist Force required to activate shall be 5 lb max Provide a clear floor space of 30" x 48" min at each

ACCESSIBLE RESTROOM ACCESSORIES

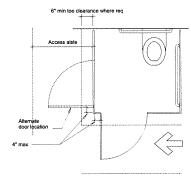

COMPARTMENT/ROOM DOOR LOCATION

# 39" to 41" 42" min 7"-9" to centerline of toilet paper dispenser SIDE GRAB BAR

BACK GRAB BAR

RESTROOMS

- Single occupency tollet facilities shall have a 60" min cir turning diameter and can not have a door encroach into this space more than 12" in any position with the exception of the toilet compartment door per CBC

- All walls within restrooms shall be finished to a 5"ht & walls within toilet compartments shall be finished to a 48"ht with a smooth, hard, non-absorbent surface per CBC

ACCESSIBLE WATER CLOSET

- Flush controls shall be operatable with one hand and not require tight grasping, pinching, or twisting & mounted
44\* th max per CBC

44" ht max per CBC

Force required to activate flush valve shall be 5 lb max.

Toited paper dispenser shall allow continuous flow of paper

Toited paper dispenser located above the grab be is required to be recessed.

Baby changing lable can not overlap clear space at toilet when open.

Required clearance at toilets can overlap with required clear space of other fixtures or turning space; no fixtures within the clear space.

2 "max fix tollet seaf per CBC

COMPARTMENT DOORS

- Doors to be located in the front or side partition or wall farthest from the toilet and shall have a clear opening of 32° min wide. 34° min wide when located on the side per CBC

- Door to be self-closing and adjusted so it takes 5 sec min from a 90 degree open position to 12 degrees from latch

side

Door puls (nop or U-shaped handle) shall be placed on both sides (push and pull) and be 34° min to 48° max AFF;
34° to 44° per CBC

Locksfalten shall be fillp-over style, sliding or other hardware not requiring tight grasping, pinching, or twisting and be 34° min to 45° max AFF; 34° to 44° per CBC

Force required to operate door or hardware shall be 5 lb max

If the door extends to within 10" of the finish floor it shall have a smooth surface on the push side

- If the door extends to within 10" of the firsh floor it shall have a smooth surface on the push side - A latch side pull approach may have 42" clear, 48" per CBC - Doors shall not swing into the minimum required compartment area, nor in required clear space of any fixtures; a do co can encroach into 5" of burning space max of 12" encroachment per CBC - A toe clearance of 9" high under the partition and 6" deep beyond the partition is not required at the front partition if the compartment in >62" deep for wall-hung or >65" for floor mount, not required at a side partition if >65" wide; if a 9" toe clearance is provided at the door, clearance at the strike side is not required per CBC

GRAB BARS

The space between the wall and the grab bar shall be 1½.

The space between the wall and of the grab bar shall be 1½.

The space between grab bars and projecting objects above shall be 12" min; 18" per CBC

Grab bers and adjacent surfaces shall be free of sharp or abrasaive surfaces or elements and adjacent elements shall be free of sharp or abrasaive surfaces or elements and adjacent elements shall also have rounded surfaces with a min ½" radius per CBC

Shall not troate within their fittings and shall allow a stress, shear, tensile force of 250 bs min

Circular grab bars shall have a diameter of 1½" min to 2" max 1½", to 1½" per CBC

Non-circular grab bars shall have cross section of 2" max and a perimeter dimension of 4.8" max; not allowed per

Recessed grab bars can be placed in a 3" max recess per CBC

AMBULATORY ACCESSIBLE TOILET


- A minimum of one ambulatory compartment is required where there is a combined total of 6 or more toilet and urinal

Includes per restroom.


Doors shall not swing into the minimum required compartment area; doors shall be outswinging per CBC.
Side grab bars to be placed on both sides.

ACCESSIBLE WO REQUIRED CLEAR SPACE

ed opening door at multiple accomm liet facilities - 48" min cir per CBC de opening door at multiple accomm liet facilities - 60" min cir per CBC

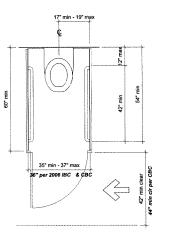

AMBULATORY WO REQUIRED CLEAR SPACE

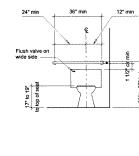




Note: T = tread depth

SIDE CLEARANCE

HANDRAIL EXTENSIONS AT STAIRS

HANDRAIL CLEARANCE

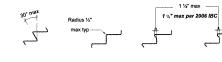

HANDRAIL GRIPPING SURFACES

ANGLED RISER TREAD EDGE RADIUS CURVED NOSING BEVELED NOSING

All steps to have uniform riser heights and uniform tread depths . No open risers permitted . Risers to be 4\* min to 7\* maximum

HANDRAIL EXTENSIONS AT RAMPS

HANDRAILS

- Handrails are required on both sides of stairs and pedestrian ramps with a rise > 6° except at aisle ramps immediately adjacent to fixed seating in a seembly areas where just one side is required

- Handrails to be continuous within each staff right or ramp run with the inside rails being continuous and not extending into the landing on switchback to or dospleg stairs and pedestrian ramps

- When children are primary users a second set of handrails can be provided at a max height of 28° to top of rail with a space of 9° min between both railings; 27° to top for elementary school and 22° to top for kindergarter/preschool per CBC

- Handrails can be located within a 3° maximum encess if the recess is extended 18° above the top of the rail and 1½° below per CBC

- One handrail is required to be perpendicular to tread per CBC

GRIPPING SURFACES

- Gripping surfaces shall not be obstructed on tops and sides and a maximum of 20% along the bottom; horizontal projections shall happen a minimu nof 1½° of below the gripping surface

- Gripping surfaces and adjacent surfaces shall be free of sharp or abrasive elements and have rounded edges; ¾° min radius per CBC

- Shall not rotate in their fittings


EXTENSIONS

- Handralis at pedestrian ramps shall extend horizontally above the top and bottom landings for 12" min and shall return to a wall, guard, or the landing surface
- Handralis at stairs shall extend horizontally above the top landing 12" min from the riser nosing; shall extend at the same slope as the stairs the horizontal distance of one tread width from the bottom riser nosing; one tread width plus 12" horizontal per CBC from the bottom nosing;
- Extensions shall be measured to the spring point of the radius
- Extensions for top and bottom shall return to a wall, floor, or post; if returning to a post, bottom of the return rail to be 27" max AFF


4" min to 61/4" max perimete


11/4"-11/4" per CBC

No open insers permit or "maximum"
Treads to be 4" min to 7" maximum
Treads to be 11" minimum
Treads to be 11" minimum
Treads and have a slope up to 1:48 max
Stair treads and landings shall not have ponding of water
Halndrails required on both sides of stairs; provide intermediary handrail
equi-distance at stairways requiring more than 88" width per GBC
Suggest providing visual contrast on leading egglo of treads or tread nosing;
Striping on exterior stairs - all treads and landings to receive a
contrasting color strip with a minimum of the same stip resistance as
treads of 2" min to 4" max width placed parallel and starting within 1"
of stair nosing; striping on interior stairs to be placed on the bottom
treads and top & Intermediary landings only similar to the exterior
striping per CBBC
Provide raised characters & braile floor designation signs on each floor of
the floor designation on exit discharge level

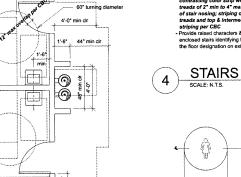

- Provide 1x furning at masonry walls where occurs
- Doors may not enconach on clear space for any fluture
- Min of 1 womens and 1 mens restoom required for M & B occupancy if > 1,500 SF
- Drinking fountain required if space > 6,000 SF
- All plumbing walls to be 256 min

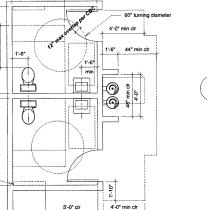

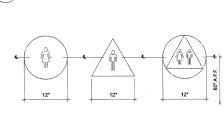

SYMBOL DESCRIPTION

On doors leading to men's sanitary facilities, an equilateral triangle '/," thick with edges 12' long and a vertex pointing upward

On doors leading to women's facilities, a circle '/," thick and 12" in diameter

'Where a unisex restroom is provided a combined circle and inscribed triangle

where a unsex response produce a combined since and an acade usings sign shall be used.

These symbols shall be centered on the door at a height of 60° AFF and their color and contrast shall be distinctly different from the color and contrast of the doors.

CA RESTROOM DOOR ID



WALKING SURFACES

HANDRAIL HEIGHTS

425 East 4th St. Unit E Long Beach California, 90802

Voice: (562) 450-0495 Fax: (562) 436-5222

4100 E. OCEAN BLVD LONG BEACH, CA. 90803

**OLYMPIX FITNESS** 

Revision Schedule Revision Revision Revision Number Description Date

01 BLDG, DEPT, SUBMITTAL 6/5/15

Drawn by:

# **CITRON DESIGN GROUP**

As noted

Sheet Description:

ADA

Project No: KS-01


6/5/2015


A.00.31

NOT FOR CONSTRUCTION

WATER CLOSETS

CA BACK/BACK RESTROOMS

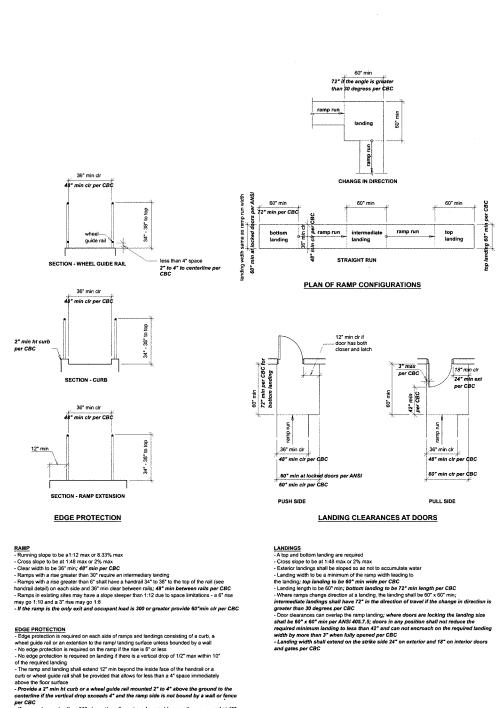

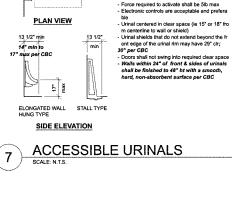

30" x 48" clr space 36" x 48" clr space if alcove or side partitions are >24"

sleeved & bolted

Flush controls shall be operable with one hand and not require tight grasping, pinching or twisting of the wrist


Controls shall be mounted a max of 44" AFF

Sign to state the following:
"Unauthorized vehicles parked in designated accessible spaces not displaying distinguishing placards or license plates issued for persons with disabilities may be towed away at the owner's expense. Towed vehicles may be reclaimed at (<u>fill in address</u>) or by telephoning (fill in phone number)

- Place at each entrance to off-street parking facilities or immediately adjacent to each accessible parking stall - Lettering to be 1" min H - Lettering to be 1" min H - Edges of post-mounted signs to have "/a" min radius if < 80" above


grade
-Address & phone number to be filled in with designated information as a permanent part of the sign.

**CA TOW AWAY SIGN** 

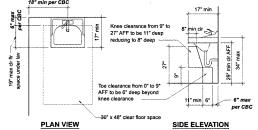

Does shall not swing into required clear floor space
All drain and hot water pipes under the lavalory need to be insulated or covered with a pre-manufactured pipe bout or shelled to prevent contact.
There shall be no sharp or abrasive surfaces under the lavalory without protection of a pre-manufactured boor or shalled.
Faucets shall be operable with one hand and not require sign grasping, pinching, or twisting of the wrist; lever-operated, push-upe, and electronically controlled are compliable.
The force to operate the faucet controls shall be a maximum of 5 bs.
Self-closing varies are allowed if they remain open a minimum of 10 seconds.
Frequired 50° min wide knee and took clearance.

**ACCESSIBLE LAVATORIES** ິ3ີ

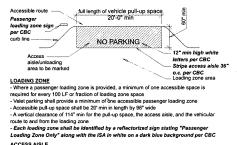

Loading Zone Only" along with the ISA in white on a dark blue background per CBC ACCESS AISL.

Access alste must adjoin an accessible route

Access alste must adjoin an accessible route

Access alste stable 60" min wide and the full length of the pull-up space with 20" min length

A maximum slope of 2% is allowed in the pull-up space and access aisle - both to be on the same level

- Markings should prevent parking in the access aisle

- Paint the words "NO PARKING" on the ground and in the access isle in white letters 12" high min per CBC

PASSENGER LOADING ZONE



425 East 4th St. Unit E Long Beach California, 90802

Voice: (562) 450-0495 Fax: (562) 436-5222

4100 E. OCEAN BLVD LONG BEACH, CA. 90803

**OLYMPIX FITNESS** 

Revision Schedule Revision Revision Revision Number Description Date

01 BLDG. DEPT. SUBMITTAL 6/5/15

Drawn by:

**CITRON DESIGN** GROUP

Scale:

As noted

Sheet Description:

ADA (2)

KS-01

6/5/2015

A.00.32


NOT FOR CONSTRUCTION



**(19**)

centerine if the vertical usup exceeds

If a ramp is greater than 30° above the adjacent grade, provide a continuous guard at 42° min fit for the full length of the ramp, guard openings if any are required to have less than a

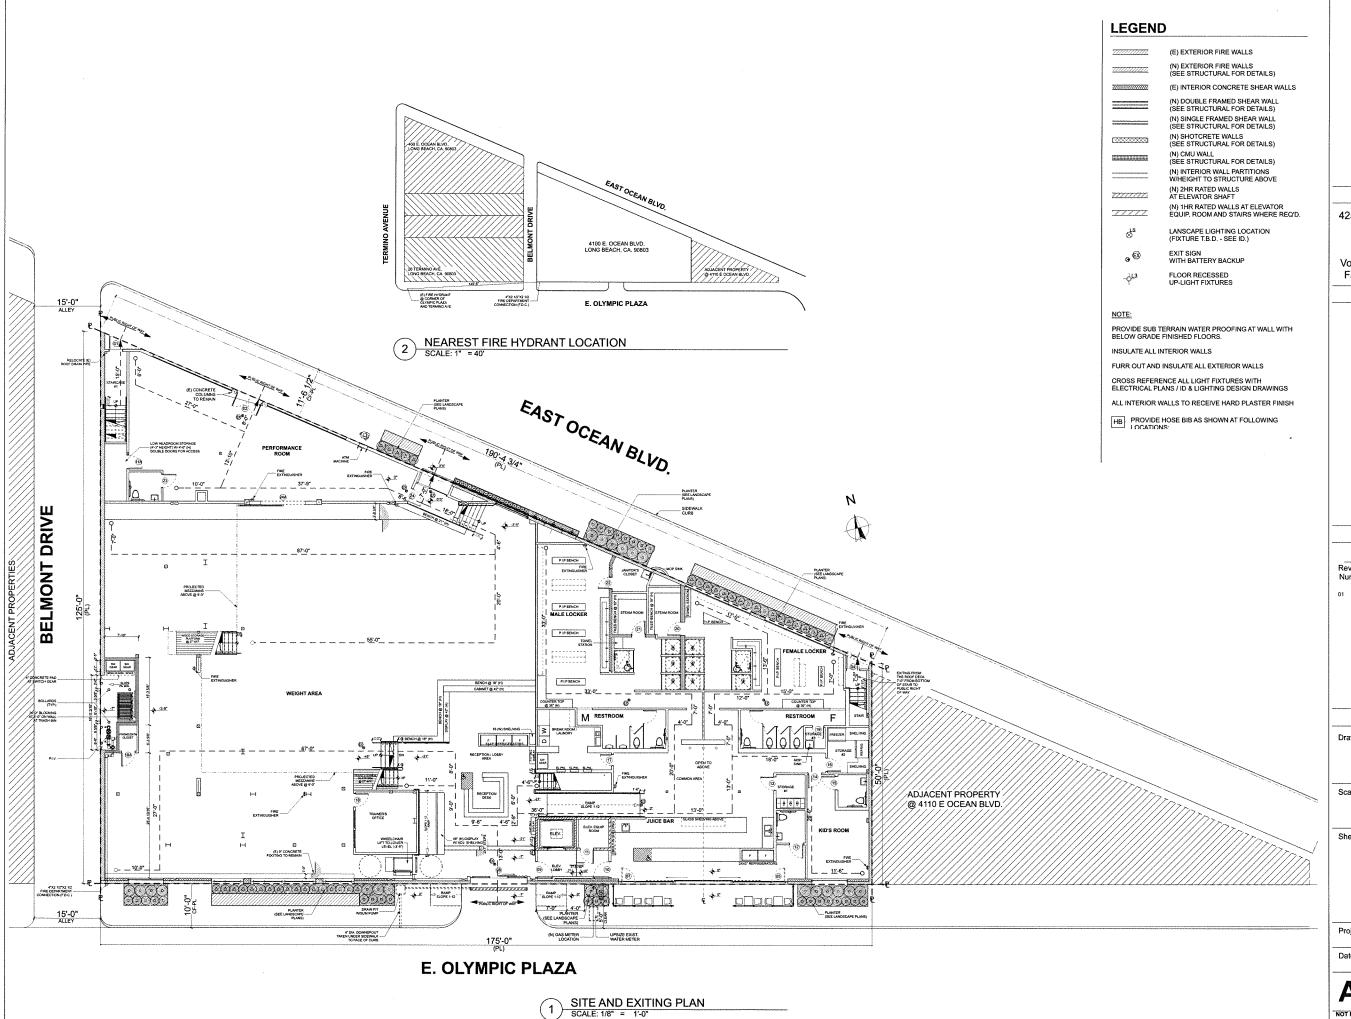



425 East 4th St. Unit E Long Beach California, 90802

Voice: (562) 450-0495 Fax: (562) 436-5222

**OLYMPIX FITNESS** 

4100 E. OCEAN BLVD LONG BEACH, CA. 90803

Revision Schedule Revision Revision Revision Number Description Date

01 BLDG. DEPT. SUBMITTAL 6/5/15

Drawn by:

**CITRON DESIGN GROUP** 

As noted


Sheet Description:

SITE PLAN / **EXITING PLAN** 

KS-01

6/5/2015

A.00.40

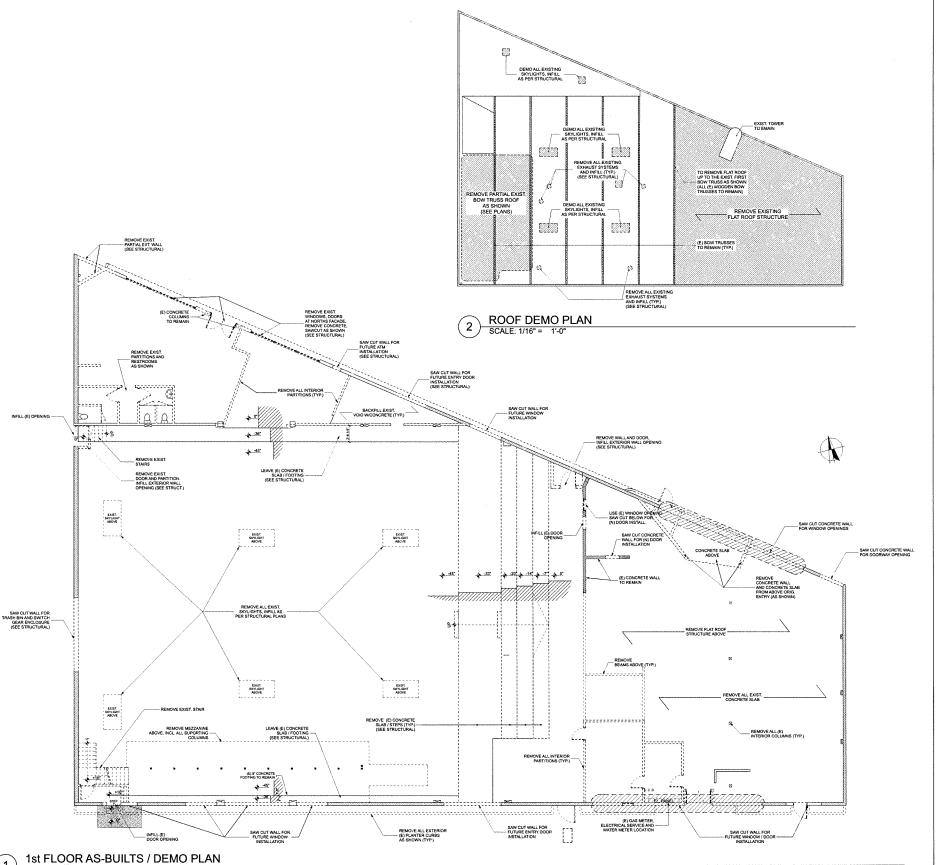

SCALE: 1/8" = 1'-0"

# **LEGEND**

EXISTING EXTERIOR WALL TO REMAIN WHERE SHOWN EXISTING INTERIOR PARTITIONS AS SHOWN TO BE REMOVED AREA UNDER DEMOLITION (SEE NOTES)

# NOTE

REMOVE ALL INTERIOR LIGHT FIXTURES AND HEATING UNITS (TYP.)

BOW TRUSS ROOF: REPAIR EXISTING TO REMAIN - WOODEN BEAMS, 1X SHEETING AND SUB-MEMBERS AS REQ'D.

DEMO ALL EXISTING ROOFING, HVAC AND DUCTWORK FROM THE ROOF

REMOVE ALL EXISTING ELECTRICAL FIXTURES, CONDUIT, SIGNAGE, AND DEVICES ON INTERIOR AND EXTERIOR WALLS, ROOF & CEILINGS.

REMOVE AND INFILL ALL EXISTING SKYLIGHTS AS SHOWN (SEE STRUCTURAL PLANS FOR SAWCUT AND INFILL DETAIL)

PROVIDE NECESSARY SHORING AS REQ'D.

CROSS REFERENCE ARCHITECTURAL ELEMENTS ON FLOOR PLANS FOR DEMOLITION

REMOVE ALL ELEMENTS FROM EXISTING INTERIOR AND EXTERIOR WALLS TO ALLOW NEW PLASTER FINISHES (TYP.)



425 East 4th St. Unit E Long Beach California, 90802

Voice: (562) 450-0495 Fax: (562) 436-5222

**OLYMPIX FITNESS** 

4100 E. OCEAN BLVD LONG BEACH, CA. 90803

Revision Schedule Revision Revision Revision Number Description Date

01 BLDG. DEPT. SUBMITTAL 6/5/15

**CITRON DESIGN** GROUP

As noted


Sheet Description:

AS-BUILTS / DEMO **PLAN** 

KS-01

6/5/2015

A.00.50

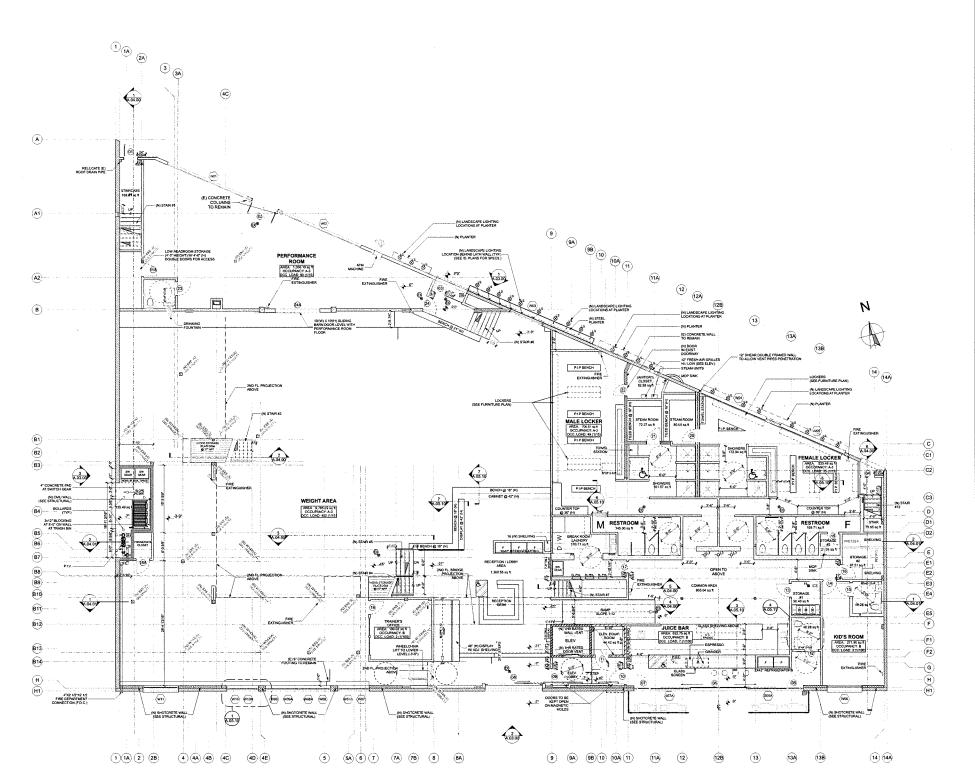

(E) EXTERIOR FIRE WALLS (N) EXTERIOR FIRE WALLS (SEE STRUCTURAL FOR DETAILS) (E) INTERIOR CONCRETE SHEAR WALLS (N) DOUBLE FRAMED SHEAR WALL (SEE STRUCTURAL FOR DETAILS) (N) SINGLE FRAMED SHEAR WALL (SEE STRUCTURAL FOR DETAILS) (N) SHOTCRETE WALLS (SEE STRUCTURAL FOR DETAILS) (N) CMU WALL (SEE STRUCTURAL FOR DETAILS) (N) INTERIOR WALL PARTITIONS W/HEIGHT TO STRUCTURE ABOVE (N) 2HR RATED WALLS AT ELEVATOR SHAFT (N) 1HR RATED WALLS AT ELEVATOR EQUIP. ROOM AND STAIRS WHERE REQ'D. EXIT SIGN WITH BATTERY BACKUP FLOOR RECESSED UP-LIGHT FIXTURES

NOTE:

PROVIDE SUB TERRAIN WATER PROOFING AT WALL WITH BELOW GRADE FINISHED FLOORS.

INSULATE ALL INTERIOR WALLS

FURR OUT AND INSULATE ALL EXTERIOR WALLS

CROSS REFERENCE ALL LIGHT FIXTURES WITH ELECTRICAL PLANS / ID & LIGHTING DESIGN DRAWINGS

ALL INTERIOR WALLS TO RECEIVE HARD PLASTER FINISH

| HB | PROVIDE HOSE BIB AS SHOWN AT FOLLOWING LOCATIONS:
- TRASH AREA - JUICE BAR PATIO - NORTH ENTRY FRONT

CITRON DESIGN GROUP

425 East 4th St. Unit E Long Beach California, 90802

Voice: (562) 450-0495 Fax: (562) 436-5222

> **OLYMPIX FITNESS** 4100 E. OCEAN BLVD LONG BEACH, CA. 90803

Revision Schedule Revision Revision Revision Number Description Date

01 BLDG. DEPT. SUBMITTAL 6/5/15

Drawn by:

**CITRON DESIGN** GROUP

As noted

Sheet Description:


1ST. FL. FLOOR **PLAN** 

Project No: KS-01 6/5/2015

A.01.10


NOT FOR CONSTRUCTION

2 1ST FLOOR PLAN SCALE: 1/8" = 1'-0"

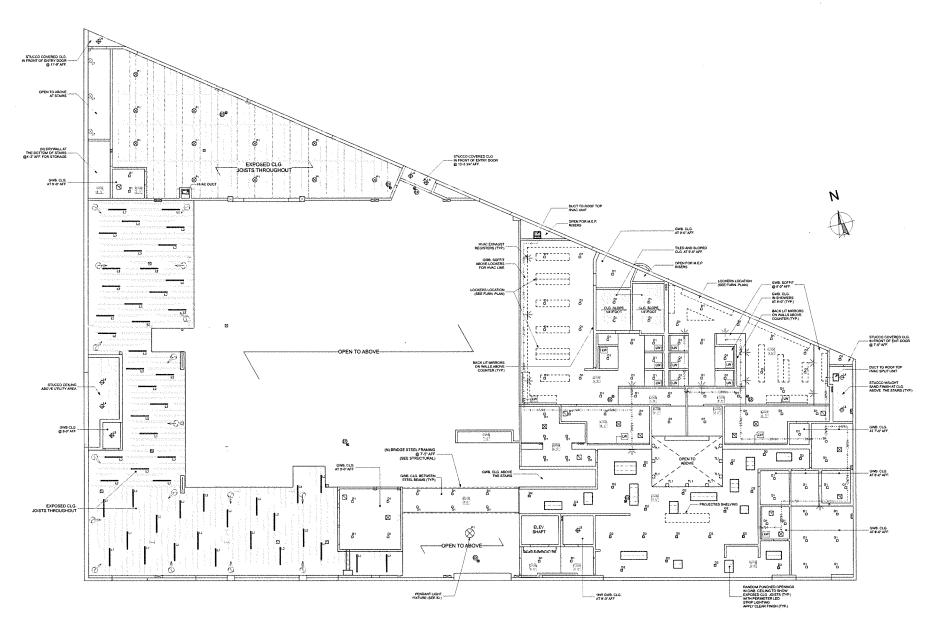

--->---HVAC--

NOTE:

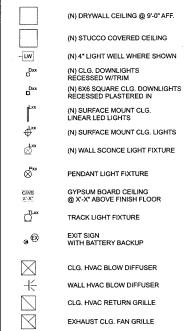

ABOVE CLG. HVAC FLEX DUCT LINE

16" DIRECTIONAL CEILING FAN

SEAL ALL EXPOSED WOODEN JOISTS AND BEAMS WITH CLEAR COATING PRIOR TO INSTALL ELECTRICAL (TYP.)
 ALL WET AREAS TO HAVE SEMI-GLOSS PAINT (SEE SCHEDULE)
 ALL DRYWALL CEILINGS TO HAVE SEMI-RECESSED SPRINKLER HEADS WITH CHROME ESCUTCHEONS

CITRON DESIGN GROUP

425 East 4th St. Unit E Long Beach California, 90802

Voice: (562) 450-0495 Fax: (562) 436-5222

**OLYMPIX FITNESS** 

4100 E. OCEAN BLVD LONG BEACH, CA. 90803

Revision Schedule Revision Revision Revision Number Description Date

01 BLDG. DEPT. SUBMITTAL 6/5/15

**CITRON DESIGN** GROUP

As noted

Sheet Description:


**RCP - FIRST FLOOR** 

KS-01

6/5/2015

NOT FOR CONSTRUCTION

RCP - 1ST FLOOR SCALE: 1/8" = 1'-0"

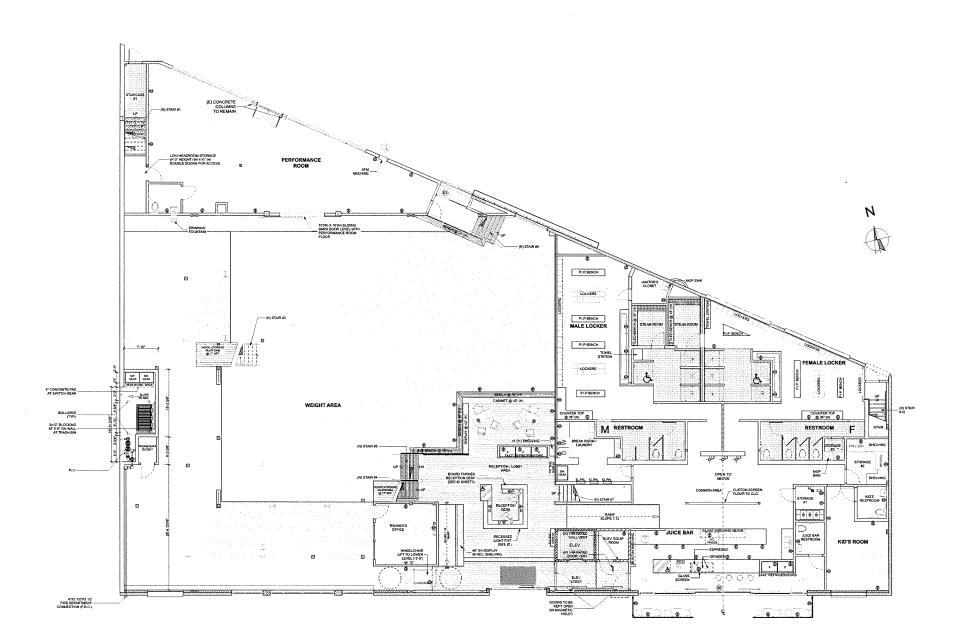



POLISHED CONCRETE CERAMIC FLOOR TILE CERAMIC WALL TILE (ON STEAM ROOM BENCHES) RUBBER FLOORING (W/RUBBER BASE IN KID'S ROOM)

BROADROOM CARPET

WOOD FLOORING

(N) SINGLE POLE SWITCH (N) DUPLEX RECEPTACLE (N) QUAD RECEPTACLE (N) PHONE / DATA OUTLET

SEE ELECTRICAL PLANS FOR SWITCHING DIAGRAMM AND POWER DISTRIBUTION



425 East 4th St. Unit E Long Beach California, 90802

Voice: (562) 450-0495 Fax: (562) 436-5222

**OLYMPIX FITNESS** 

4100 E. OCEAN BLVD LONG BEACH, CA. 90803

Revision Schedule Revision Revision Revision Number Description Date

01 BLDG, DEPT, SUBMITTAL 6/5/15

**CITRON DESIGN** GROUP

Scale:

As noted

Sheet Description:


1ST. FL. FURNITURE / **FINISH PLAN** 

KS-01

6/5/2015

NOT FOR CONSTRUCTION

1 ST FLOOR FUNITURE, POWER & DATA PLAN SCALE: 1/8" = 1'-0"

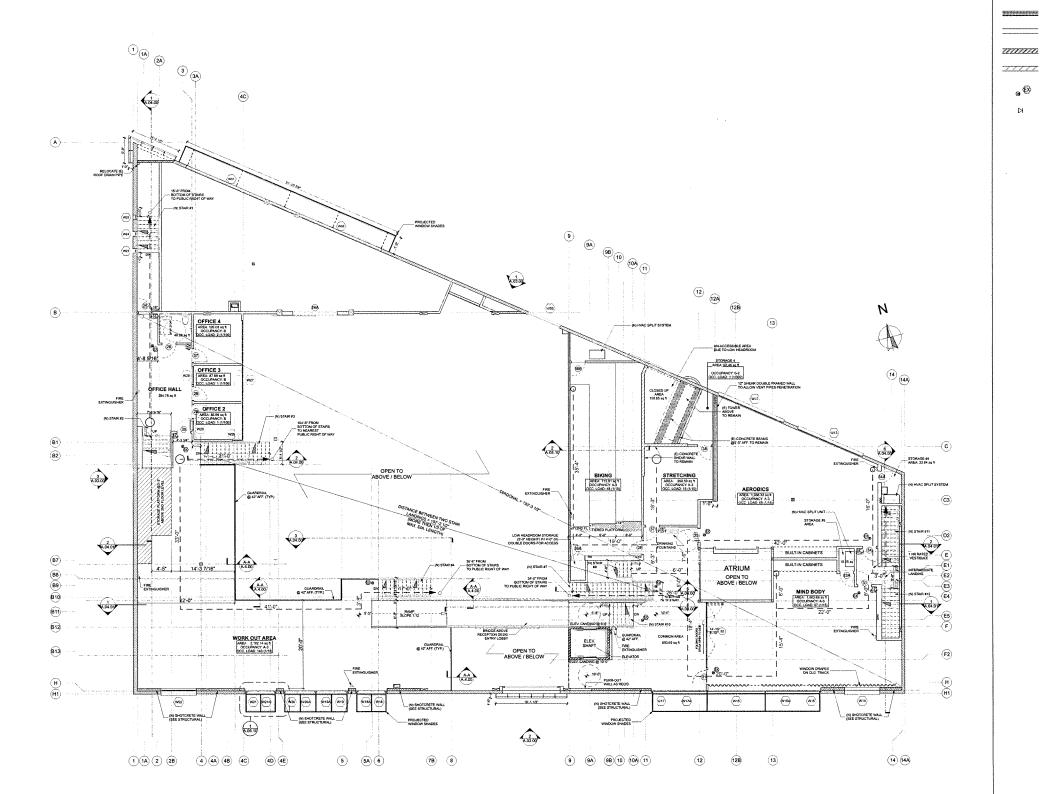

(E) EXTERIOR FIRE WALLS
(N) EXTERIOR FIRE WALLS
(SEE STRUCTURAL FOR DETAILS)

(E) INTERIOR CONCRETE SHEAR WALLS (N) DOUBLE FRAMED SHEAR WALL (SEE STRUCTURAL FOR DETAILS)

(SEE STRUCTURAL FOR DETAILS)
(N) SINGLE FRAMED SHEAR WALL
(SEE STRUCTURAL FOR DETAILS)
(N) SHOTCRETE WALLS
(SEE STRUCTURAL FOR DETAILS)
(N) CMU WALL
(SEE STRUCTURAL FOR DETAILS)

(N) INTERIOR WALL POR DE MILE)

(N) INTERIOR WALL PARTITIONS
WHEIGHT TO STRUCTURE ABOVE

(N) 2HR RATED WALLS
AT ELEVATOR SHAFT

(N) 1HR RATED WALLS AT ELEVATOR
EQUIP. ROOM AND STAIRS WHERE REQ'D.

EXIT SIGN
WITH BATTERY BACKUP

\_\_\_\_\_



425 East 4th St. Unit E Long Beach California, 90802

Voice: (562) 450-0495 Fax: (562) 436-5222

> 4100 E. OCEAN BLVD LONG BEACH, CA. 90803

**OLYMPIX FITNESS** 

Revision Schedule
Revision Revision Revision
Number Description Date

01 BLDG, DEPT, SUBMITTAL 6/5/15

Drawn by:

CITRON DESIGN GROUP

Scale:

As noted

Sheet Description:

2ND. FLOOR PLAN

Project No:


KS-01

6/5/2015


A.01.20

NOT FOR CONSTRUCTION

2ND FLOOR PLAN
SCALE: 1/8" = 1'-0"

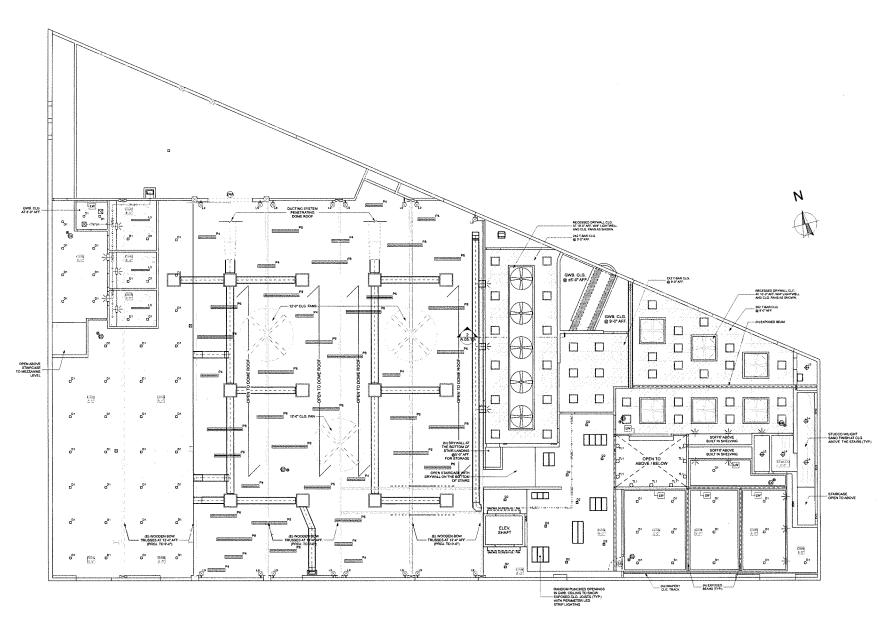



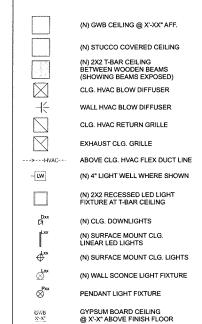

**⊕** 😥

- SEAL ALL EXPOSED WOODEN JOISTS AND BEAMS WITH CLEAR COATING PRIOR TO INSTALL ELECTRICAL (TYP)
   CROSS REFERENCE PLAN WITH ENGINEERED DRAWINGS
- 3. ALL FIRE SPRINKLER HEADS IN DRYWALL / AC

(N) 4', 6' AND 8' LINEAR PENDANT LIGHT BAR TYPE FIXTURES HUNG ON STAINLE: STEEL CABLE AT RANDOM ELEVATIONS (

EXIT SIGN WITH BATTERY BACKUP



425 East 4th St. Unit E Long Beach California, 90802

Voice: (562) 450-0495 Fax: (562) 436-5222

> **OLYMPIX FITNESS** 4100 E. OCEAN BLVD LONG BEACH, CA. 90803

Revision Schedule Revision Revision Revision Number Description Date

01 BLDG. DEPT. SUBMITTAL 6/5/15

Drawn by:

**CITRON DESIGN** GROUP

Scale:

As noted

Sheet Description:

**RCP - SECOND FLOOR** 


Project No:

KS-01 6/5/2015

A.01.21

NOT FOR CONSTRUCTION

RCP - 2ND FLOOR 1) RUP - ZIND I EC SCALE: 1/8" = 1'-0"

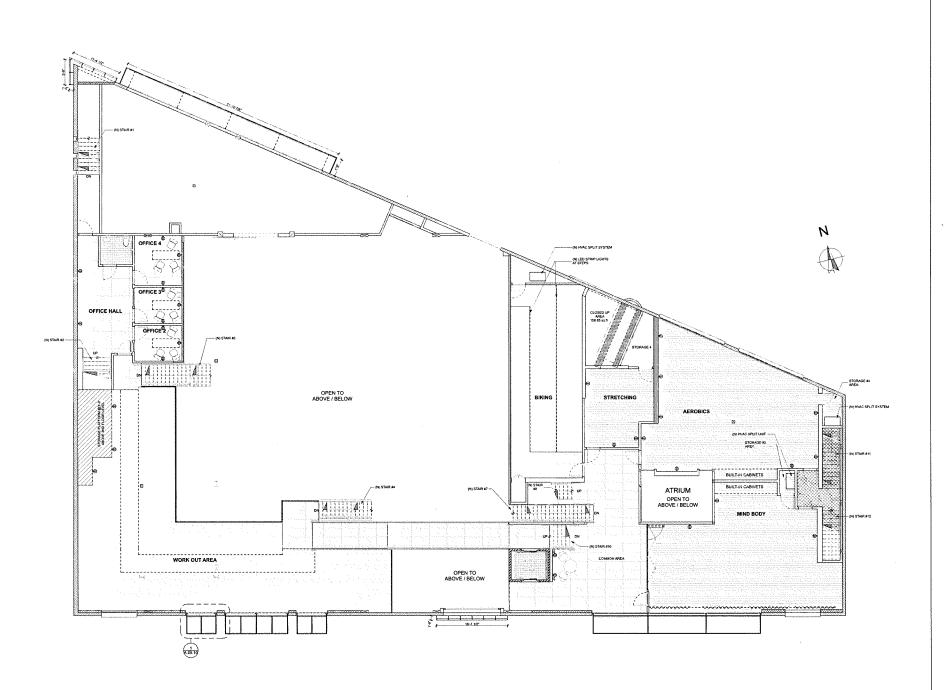

POLISHED CONCRETE CERAMIC FLOOR TILE RUBBER FLOORING (W/RUBBER BASE IN KID'S ROOM) BROADROOM CARPET

WOOD FLOORING CARPET TILE

WATER PROOF FLOOR

Ħ (N) PHONE / DATA OUTLET (N) SINGLE POLE SWITCH \* (N) DUPLEX RECEPTACLE (N) QUAD RECEPTACLE



425 East 4th St. Unit E Long Beach California, 90802

Voice: (562) 450-0495 Fax: (562) 436-5222

**OLYMPIX FITNESS** 

4100 E. OCEAN BLVD LONG BEACH, CA. 90803

Revision Schedule Revision Revision Revision Number Description Date

01 BLDG. DEPT. SUBMITTAL 6/5/15

Drawn by:

**CITRON DESIGN** GROUP

As noted

Sheet Description:

2ND. FL. FURNITURE / **FINISH PLAN** 


KS-01

6/5/2015

A.01.22

NOT FOR CONSTRUCTION

2ND FLOOR FURNITURE, POWER & DATA PLAN
SCALE: 1/8" = 1'-0"

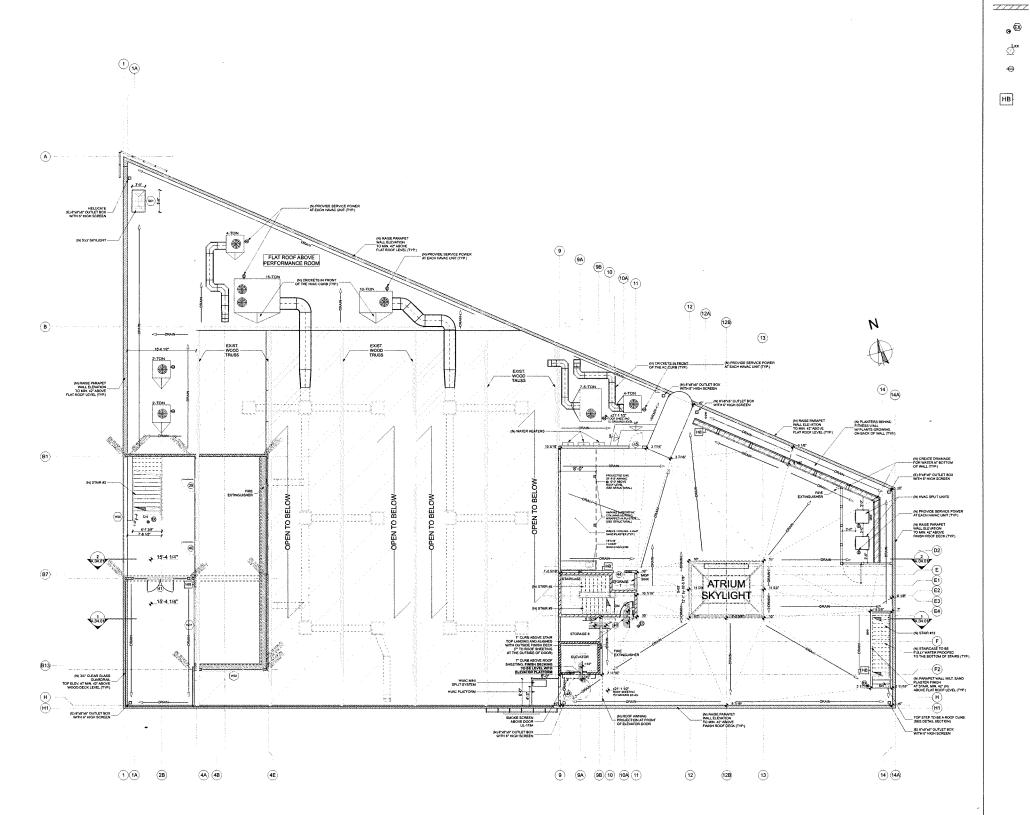

(E) EXTERIOR FIRE WALLS (N) EXTERIOR FIRE WALLS (SEE STRUCTURAL FOR DETAILS) TO THE PARTY. (N) INTERIOR WALL PARTITIONS (N) 2HR RATED WALLS AT ELEVATOR SHAFT (N) 1HR RATED WALLS AT ELEVATOR EQUIP. ROOM AND STAIRS WHERE REQ'D.

EXIT SIGN WITH BATTERY BACKUP

(N) WALL SCONCE LIGHT FIXTURE

(N) DUPLEX RECEPTACLE

PROVIDE HOSE BIB AS SHOWN AT FOLLOWING LOCATIONS:
- MEZZANINE OFFICE PATIO
- ROOF DECK LOCATIONS AS SHOWN



425 East 4th St. Unit E Long Beach California, 90802

Voice: (562) 450-0495 Fax: (562) 436-5222

**OLYMPIX FITNESS** 

4100 E. OCEAN BLVD LONG BEACH, CA. 90803

Revision Schedule Revision Revision Revision Number Description Date

01 BLDG, DEPT, SUBMITTAL 6/5/15

Drawn by:

**CITRON DESIGN** GROUP

Scale:

As noted

Sheet Description:

MEZZANINE/ROOF **LEVEL FLOOR** PLAN

Project No:


KS-01

6/5/2015

A.01.30

NOT FOR CONSTRUCTION

1 FLAT ROOF LEVEL PLAN
SCALE: 1/8" = 1'-0"

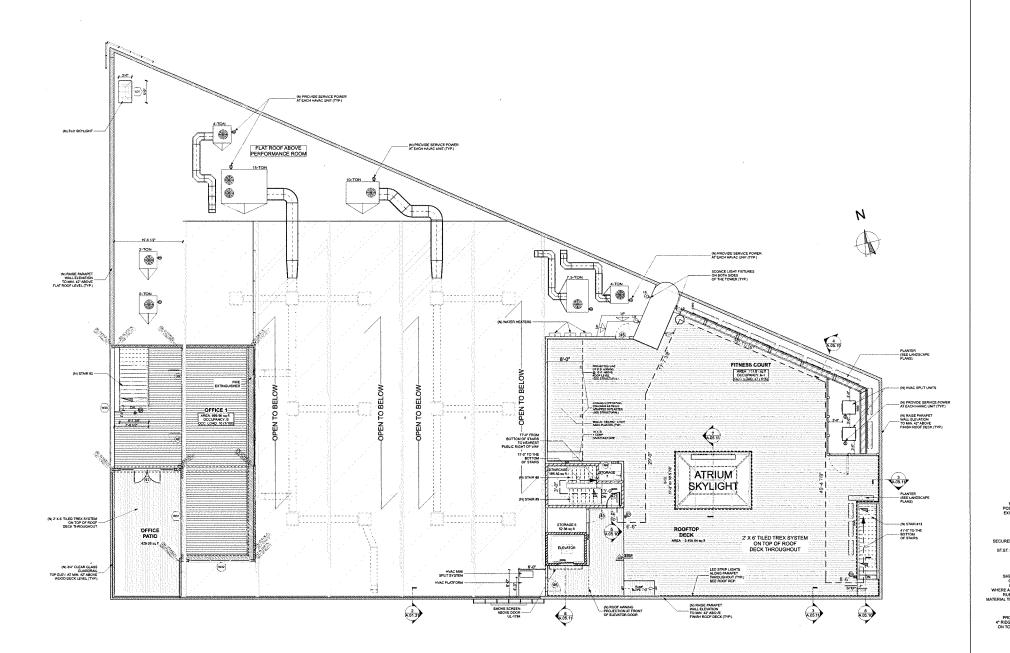

HB

(E) EXTERIOR FIRE WALLS
(N) EXTERIOR FIRE WALLS
(SEE STRUCTURAL FOR DETAILS)

(N) INTERIOR WALL PARTITIONS

(N) 2HR RATED WALLS
AT ELEVATOR SHAFT

(N) 1HR RATED WALLS AT ELEVATOR
EQUIP. ROOM AND STAIRS WHERE REQ'D.

EXIT SIGN
WITH BATTERY BACKUP

(N) WALL SCONCE LIGHT FIXTURE

⊕ (N) DUPLEX RECEPTACLE

PROVIDE HOSE BIB AS SHOWN AT FOLLOWING LOCATIONS:
- MEZZANINE OFFICE PATIO
- ROOF DECK LOCATIONS AS SHOWN

CITRON DESIGN GROUP

425 East 4th St. Unit E Long Beach California, 90802

Voice: (562) 450-0495 Fax: (562) 436-5222

OLYMPIX FITNESS

4100 E. OCEAN BLVD LONG BEACH, CA. 90803

Revision Schedule
Revision Revision Revision
Number Description Date

01 BLDG. DEPT. SUBMITTAL 6/5/15

Drawn by

CITRON DESIGN GROUP

Scale:

As noted

Sheet Description:

MEZZANINE/ROOF FINISH FL. / FURNITURE PLAN

Project No:

KS-01 6/5/2015


A.01.31


-----

1 MEZZANINE / ROOF DECK / FURNITURE AND EXITING PLAN SCALE: 1/8" = 1'-0"

PARAPET W/WOOD FENCE

SCALE: 3/4" = 1'-0"

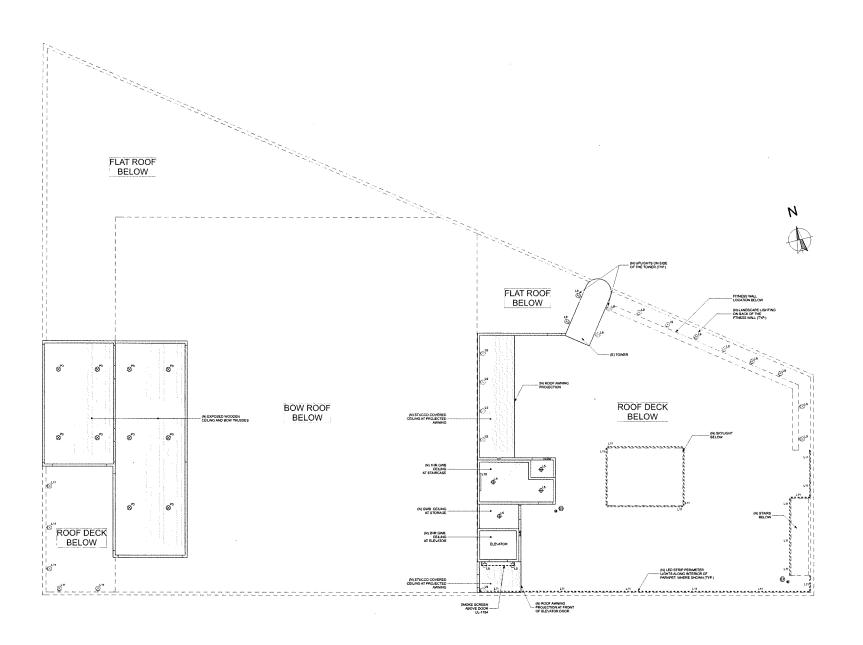

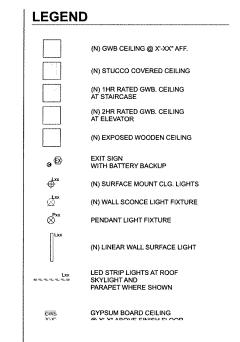



425 East 4th St. Unit E Long Beach California, 90802

Voice: (562) 450-0495 Fax: (562) 436-5222

OLYMPIX FITNESS

4100 E. OCEAN BLVD LONG BEACH, CA. 90803

Revision Schedule
Revision Revision Revision
Number Description Date

01 BLDG. DEPT. SUBMITTAL 6/5/15

Drawn by:

CITRON DESIGN GROUP

Sca

As noted

Sheet Description:

RCP MEZZANINE/ ROOF LEVEL

Project No:

KS-01 6/5/2015

A A4 22

NOT FOR CONSTRUCTION

1 RCP MEZZANINE LEVEL
SCALE: 1/8" = 1'-0"

# FLAT ROOF DECK BELOW 03.00 (N) PROVIDE 4" RIDGIO -- INSULATION AT EXTERIOR DF BOW ROOF И EXIST. TOWER TO EMAIN FLAT ROOF DECK BELOW A 03.00 ROOF DECK BELOW ROOF DECK BELOW A01.31 IN ROOF AWWING ROOF AT FRONT OF ELEVATOR DOOR 203.00

# NOTES

PROVIDE BUILT-UP ROOF WITH 4" RIDGID INSULATION AT BOW ROOF



425 East 4th St. Unit E Long Beach California, 90802

Voice: (562) 450-0495 Fax: (562) 436-5222

# OLYMPIX FITNESS

4100 E. OCEAN BLVD LONG BEACH, CA. 90803

Revision Schedule
Revision Revision
Number Description Date

01 BLDG. DEPT. SUBMITTAL 6/5/15

Drawn by:

CITRON DESIGN GROUP

Scale

As noted

Sheet Description:

BOW TRUSS ROOF LEVEL PLAN

Project No:


KS-01

6/5/2015


A.01.33

NOT FOR CONSTRUCTION


1 DOME ROOF LEVEL PLAN
SCALE: 1/8" = 1'-0"

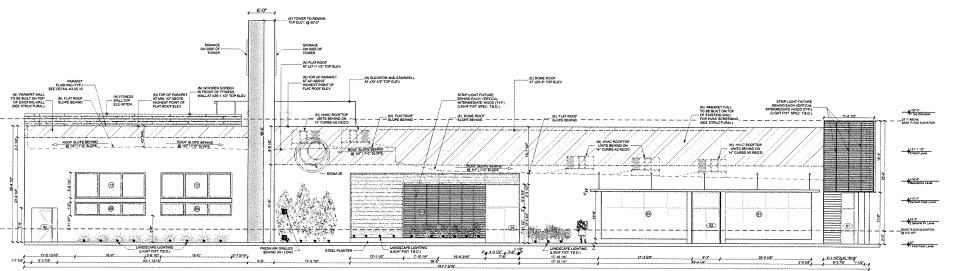

1 NORTH ELEVATION
SCALE: 1/8" = 1'-0"

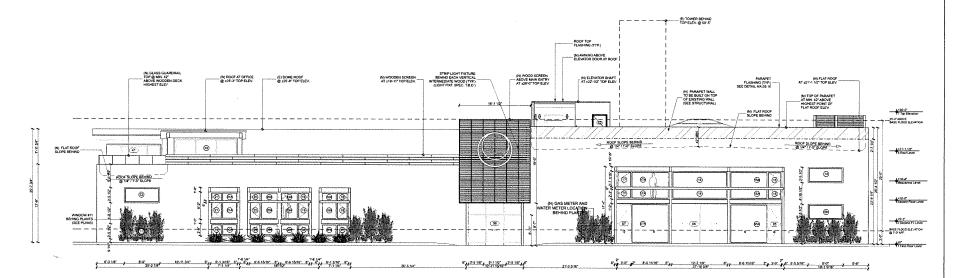

SOUTH ELEVATION
SCALE: 1/8" = 1'-0"

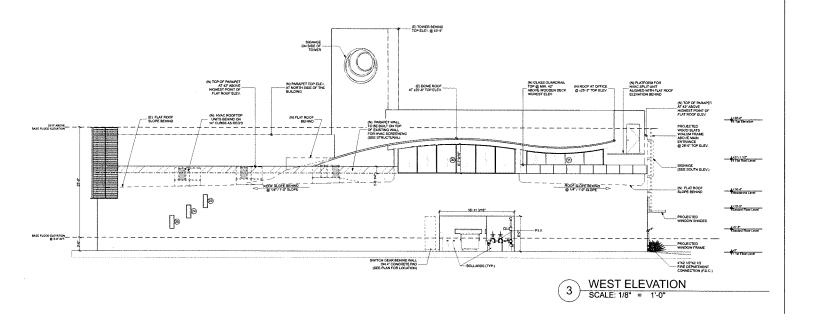

# NOTE

1. PROVIDE SKIM COAT AT ALL EXISTING CONCRETE SURFACES, SKIM COATING TO BE SMOOTH, CONSISTENT FINISH

2. COORDINATE ALL WALL INFILL AND ELEVATOR WITH STRUCTURAL DRAWINGS



425 East 4th St. Unit E Long Beach California, 90802

Voice: (562) 450-0495 Fax: (562) 436-5222

OLYMPIX FITNESS

4100 E. OCEAN BLVD LONG BEACH, CA. 90803

Revision Schedule
Revision Revision Revision
Number Description Date

01 BLDG, DEPT, SUBMITTAL 6/5/15

Drawn by:

# CITRON DESIGN GROUP

Scale:

As noted

Sheet Description:


EXTERIOR ELEVATIONS

Project No:

KS-01

6/5/2015

A.03.00

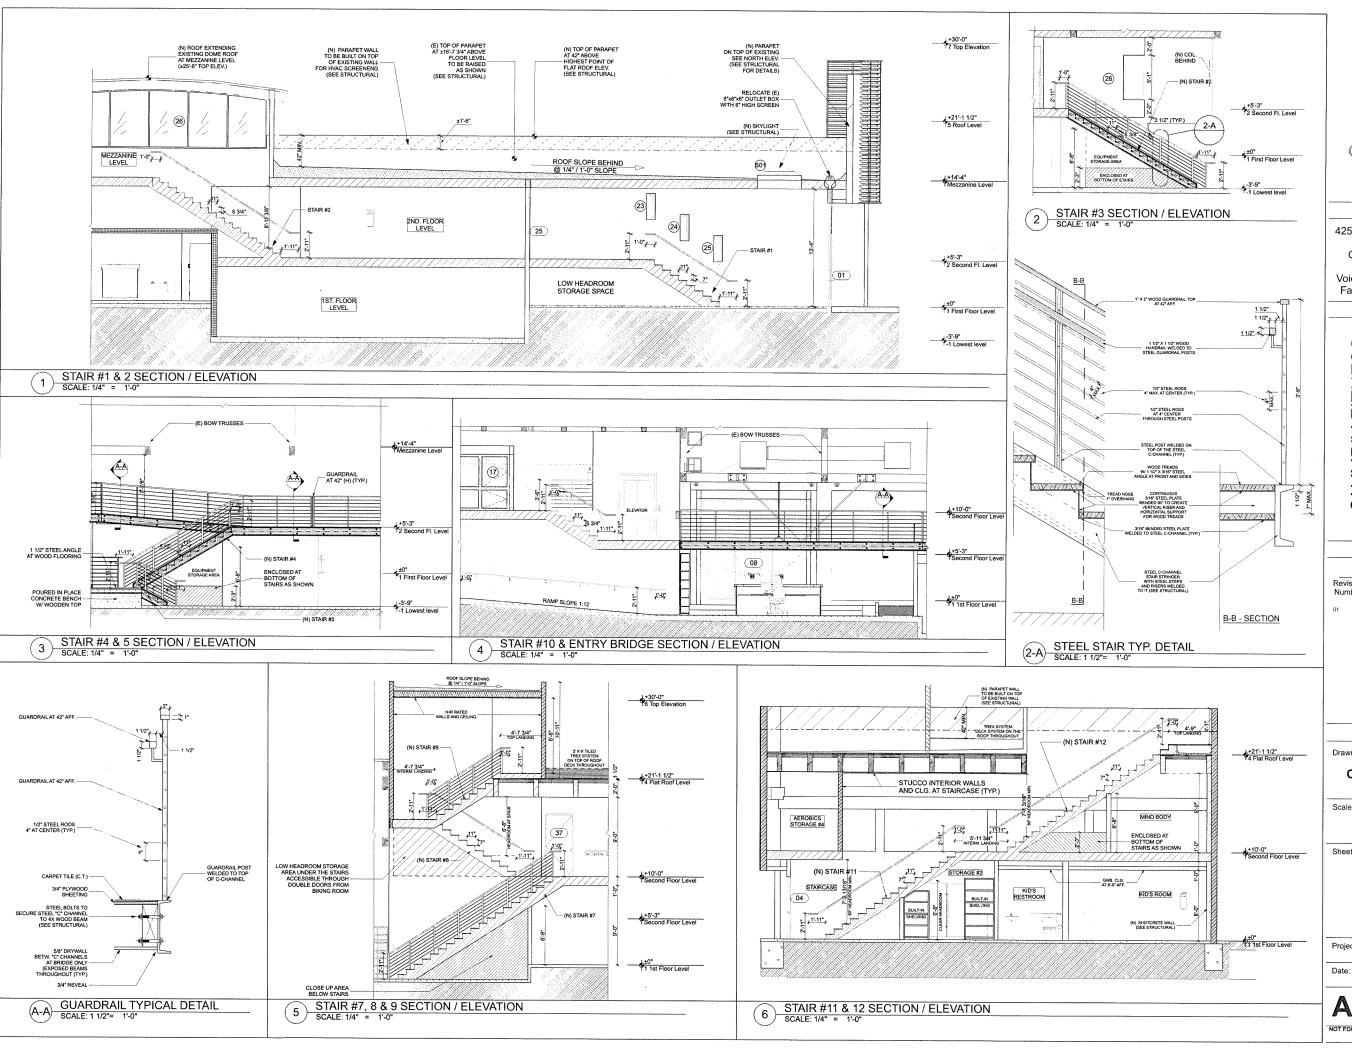



425 East 4th St. Unit E Long Beach California, 90802

Voice: (562) 450-0495 Fax: (562) 436-5222

> **OLYMPIX FITNESS** 4100 E. OCEAN BLVD LONG BEACH, CA. 90803

Revision Schedule Revision Revision Number Description Date

01 BLDG. DEPT. SUBMITTAL 6/5/15

# **CITRON DESIGN GROUP**

Scale:

As noted

Sheet Description:

INTERIOR SECTIONS/ **ELEVATIONS** 


Project No:

KS-01 6/5/2015

A.04.00 NOT FOR CONSTRUCTION



Long Beach California, 90802

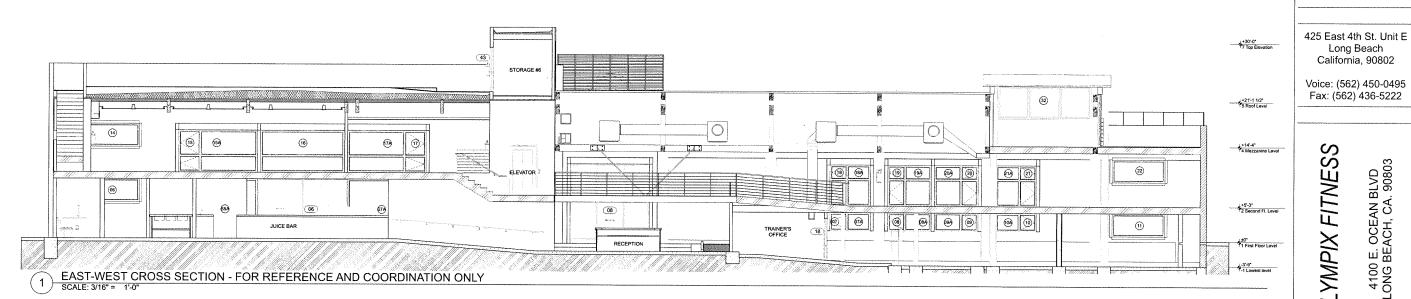

**OLYMPIX FITNESS** 

Revision Schedule Revision Revision Revision Number Description Date

4100 E. OCEAN BLVD LONG BEACH, CA. 90803

01 BLDG. DEPT. SUBMITTAL 6/5/15

**CITRON DESIGN** GROUP

As noted


Sheet Description:


**EAST-WEST** SECTIONS


Project No:

KS-01 6/5/2015

A.04.01

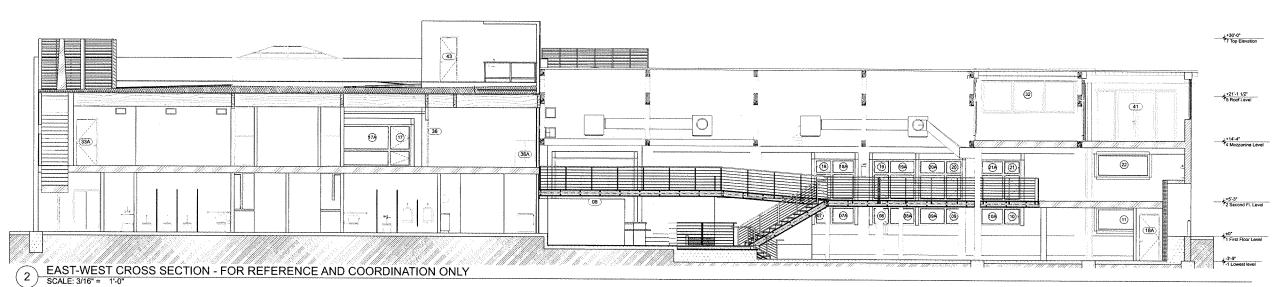

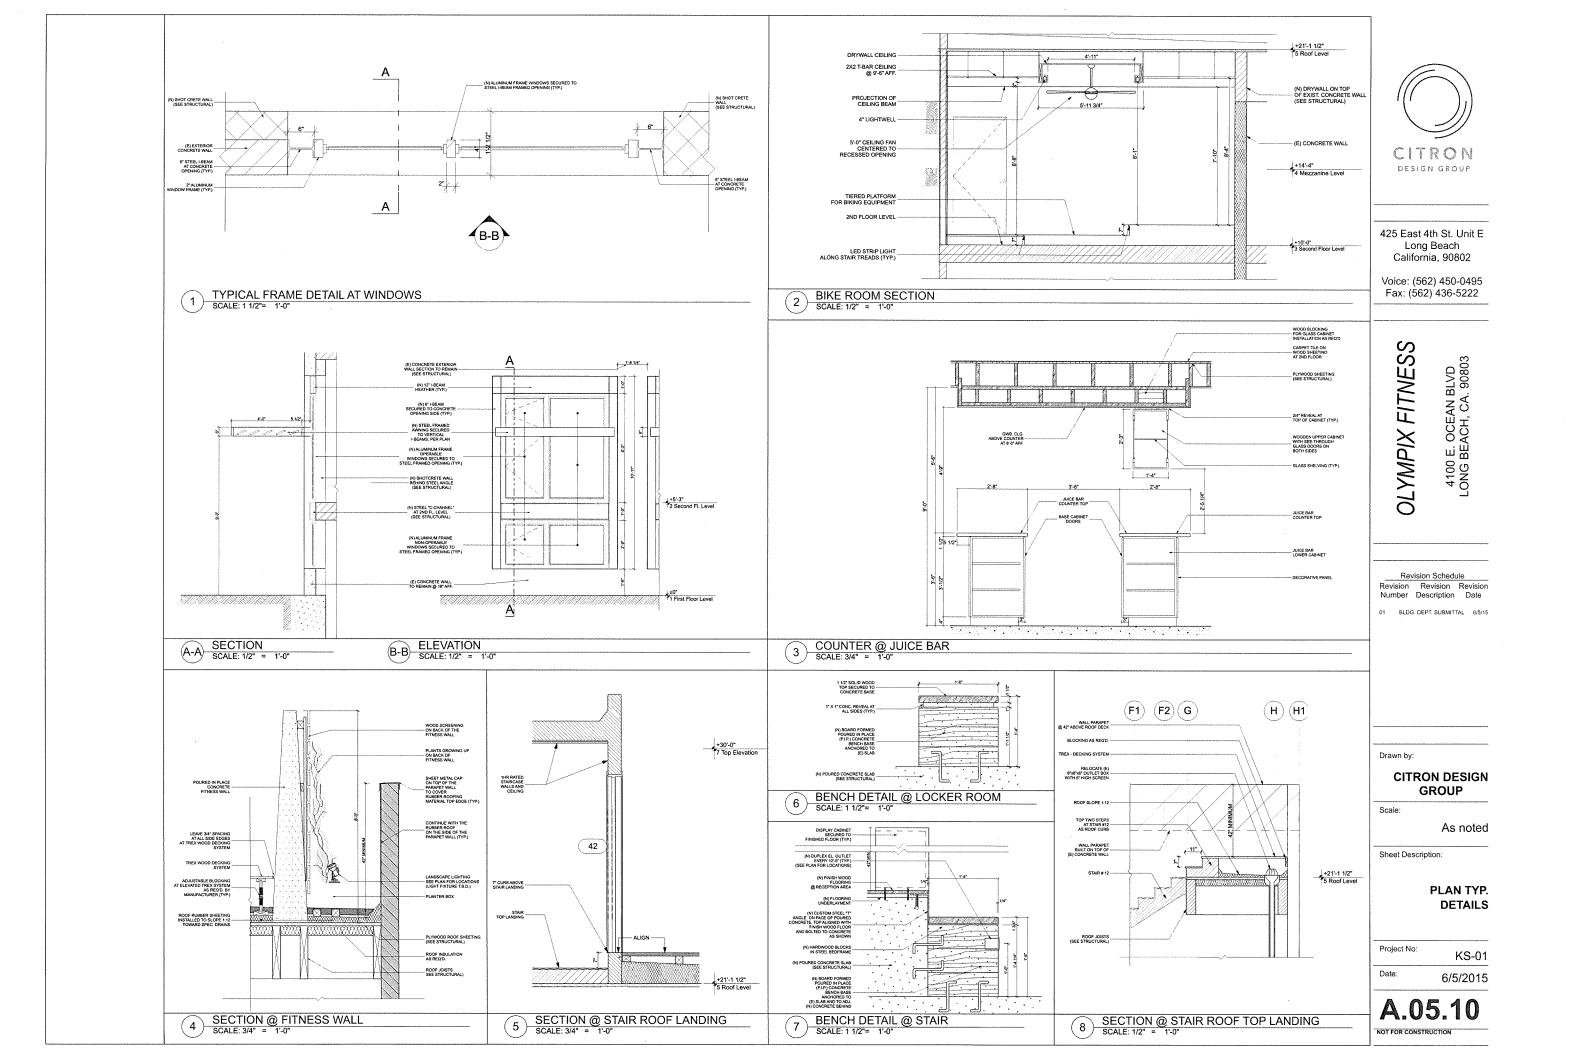

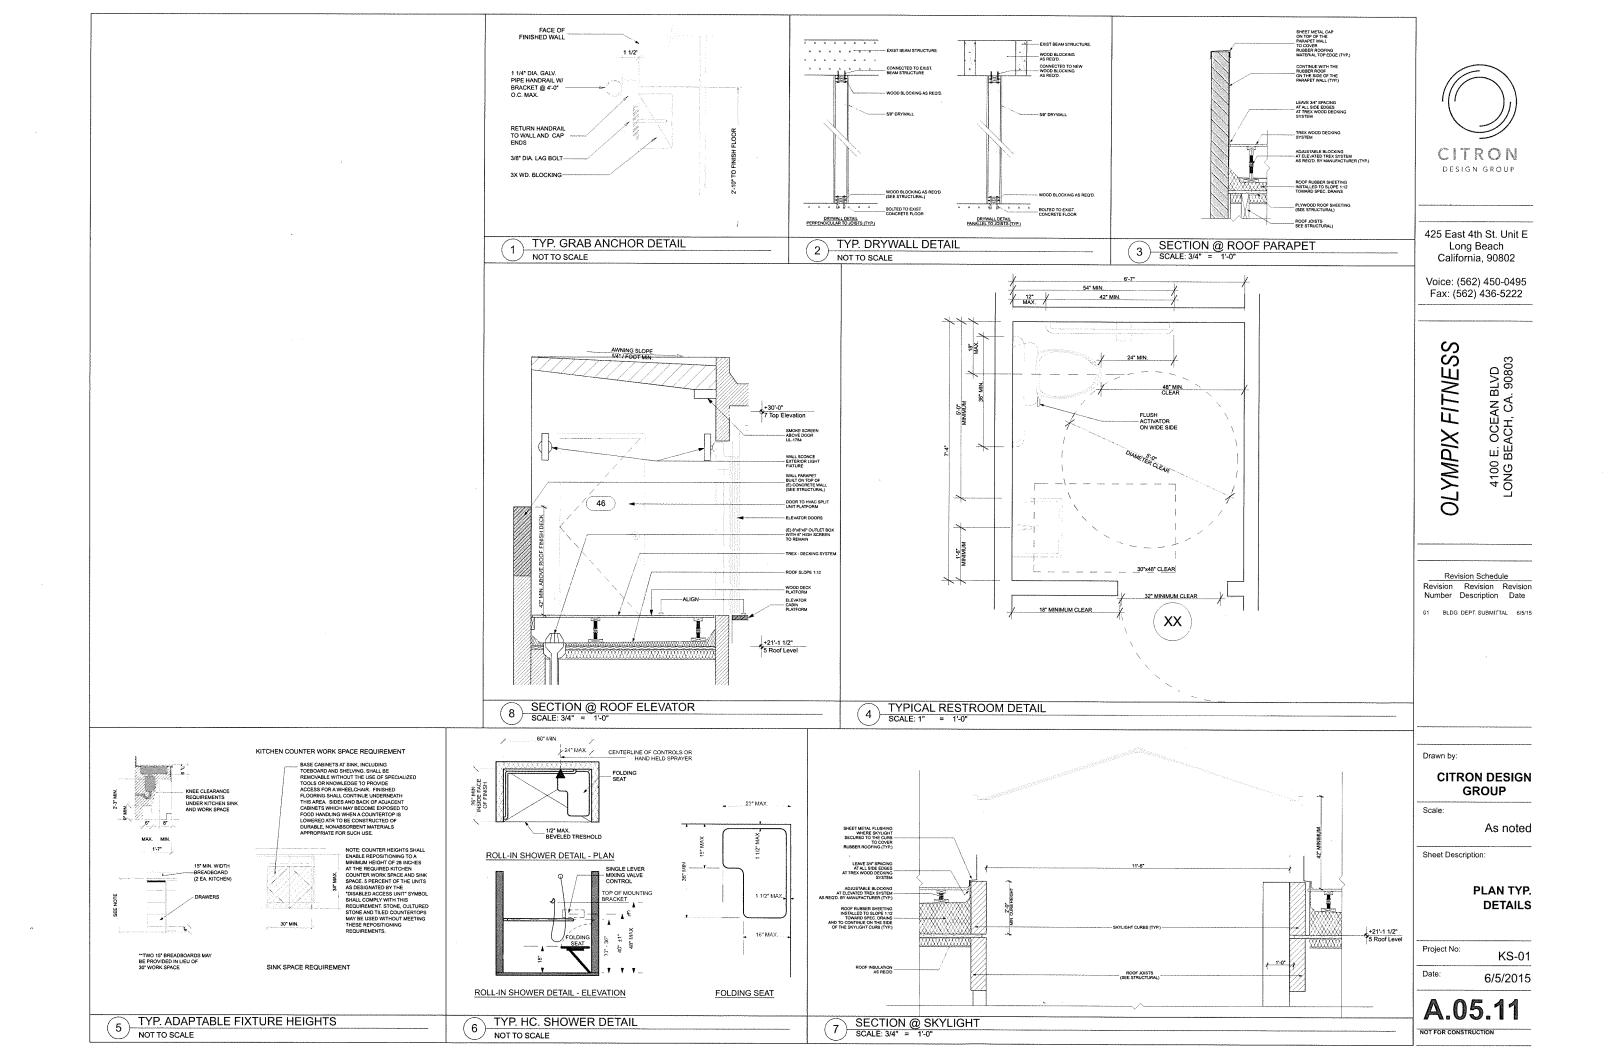

	DOOR SCHEDULE																	
ID	w	HT	OOR THK	GLZ	TRAN	ISOM HEIGHT	SIDE WIDTH	LIGHT	DESCRIPTION	FLOOR	LOCATION	MATERIAL	FINISH	FIRE	FRAME MATERIAL	DOOR	CLOSER	COMMENTS
1	3'-0"	8'-0"	2"	Y	3'-0"	3'-6"	-	-	ENTRY/EXIT DOOR	1ST.	1ST. FL. NORTH-WEST EXIT	ALUM / GLASS	CLEAR	NR	ALUM.	110	X	PANIC HARDWARE
2	6'-0"	8'-0"	2"	Y	6'-0"	3'-6"	-	-	ENTRY/EXIT DOOR	1ST.	1ST. FL. NORTH ELEV.	ALUM / GLASS	CLEAR	NR	ALUM.		x	SIGN: "This door to remain unlocked whenever Building is occupied"
3	3'-0"	8'-0"	2"	Y	7'-1"	5'-1"	4'-0"	8'-0"	ENTRY/EXIT DOOR	15T.	1ST. FL. NORTH ELEV.	SOLID CORE WOOD	PAINT	NR	STEEL	+	х	PANIC HARDWARE
4	3'-0"	7'-0"	1 3/4"	N	-	-	-	-	EXIT DOOR	1ST.	1ST.FL. NORTH-EAST EXIT	SOLID CORE WOOD	PAINT	60MIN.	STEEL	+	X	PANIC HARDWARE
5	3'-0"	8'-10 1/2"	2"	Y	-	-	9'-0"	8'-10 1/2"	ENTRY DOOR	1ST.	1ST.FL. SOUTH-EAST ELEV.	ALUM / GLASS	CLEAR	NR	ALUM.	X	<del>  ^</del> -	TARKE TURNOTTALE
6	13'-2"	8'-10 1/2"	2"	Y	-	-	-	-	ENTRY SLIDING	1ST.	1ST.FL. SOUTH ELEV.	ALUM / GLASS	CLEAR	NR	ALUM.	X		
7	3'-0"	8'-10 1/2"	2"	Y	-	-	9'-0"	8'-10 1/2"	ENTRY DOOR	1ST.	1ST.FL. SOUTH ELEV.	ALUM / GLASS	CLEAR	NR	ALUM.	×		
8	4'-0"	7'-1/2"	2"	Y	5'-1 1/2"	5'-9 3/4"	3'-11"	12'-4"	ENTRY SLIDING	1ST.	1ST.FL. SOUTH ELEV.	ALUM / GLASS	CLEAR	NR	ALUM.	X		
9	3'-6"	7'-0"	2"	N	-	-	-	-	INTERIOR DOOR	1ST.	ELEV. LOBBY	SOLID CORE WOOD	CLEAR	NR	STEEL	X		
10	3'-6"	7'-0"	2"	N	-	-	-	-	INTERIOR DOOR	1ST.	ELEV. LOBBY	SOLID CORE WOOD	CLEAR	NR	STEEL	X		
11	3'-6"	7'-0"	2"	N	-	-	-	-	INTERIOR DOOR	1ST.	ELEV. EQUIP. ROOM	SOLID CORE WOOD	CLEAR	60MIN.	STEEL		×	1HR RATED VENT ON DOOR
11A	3'-0"	5'-0"	1 3/4	N	-	-	-	-	INTERIOR DOOR	1ST.	STORAGE ACCESS AT STAIR	HOLLOW CORE	CLEAR	NR	WOOD	X		
12	3'-0"	7'-0"	1 3/4"	N	-	-	-	-	INTERIOR DOOR	1ST.	RESTROOM DOOR @ JUICE BAR	SOLID CORE WOOD	CLEAR	NR	STEEL	<del>                                     </del>	х	
13	3'-0"	7'-0"	1 3/4"	N	-	-		-	INTERIOR DOOR	1ST.	STORAGE 1	SOLID CORE WOOD	CLEAR	NR	STEEL	X	<u> </u>	
14	3'-0"	7'-0"	1 3/4"	N	-	-	-	-	INTERIOR DOOR	1ST.	KID'S ROOM ENTRY	SOLID CORE WOOD	CLEAR	NR	STEEL	X		
15	3'-0"	7'-0"	1 3/4"	N	-	-	-	-	INTERIOR DOOR	1ST.	KID'S ROOM RESTROOM	SOLID CORE WOOD	CLEAR	NR	STEEL	<del> </del>	Х	
16	3'-0"	7'-0"	1 3/4"	N	-	-	-	-	INTERIOR DOOR	1ST.	STORAGE 2	SOLID CORE WOOD	CLEAR	NR	STEEL	X	<u> </u>	
17	3'-0"	7'-0"	1 3/4"	N	-	-	-	-	INTERIOR DOOR	1ST.	BREAK ROOM	SOLID CORE WOOD	CLEAR	NR	STEEL	X		
18	3'-0"	7'-0"	1 3/4"	N	-	-	-	-	INTERIOR DOOR	1ST.	TRAINER'S OFFICE	SOLID CORE WOOD	CLEAR	NR	STEEL	X		
18A	3'-0"	7'-0"	1 3/4"	N	-	-	-	-	INTERIOR DOOR	1ST.	ELEC/DATA/PHONE CLOSET	SOLID CORE WOOD	CLEAR	NR	STEEL	X		
19	3'-0"	7'-0"	1 3/4"	N	-	-	-	-	INTERIOR DOOR	1ST.	STORAGE 3	SOLID CORE WOOD	CLEAR	NR	STEEL	X		
20	3'-0"	7'-0"	13/4"	N	-	-	-	-	INTERIOR DOOR	1ST.	STEAM ROOM - FEMALE	SOLID CORE WOOD	CLEAR	NR	STEEL	1	X	
21	3'-0"	7'-0"	1 3/4"	N				-	INTERIOR DOOR	1ST.	STEAM ROOM - MALE	SOLID CORE WOOD	CLEAR	NR	STEEL	<b></b>	x	
22	2'-6"	7'-0"	1 3/4"	N N					INTERIOR DOOR	1ST.	JANITOR'S CLOSET	SOLID CORE WOOD	CLEAR	NR	STEEL	Х		
23	3'-0"	7'-0"	13/4"	N N		-	-		INTERIOR DOOR	15T.	PERF.ROOM RESTROOM	SOLID CORE WOOD	CLEAR	NR	STEEL	x		
24	3'-0"	8'-0"	1 3/4"	N.				-	INTERIOR DOOR	15T.	PERF.ROOM ADDL. ENTRY	SOLID CORE WOOD	CLEAR	NR	STEEL	r x		
24A	10'-0"	10'-0"	3"	N	<u> </u>				INTERIOR DOOR	1ST.	BARN SLIDING DOOR	SOLID CORE WOOD	CLEAR	NR	STEEL	x	<u> </u>	
25	3'-0"	7'-0"	1 3/4"	N	-		<del></del>		INTERIOR DOOR	2ND.	NORTH-WEST HALLWAY	SOLID CORE WOOD	CLEAR					
26	3'-0"	7'-0"	13/4"	N N					INTERIOR DOOR	2ND.	OFFICE HALL RESTROOM	SOLID CORE WOOD	CLEAR	60MIN.	STEEL		X	PANIC HARDWARE
27	3'-0"	7'-0"	1 3/4"	N N	<u> </u>		<u>-</u>		INTERIOR DOOR	2ND.	OFFICE HALL RESTROOM OFFICE 4			NR	STEEL	ļ	Х	
28	3'-0"	7'-0"	1 3/4"	N	-		-		INTERIOR DOOR	2ND.	OFFICE 3	SOLID CORE WOOD SOLID CORE WOOD	CLEAR	NR	STEEL	X		
29	3'-0"	7'-0"	1 3/4"	N	<u> </u>	-			INTERIOR DOOR	2ND.	OFFICE 3		CLEAR	NR	STEEL	Х		
30	3'-0"	7'-0"	13/4"	V V					INTERIOR DOOR			SOLID CORE WOOD	CLEAR	NR	STEEL	Х		
31	3'-0"	7'-0"	13/4"	Y					INTERIOR DOOR	2ND.	OFFICE HALL	WOOD / GLASS	CLEAR	NR	STEEL	X		
32	14'-10"	8'-10"	1 3/4"	<del>                                     </del>	<b>-</b>					2ND.	MIND BODY	WOOD / GLASS	CLEAR	NR	WOOD	X		
33	3'-0"	7'-0"	13/4"	N	-		-	-	INTERIOR DOOR	2ND.	MIND BODY	WOOD / GLASS	CLEAR	NR	WOOD	×		FOLDING DOORS STACK OPEN TO SIDE
33A	3'-0"	7'-0"	1 3/4"	N N	<del></del>				INTERIOR DOOR	2ND.	MIND BODY 2ND EXIT	SOLID CORE WOOD	CLEAR	60MIN.	STEEL	<u> </u>	X	
34		7'-0"							INTERIOR DOOR	2ND.	STORAGE 5	SOLID CORE WOOD	CLEAR	NR	STEEL	X		
34A	3'-0"	7'-0"	1 3/4"	N				-	INTERIOR DOOR	2ND.	AEROBICS 2ND. EXIT	SOLID CORE WOOD	CLEAR	60MIN.	STEEL	L	X	
		7'-0"		N N			-		INTERIOR DOOR	2ND.	STORAGE 4	SOLID CORE WOOD	CLEAR	NR	STEEL	X		
35	3'-0"	7'-0"	1 3/4"	N					INTERIOR DOOR	2ND.	AEROBICS ENTRY	SOLID CORE WOOD	CLEAR	NR	STEEL	Х		
36 36A	3'-0"	4'-0"	1 3/4"	N					INTERIOR DOOR	2ND.	BIKING	SOLID CORE WOOD	CLEAR	NR	STEEL	Х		
	4'-1 3/8"		1 3/4"	N	-		-	-	INTERIOR DOOR	2ND.	STORAGE ACCESS AT STAIR	HOLLOW CORE	CLEAR	NR	WOOD	X		
36B	3'-0"	7'-0"	1 3/4"	N	-	-			INTERIOR DOOR	2ND.	HVAC SPLIT UNIT CLOSET	SOLID CORE WOOD	CLEAR	NR	STEEL	Х		
37	3'-0"	7'-0"	1 3/4"	N		-	-	•	INTERIOR DOOR	2ND.	STRETCHING	SOLID CORE WOOD	CLEAR	NR	STEEL	Х		
38	3'-0"	7'-0"	1 3/4"	N	-	•		-	INTERIOR DOOR	2ND.	STORAGE 4	SOLID CORE WOOD	CLEAR	NR	STEEL	Х		
39	3'-0"	6'-8"	2"	Y	-			-	INTERIOR DOOR	MEZZ.	OFFICE 1	ALUM / GLASS	CLEAR	NR	ALUM.	Х		
40	3'-0"	6'-8"	2"	Υ	-	-		-	INTERIOR DOOR	MEZZ.	OFFICE 1	ALUM / GLASS	CLEAR	NR	ALUM.	Х		
41	6'-0"	7'-10"	1 3/4"	N			3'-0"	7'-10"	EXTERIOR DOOR	MEZZ.	OFFICE PATIO	ALUM / GLASS	CLEAR	NR	ALUM.	Х		
42	3'-0"	7'-0"	1 3/4"	N		,	-	-	EXTERIOR DOOR	ROOF	STAIRCASE	STEEL DOOR	PAINT	60MIN.	STEEL		Х	PANIC HARDWARE
43	3'-0"	7'-0"	1 3/4"	N	-	-	-	-	EXTERIOR DOOR	ROOF	STORAGE 6	STEEL DOOR	PAINT	NR	STEEL	х		
44	3'-0"	7'-0"	1 3/4"	N		-		-	EXTERIOR DOOR	ROOF	STORAGE 7	STEEL DOOR	PAINT	NR	STEEL	X		
45	3'-0"	7'-0"	1 3/4"	N			-	-	EXTERIOR DOOR	ROOF	ACCESS TO HVAC AREA	STEEL DOOR	PAINT	NR	STEEL	X		
*MOTE:	THE SA	AVIBALISA SAG		VINGING DO	OR / GATE LE	AE SHALL DE	49" /CBC 10	00 11										L

\*\*NOTE: - THE MAXIMUM WIDTH OF A SWINGING DOOR / GATE LEAF SHALL BE 48" (CBC. 1008.1)

- EGRESS GATES SHALL BE READILY OPENABLE FROM THE EGRESS SIDE WITHOUT THE USE OF A KEY OR SPECIAL KNOWLADGE OR EFFORT. (CBC. 1008.1.9)

- EGRESS COURTS SERVING AS A PORTION OF THE EXIT DISCHARGE IN THE MEANS OF EGRESS SYSTEM SHALL COMPLY WITH THE REQUIREMENTS OF SECTION 1027 (CBC. 1027.4)

	WINDOW SCHEDULE												
WINDOW#	WIDTH	HEIGHT	ABOVE FINISH FL.	LOCATION	FLOOR	MATERIAL	FINISH	FRAME MATERIAL	OPERABLI		COMMENTS		
		***************************************	(AFF.)						YES	NO			
W01	19'-8"	10'-9"	1'-0"	FAÇADE (NORTH)	1ST.	ALUMINUM / GLASS	CLEAR	ALUMINUM		X			
W02	19'-6"	10'-9"	1'-0"	FAÇADE (NORTH)	15T.	ALUMINUM / GLASS	CLEAR	ALUMINUM		Х			
W03	7'-8 1/2"	12'-2"	0'-0"	FAÇADE (NORTH)	1ST.	ALUMINUM / GLASS	CLEAR	ALUMINUM	Х				
W04	16'-0"	3'-0"	6'-0"	FAÇADE (NORTH)	1ST.	ALUMINUM / GLASS	CLEAR	ALUMINUM		Х			
W05	16'-0"	3'-0"	6'-0"	FAÇADE (NORTH)	1ST.	ALUMINUM / GLASS	CLEAR	ALUMINUM		Х			
W06	8'-0"	3'-6"	5'-6"	FAÇADE (SOUTH)	1ST.	ALUMINUM / GLASS	CLEAR	ALUMINUM		X			
S05A	8'-7 13/16"	9'-0"	0'-0"	FAÇADE (SOUTH)	1ST.	ALUMINUM / GLASS	CLEAR	ALUMINUM		X			
S07A	8'-7 13/16"	9'-0"	0'-0"	FAÇADE (SOUTH)	1ST.	ALUMINUM / GLASS	CLEAR	ALUMINUM		X			
W07	2'-6"	2'-9"	1'-6"	FAÇADE (SOUTH)	1ST.	ALUMINUM / GLASS	CLEAR	ALUMINUM	Х				
W07A	3'-7"	2'-9"	1'-6"	FAÇADE (SOUTH)	1ST.	ALUMINUM / GLASS	CLEAR	ALUMINUM		х			
W08	2'-6"	2'-9"	1'-6"	FAÇADE (SOUTH)	1ST.	ALUMINUM / GLASS	CLEAR	ALUMINUM	X	ļ			
W08A	4'-0"	2'-9"	1'-6*	FAÇADE (SOUTH)	1ST.	ALUMINUM / GLASS	CLEAR	ALUMINUM		X	İ		
W09	2'-6"	2'-9"	1'-6"	FAÇADE (SOUTH)	1ST.	ALUMINUM / GLASS	CLEAR	ALUMINUM	×				
W09A	4'-0"	2'-9"	1'-6"	FAÇADE (SOUTH)	1ST.	ALUMINUM / GLASS	CLEAR	ALUMINUM		×			
W10	2'-6"	2'-9"	1'-6"	FACADE (SOUTH)	1ST.	ALUMINUM / GLASS	CLEAR	ALUMINUM	X				
W10A	3'-7"	2'-9"	1'-6"	FACADE (SOUTH)	1ST.	ALUMINUM / GLASS	CLEAR	ALUMINUM		X			
W11	8'-0"	3'-6"	0'-9 1/4"	FAÇADE (SOUTH)	1ST.	ALUMINUM / GLASS	CLEAR	ALUMINUM		X			
W12	16'-0"	5'-9 1/2"	0'-0"	FACADE (NORTH)	2ND.	ALUMINUM / GLASS	CLEAR	ALUMINUM		X			
W13	16'-0"	5'-9 1/2"	0'-0"	FAÇADE (NORTH)	2ND.	ALUMINUM / GLASS	CLEAR	ALUMINUM		X			
W14	8'-0"	3'-6"	3'-10"	FACADE (SOUTH)	2ND.	ALUMINUM / GLASS	CLEAR	ALUMINUM		x			
W15	3'-2"	6'-4"	0'-0"	FAÇADE (SOUTH)	2ND.	ALUMINUM / GLASS	CLEAR	ALUMINUM	x				
	8'-8 11/16"	6'-4"	0'-0"	FAÇADE (SOUTH)	2ND.	ALUMINUM / GLASS		ALUMINUM		X			
W16	12'-7 1/8"	6'-4"	0'-0"	FACADE (SOUTH)	2ND.	ALUMINUM / GLASS	CLEAR	ALUMINUM		x			
W17	3'-2"	6'-4"	0'-0"	FAÇADE (SOUTH)	2ND.	ALUMINUM / GLASS	CLEAR	ALUMINUM		<u> </u>			
	8'-8 11/16"	6'-4"	0'-0"	FACADE (SOUTH)	2ND.	ALUMINUM / GLASS	CLEAR	ALUMINUM	_^_	X			
W18	2'-6"	6'-2"	1'-6"	FACADE (SOUTH)	2ND.	ALUMINUM / GLASS	CLEAR	ALUMINUM					
W18A	3'-7"	6'-2"	1'-6"	FAÇADE (SOUTH)	2ND.	ALUMINUM / GLASS	CLEAR	ALUMINUM	Х	<del></del>			
W19	2'-6"	6'-2"	1'-6"	FACADE (SOUTH)	2ND.				- V	X			
W19A	4'-0"	6'-2"	1'-6"			ALUMINUM / GLASS	CLEAR	ALUMINUM	X	<u> </u>			
W19A W20	2'-6"	6'-2"	1'-6"	FAÇADE (SOUTH)	2ND.	ALUMINUM / GLASS	CLEAR	ALUMINUM	<del></del>	X	ļ		
W20A	4'-0"	6'-2"		FAÇADE (SOUTH)	2ND.	ALUMINUM / GLASS	CLEAR	ALUMINUM	Х	<u> </u>			
W20A W21	2'-6"	6'-2"	1'-6"	FAÇADE (SOUTH)	2ND.	ALUMINUM / GLASS	CLEAR	ALUMINUM	<u> </u>	Х			
	3'-7"	6'-2"	1'-6"	FAÇADE (SOUTH)	2ND.	ALUMINUM / GLASS	CLEAR	ALUMINUM	Х				
W21A			1'-6"	FAÇADE (SOUTH)	2ND.	ALUMINUM / GLASS	CLEAR	ALUMINUM		X			
W22	8'-0"	3'-6"	3'-8 1/4"	FAÇADE (SOUTH)	2ND.	ALUMINUM / GLASS	CLEAR	ALUMINUM		X			
W23	1'-0"	3'-0"	9'-9"	SIDE (WEST)	2ND.	ALUMINUM / GLASS	CLEAR	ALUMINUM		X			
W24	1'-0"	3'-0"	7'-5"	SIDE (WEST)	2ND.	ALUMINUM / GLASS	CLEAR	ALUMINUM		Х			
W25	1'-0"	3'-0"	5'-0"	SIDE (WEST)	1ST.	ALUMINUM / GLASS	CLEAR	ALUMINUM		Х			
W26	2'-0"	5'-1"	1'-0"	INT. OFFICE	2ND.	ALUMINUM / GLASS	CLEAR	ALUMINUM		Х			
W27	27'-0"	5'-1"	1'-0"	INT. OFFICE	2ND.	ALUMINUM / GLASS	CLEAR	ALUMINUM		Х			
W28	4'-0"	4'-0"	3'-0"	INT. OFFICE	2ND.	ALUMINUM / GLASS	CLEAR	ALUMINUM		Х			
W29	2'-0"	4'-0"	3'-0"	INT. OFFICE	2ND.	ALUMINUM / GLASS	CLEAR	ALUMINUM		Х			
W30	25'-6 3/4"	7'-7 13/16"	3'-9 5/8"	SIDE (WEST)	MEZZANINE	ALUMINUM / GLASS	CLEAR	ALUMINUM		Х			
W31	17'-5 1/2"	7'-10"	0'-0"	SIDE (WEST)	MEZZANINE	ALUMINUM / GLASS	CLEAR	ALUMINUM		X			
W32	13'-8"	5'-0"	4'-4"	FAÇADE (SOUTH	MEZZANINE		CLEAR	ALUMINUM	X				
S01	5'-0"(W)	3'-0"(W)	ROOF LEVEL	ROOF	ROOF	ALUMINUM / GLASS	CLEAR	ALUMINUM	X		ROOF SKYLIGHT / PERF.ROOM		
S02		16'-5 7/8"(W)		ROOF	ROOF	ALUMINUM / GLASS		ALUMINUM		<del></del>	ROOF SKYLIGHT / FINISH DECK		



425 East 4th St. Unit E Long Beach California, 90802

Voice: (562) 450-0495 Fax: (562) 436-5222

# OLYMPIX FITNESS

4100 E. OCEAN BLVD LONG BEACH, CA. 90803

Revision Schedule
Revision Revision
Number Description Date

01 BLDG. DEPT. SUBMITTAL 6/5/15

Drawn by:

**CITRON DESIGN** GROUP

As noted

Sheet Description:

DOOR / WINDOW SCHEDULE

Project No:

KS-01 6/5/2015

A.06.00