

PROPOSED:
ADDITION OF (2) BEDROOM, (1) BATH AND
EXPANSION OF EXISTING LIVING ROOM,
AND KITCHEN AND NEW 1 CAR GARAGE

FOR:

HONG TAN
1030 Maine Ave
Long Beach, CA
TEL: 949-232-2219

PROPERTY ADDRESS:
1032 Maine Ave
Long Beach, CA
TEL: 949-232-2219

CITY STAMP

TITLE SHEET:

SITE PLAN & NOTES

DATE: 2.5.2020
JOB No.
SHEET:

A1.0

1. SCOPE OF DOCUMENTS
THESE DRAWINGS INDICATE THE GENERAL SCOPE OF THE PROJECT IN TERMS OF THE DESIGN INTENT, THE DIMENSIONS OF THE BUILDING, THE MAJOR DESIGN ELEMENTS AND THE TYPE OF STRUCTURAL, MECHANICAL, AND ELECTRICAL SYSTEMS ON THE BASIS OF THE GENERAL SCOPE INDICATED OR DESCRIBED. TRAINING AND FINISH WORK TO MATCH EXISTING WILL BE PROVIDED WHETHER SPECIFICALLY CALLED FOR OR NOT WHERE EQUIPMENT OR ITEMS ARE REMOVED. THE CONTRACTOR SHALL FURNISH ALL ITEMS REQUIRED FOR THE PROPER EXECUTION AND COMPLETION OF THE WORK. WHERE HEREAFTER DESCRIBED, "PROVIDED" MEANS TO PROVIDE AND INSTALL.
ALL ITEMS MARKED "N.I.C." ARE NOT PART OF THIS CONTRACT.
ALL WORK SHALL BE APPLIED IN ACCORDANCE WITH THE MANUFACTURER'S LATEST RECOMMENDATIONS OR WRITTEN DIRECTIONS.
2. CONFLICTS WITHIN CONTRACT DOCUMENTS
THE CONTRACTOR SHALL VERIFY ALL EXISTING CONDITIONS, DIMENSIONS, DETAILS, ETC., AND NOTIFY THE DESIGNER OF THE PROJECT OF ANY AND ALL DISCREPANCIES PRIOR TO PROCEEDING WITH THE WORK.
4. DIMENSIONS
A. ALL DIMENSIONS SHALL TAKE PRECEDENCE OVER SCALE. THE DRAWINGS SHALL NEVER BE SCALED. CONTRACTOR SHALL NOTIFY THE DESIGNER OF THE PROJECT IMMEDIATELY OF ANY AND ALL DISCREPANCIES.
B. ALL DIMENSIONS ARE TO FINISH FACE OR CENTERLINE OF STUD OR FACE OF FOUNDATIONAL WALL UNLESS NOTED OTHERWISE.
C. CEILING HEIGHT DIMENSIONS ARE FROM FINISH FLOOR SLAB TO FINISH FACE OF CEILING.
D. EXACT DIMENSIONS FOR ANY BUILT-IN SYSTEM (CABINETS) SHALL BE TAKEN AT THE SITE AND WALLS IN PLACE PRIOR TO MANUFACTURING AND INSTALLATION.
5. EQUIPMENT LOCATIONS
THE LOCATIONS OF APPARATUS AND EQUIPMENT INDICATED ON THE DRAWINGS ARE SCHEMATIC ONLY, AND SHALL BE MODIFIED TO MEET THE EXISTING ARCHITECTURAL, MECHANICAL AND STRUCTURAL CODES AND CONDITIONS AS REQUIRED WITHOUT ADDITIONAL COST TO THE OWNER.
THE CONTRACTOR SHALL INSTALL ALL PIPING AND EQUIPMENT IN A PROPER MANNER AND IN LOCATIONS AVOIDING ALL OBSTRUCTIONS, PRESERVING HEADROOM AND KEEPING OPENINGS AND PASSAGEWAYS CLEAR. THE CONTRACTOR SHALL MAKE CHANGES, WITH OWNER'S APPROVAL, IN LOCATIONS OF EQUIPMENT AND MATERIALS, WHICH MAY BE NECESSARY IN ORDER TO ACCOMPLISH THESE ENDS, WITHOUT ADDITIONAL COST TO THE OWNER.
6. CODES
ALL CONSTRUCTION AND MATERIALS SHALL COMPLY WITH THE APPLICABLE LOCAL CODES, ORDINANCES, AND STANDARDS.
ALL WORK SHALL CONFORM TO ALL REQUIREMENTS OF CALIFORNIA TITLE 24
DETAILS COMPLY WITH THE UNIFORM BUILDING CODE AND CITY STANDARD, INCLUDING STRUCTURAL MEMBER SUCH AS RAFTERS, CEILING JOISTS, AND BEAM SIZES.
7. CONSTRUCTION MEANS & METHODS DURING CONSTRUCTION
THE CONTRACTOR WILL BE RESPONSIBLE FOR OR HAVE CONTROL OR CHARGE OF CONSTRUCTION MEANS, METHODS, TECHNIQUES, SEQUENCES OR PROCEDURES, OR FOR SAFETY PRECAUTIONS AND PROGRAMS IN CONNECTION WITH THE WORK, AND WILL BE RESPONSIBLE FOR ANY FAILURES TO CARRY OUT THE WORK IN ACCORDANCE WITH THE CONTRACT DOCUMENTS.
8. BUILDING LOCATION
THE CONTRACTOR SHALL BE RESPONSIBLE FOR THE ACCURATE PLACEMENT OF THE BUILDING ON THE SITE.
9. JOB SITE USE AND CLEANUP
THE CONTRACTOR SHALL CONFINE HIS OPERATIONS ON THE SITE TO AREAS PERMITTED BY THE OWNER. THE WORK SHALL BE DONE IN ACCORDANCE WITH APPLICABLE LOCAL ORDINANCES, PERMITS AND THE CONTRACT DOCUMENTS. THE JOB SITE SHALL BE MAINTAINED IN A CLEAN, ORDERLY CONDITION FREE OF DEBRIS AND LITTER, AND SHALL NOT BE UNREASONABLY ENCUMBERED WITH ANY MATERIALS OR EQUIPMENT. EACH SUBCONTRACTOR IMMEDIATELY UPON COMPLETION OF EACH PHASE OF HIS WORK, SHALL REMOVE ALL TRASH AND DEBRIS RESULTING FROM HIS OPERATION.
OWNER/CONTRACTOR SHALL POST CERTIFICATE OF INSULATION AND COMPLETED CF-6R AT THE JOB SITE. HE/SHE SHALL ALSO PROVIDE THE STREET ADDRESS LETTERS A MINIMUM OF 6 INCHES.
10. CUTTING, REPAIRING AND PATCHING
THE CONTRACTOR SHALL DO ALL CUTTING, FITTING, OR PATCHING OF HIS WORK THAT MAY BE REQUIRED TO MAKE ITS SEVERAL PARTS FIT TOGETHER PROPERLY AND SHALL NOT ENDANGER ANY OTHER WORK BY CUTTING, EXCAVATING, OR OTHERWISE ALTERING THE TOTAL WORK OR ANY PART OF IT. ALL PATCHING, REPAIRING AND REPLACING OF MATERIALS AND SURFACES, CUT OR DAMAGED IN EXECUTION OF WORK, SHALL BE DONE WITH APPLICABLE MATERIALS SO THAT SURFACES REPLACED SHALL, UPON COMPLETION, MATCH SURROUNDING SIMILAR SURFACES.
11. BLOCKING AND BACKING
PROVIDE ALL NECESSARY BLOCKING, BACKING AND FRAMING FOR LIGHT FIXTURES, ELECTRIC UNITS, AND ALL OTHER ITEMS REQUIRING SUCH SUPPORT AND CONNECTION.
12. FLASHING AND SHEET METAL
THE BUILDING SHALL BE FULLY WEATHER-TIGHT. ALL BUILDING PENETRATIONS SHALL BE FLASHED AND SEALED. HOLES IN FINISHES OR UNFLASHED CONDITIONS WILL NOT BE ACCEPTED. ALL BUILDING PENETRATIONS SHALL BE FULLY FLASHED PER THE STANDARDS OF THE "SHEET METAL AND AIR CONDITIONING CONTRACTORS NATIONAL ASSOCIATION'S (SMACNA) ARCHITECTURAL SHEET METAL MANUAL. THESE STANDARDS SHALL BE APPLIED TO ALL FLASHING AT DRIPS ON TOP OF DOORS AND WINDOWS. WHETHER DETAILED OR NOT, ALL CONDITIONS SHALL BE PROPERLY FLASHED.
13. PROTECTION OF WORK
ALL FINISH MATERIALS SHALL BE PROTECTED AT ALL TIMES AGAINST SUBSEQUENT DAMAGE, UNTIL FINAL ACCEPTANCE BY THE OWNER.
14. MISCELLANEOUS
CONTRACTOR TO PROVIDE ALL SAMPLES OF MATERIAL AND COLOR INCLUDING SELECTION OF DOORS, WINDOWS, TILES, TUBS, SINKS, ROOF AND EQUIPMENTS AND ETC., PRIOR TO INSTALLATION.
CONTRACTOR TO OBTAIN SEPARATE PERMITS FOR ELECTRICAL, MECHANICAL, PLUMBING AND DEMOLITION AS REQUIRED.
ALL NEW WATER CLOSETS (TOILETS) SHALL BE OF LOW-FLOW DESIGN WHICH USES NO MORE THAN 1.6 GALLONS PER FLUSH.
LAUNDRY FACILITIES SHALL BE ON A SEPARATE CIRCUIT.
ONE OPENABLE WINDOW WITH AN OPENABLE AREA OF AT LEAST 5.7 SQUARE FEET, WITH A MINIMUM CLEAR DIMENSION OF 20" WIDE BY 24" HIGH AND A SILL HEIGHT NOT OVER 44" FROM FINISH FLOOR IS REQUIRED IN ALL SLEEPING ROOMS.
A NON-TOXIC NON-FLAMMABLE WEED AND GRASS KILLER SHALL BE APPLIED TO ALL GROUND AREAS BELOW NEW PAVING AND METTING. THE WEED KILLER SHALL BE APPLIED AT A RATE WHICH GUARANTEES NO WEED, GRASS, PLANT, MUSHROOM, OR OTHER GROWTH TO OCCUR FOR A PERIOD OF ONE YEAR FROM DATE OF APPLICATION.
15. CITY NOTES
A. THE CONSTRUCTION SHALL NOT RESTRICT A FIVE-FOOT CLEAR AND UNOBSTRUCTED ACCESS TO ANY WATER OR POWER DISTRIBUTION FACILITIES (POWER POLES, PULL-BOXES, TRANSFORMERS, VALVES, PUMPS, VALVES, METERS, APPURTENANCES, ETC.) OR TO THE LOCATION OF THE HOOD-UP. THE CONSTRUCTION SHALL NOT BE WITHIN TEN FEET OF ANY POWER LINES WHETHER OR NOT THE LINES ARE LOCATED ON THE PROPERTY. FAILURE TO COMPLY MAY CAUSE CONSTRUCTION DELAYS AND/OR ADDITIONAL EXPENSES.
B. AN APPROVED SEISMIC GAS SHUTOFF VALVE WILL BE INSTALLED ON THE FUEL GAS LINE ON THE DOWNSTREAM SIDE OF THE UTILITY METER AND BE PROPERLY CONNECTED TO THE EXTERIOR OF THE BUILDING OR STRUCTURED TO THE EXTERIOR OF THE BUILDING OR STRUCTURE CONTAINING THE FUEL GAS PIPING. (PER ORDINANCE 170.158) (SEPARATED PLUMBING PERMIT IS REQUIRED).
C. PLUMBING FIXTURES ARE REQUIRED TO BE CONNECTED TO A SANITARY SEWER OR TO AN APPROVED SEWAGE DISPOSAL SYSTEM (R336.3).
D. KITCHEN SINKS, LAVATORIES, BATHTUBS, SHOWERS, BIDETS, LAUNDRY TUBS AND WASHING MACHINE OUTLETS SHALL BE CONNECTED TO AN APPROVED WATER SUPPLY (R336.4).
E. BATHTUB AND SHOWER FLOORS, WALLS ABOVE BATHTUBS WITH A SHOWERHEAD, AND SHOWER COMPARTMENTS SHALL BE FINISHED WITH A NONABSORBENT SURFACE. SUCH WALL SURFACES SHALL EXTEND TO A HEIGHT OF NOT LESS THAN 6 FEET ABOVE THE FLOOR (R307.2).
F. PROVIDE ULTRA-LOW FLUSH WATER CLOSETS FOR ALL NEW CONSTRUCTION. EXISTING SHOWER HEADS AND TOILETS MUST BE ADAPTED FOR LOW WATER CONSUMPTION.
G. UNIT SKYLIGHTS SHALL BE LABELED BY A L.A. CITY APPROVED LABELING AGENCY, SUCH LABEL SHALL STATE THE APPROVED LABELING NAME, PRODUCT DESIGNATION AND PERFORMANCE GRADE RATING. (RESEARCH REPORT NOT REQUIRED). (R308.6.9)
H. WATER HEATER MUST BE STRAPPED TO WALL. (SEC. 507.3, LABC).
I. FOR EXISTING POOL ON SITE, PROVIDE AN ALARM FOR DOORS TO THE DWELLING THAT FORM A PART OF THE POOL ENCLOSURE. THE ALARM SHALL SOUND CONTINUOUSLY FOR A MIN. OF 30 SECONDS WHEN THE DOOR IS OPENED. IT SHALL AUTOMATICALLY RESET AND BE EQUIPPED WITH A MANUAL MEANS TO DEACTIVATE (FOR 15 SECS.) (LABC) FOR A SINGLE OPENING. THE DEACTIVATION SWITCH SHALL BE AT LEAST 5'4" ABOVE THE FLOOR. (6.109 OF LABC).
J. FOR EXISTING POOL ON SITE, PROVIDE AN ANTI-ENTRAPMENT COVER MEETING THE CURRENT ASTM OR ASME FOR THE SUCTION OUTLETS OF THE SWIMMING POOL, TODDLER POOL, AND SPA FOR SINGLE FAMILY DWELLINGS PER ASSEMBLY BILL (AB) NO. 2077. (3.169B).
K. AUTOMATIC GARAGE DOOR OPENERS, IF PROVIDED, SHALL BE LISTED IN ACCORDANCE WITH UL 325. (R309.4).
L. SMOKE DETECTORS SHALL BE PROVIDED FOR ALL DWELLING UNITS INTENDED FOR HUMAN OCCUPANCY, UPON THE OWNER'S APPLICATION FOR A PERMIT FOR ALTERATIONS, REPAIRS, OR ADDITIONS, EXCEEDING ONE THOUSAND DOLLARS (\$1000). (R314.6.2)
M. WHERE A PERMIT IS REQUIRED FOR ALTERATIONS, REPAIRS OR ADDITIONS EXCEEDING ONE THOUSAND DOLLARS (\$1000), EXISTING DWELLINGS OR SLEEPING UNITS THAT HAVE ATTACHED GARAGES OR FUEL-BURNING APPLIANCES SHALL BE PROVIDED WITH A CARBON MONOXIDE ALARM IN ACCORDANCE WITH SECTION R315.2. CARBON MONOXIDE ALARMS SHALL ONLY BE REQUIRED IN THE SPECIFIC DWELLING UNIT OR SLEEPING UNIT FOR WHICH THE PERMIT WAS OBTAINED. (R315.2.2).
N. EVERY SPACE INTENDED FOR HUMAN OCCUPANCY SHALL BE PROVIDED WITH NATURAL LIGHT BY MEANS OF EXTERIOR GLAZED OPENINGS IN ACCORDANCE WITH SECTION R303.1 OR SHALL BE PROVIDED WITH ARTIFICIAL LIGHT THAT IS ADEQUATE TO PROVIDE AN AVERAGE ILLUMINATION OF 6 FOOT-CANDELS OVER THE AREA OF THE ROOM AT A HEIGHT OF 30 INCHES ABOVE THE FLOOR LEVEL. (R303.1).
O. A COPY OF THE ELEVATION REPORT AND/OR CONDITIONS OF LISTING SHALL BE MADE AVAILABLE AT THE JOB SITE.
16. THE SPRINKLER SYSTEM SHALL BE APPROVED BY PLUMBING DIVISION PRIOR TO INSTALLATION.

DESIGN CODES:

- 1). 2016 CRC, GEC, CPC, CMC, & TITLE 24 ENERGY STANDARDS.
2). 2016 CALGREEN, 2017 LEVIG
3). 2016 CALIFORNIA ENERGY CODE (TITLE 24) AND TITLE 19 OF THE LONG BEACH MUNICIPAL CODE.

BUILDING DATA:

ZONE = PD-10 (R-2-N)
AFN # = 1271-021-011
TRACE = 1630
LOT = 4
OCCUPANCY TYPE = SFD- R3
FIRE SPRINKLER SYSTEM = N/A
EXISTING LOT SIZE = 50'X150' = 7500 SQ. FT.
ALLOW LOT COVERAGE = 50%
FLOOR AREA RATIO = 60%
STORIES = 1 STORY
MAIN HOUSE AREA = 854 SQ. FT.
EXISTING ADU (22'-3"X22'-3") = 494 SQ. FT.
EXISTING GARAGES = 400 SQ. FT.
FLOOR AREA RATIO = (854+494+854)/7500 = 0.24 = 24%

PROPOSED ADDITION TO ADU = 487+367+854 SQ. FT.
REMOVE & REPLACE 1 CAR GARAGE = 286 SQ. FT.
OPEN SPACE = 1958 SQ. FT.
LOT COVERAGE = (854+494+854+400+286)/7500 = 0.58 = 58%

BUILDING DATA

3

WOOD STUD	INTERIOR ELEVATION	SHT. NO.
INSULATION	WINDOW LETTER	DET. NO.
MASONRY	DOOR NUMBER	
FINISH WOOD	SECTION DESIGNATION	
CERAMIC	SHEET NUMBER	
GYPSUM BOARD	DETAIL NUMBER	
SHOTCRETE	SHEET NUMBER	
CONCRETE	GRID LINE	
METAL	KEY NOTE	
PLYWOOD	EXTERIOR COLOR & MATERIAL	

SYMBOLS


3

VICINITY

2

SHEET INDEX

2

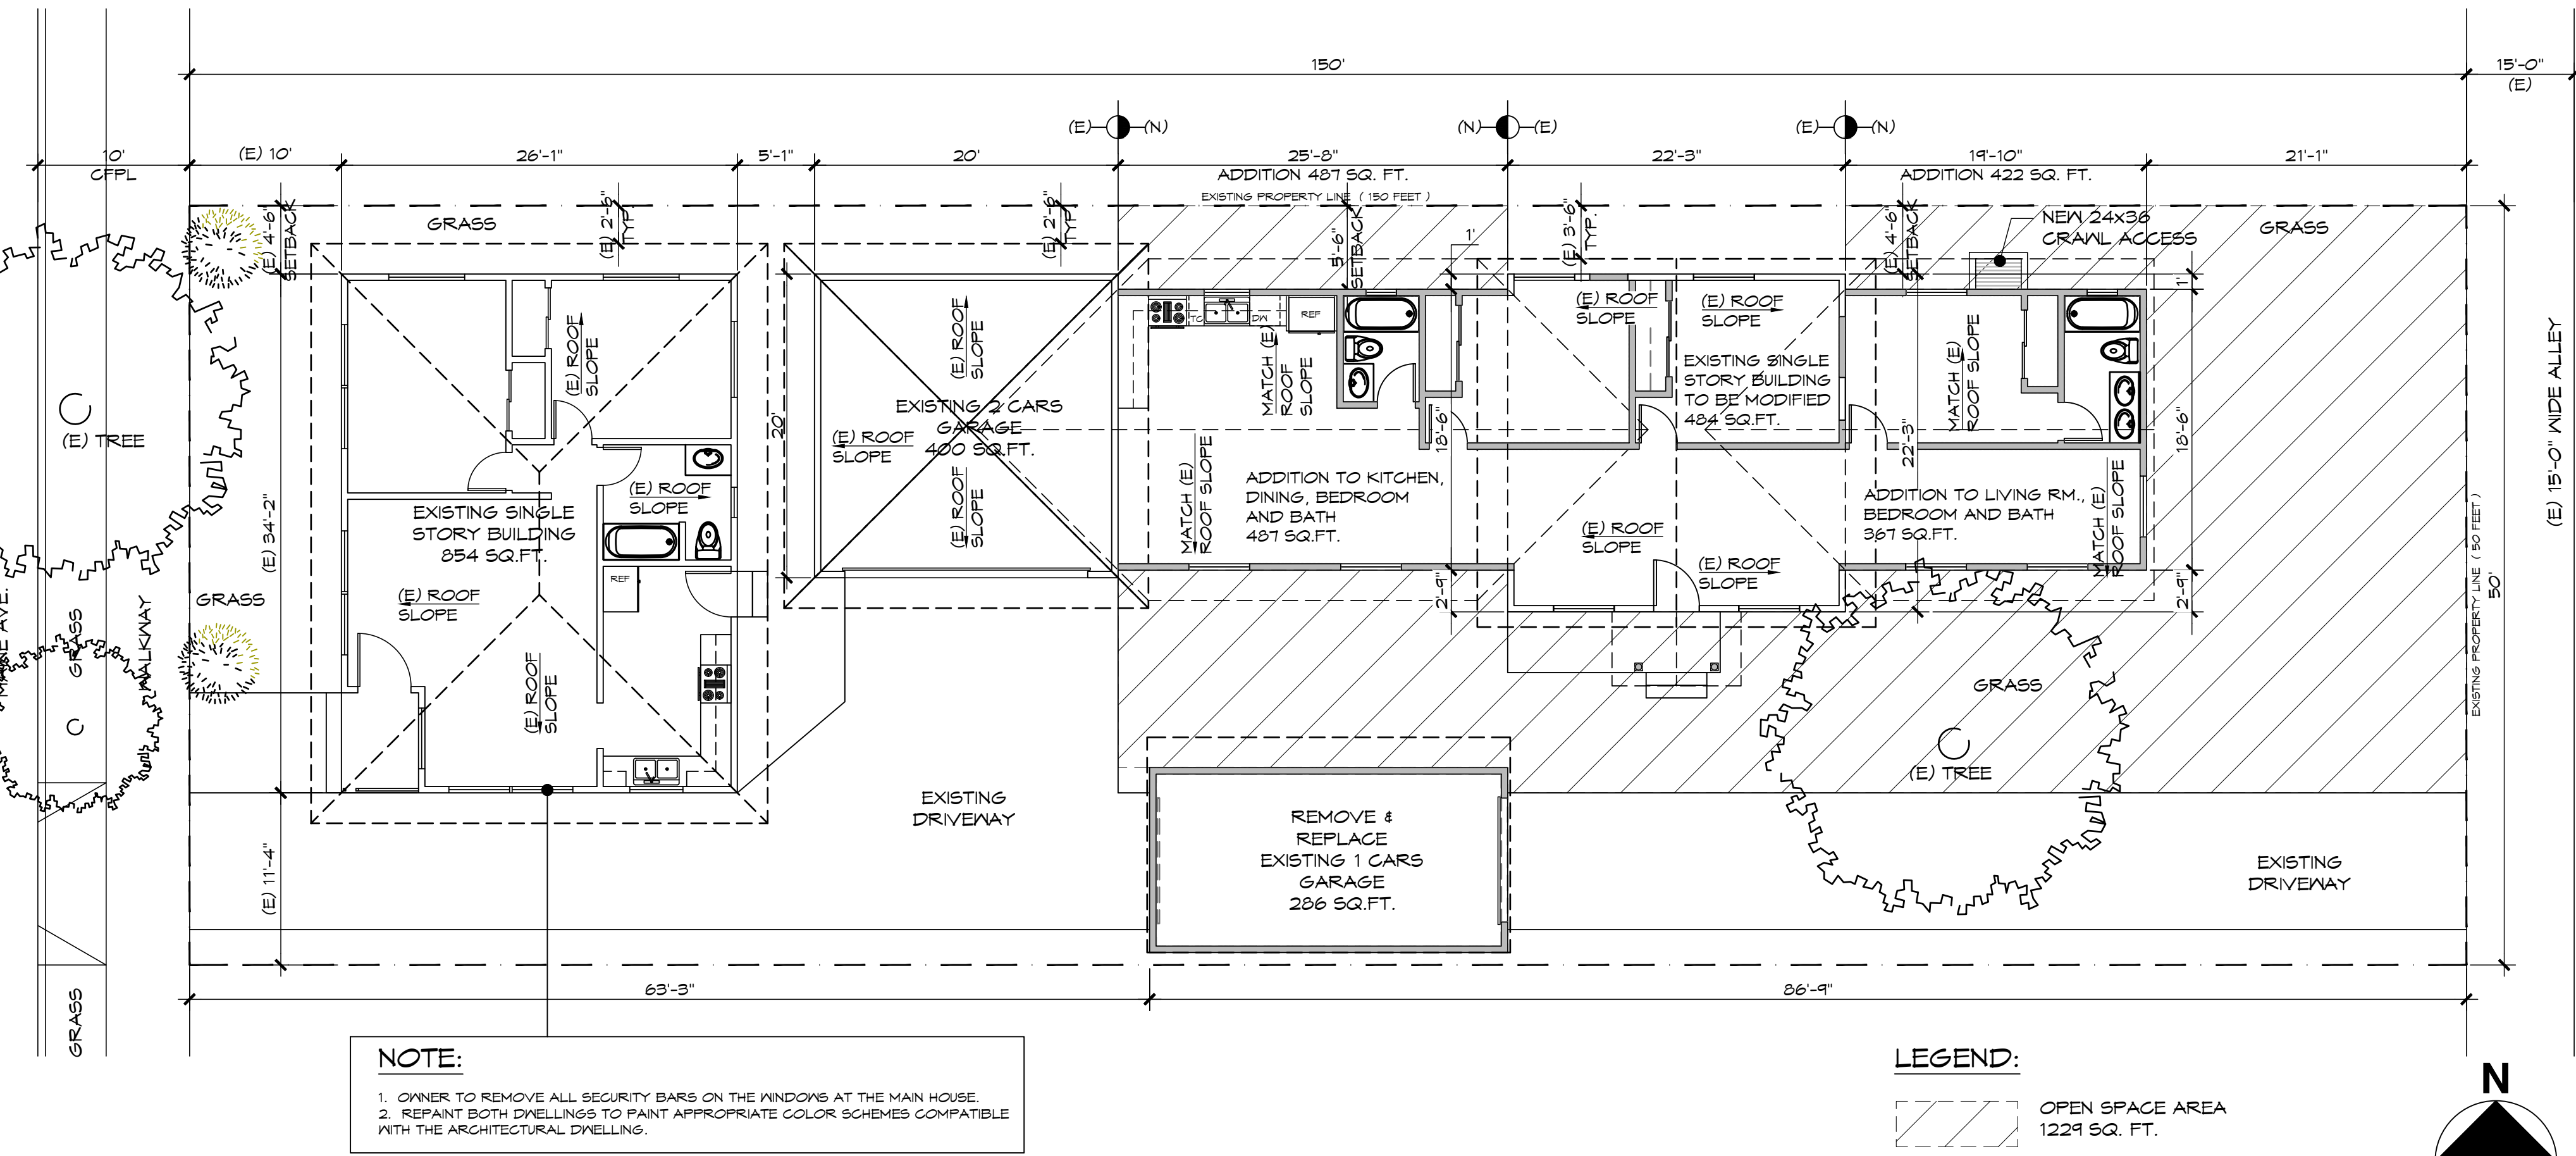

GENERAL NOTES

17 SITE PLAN

SCALE: 1/8" = 1'-0"

FILE:

1

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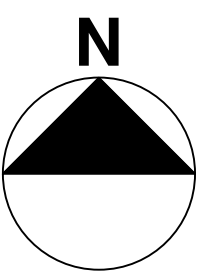
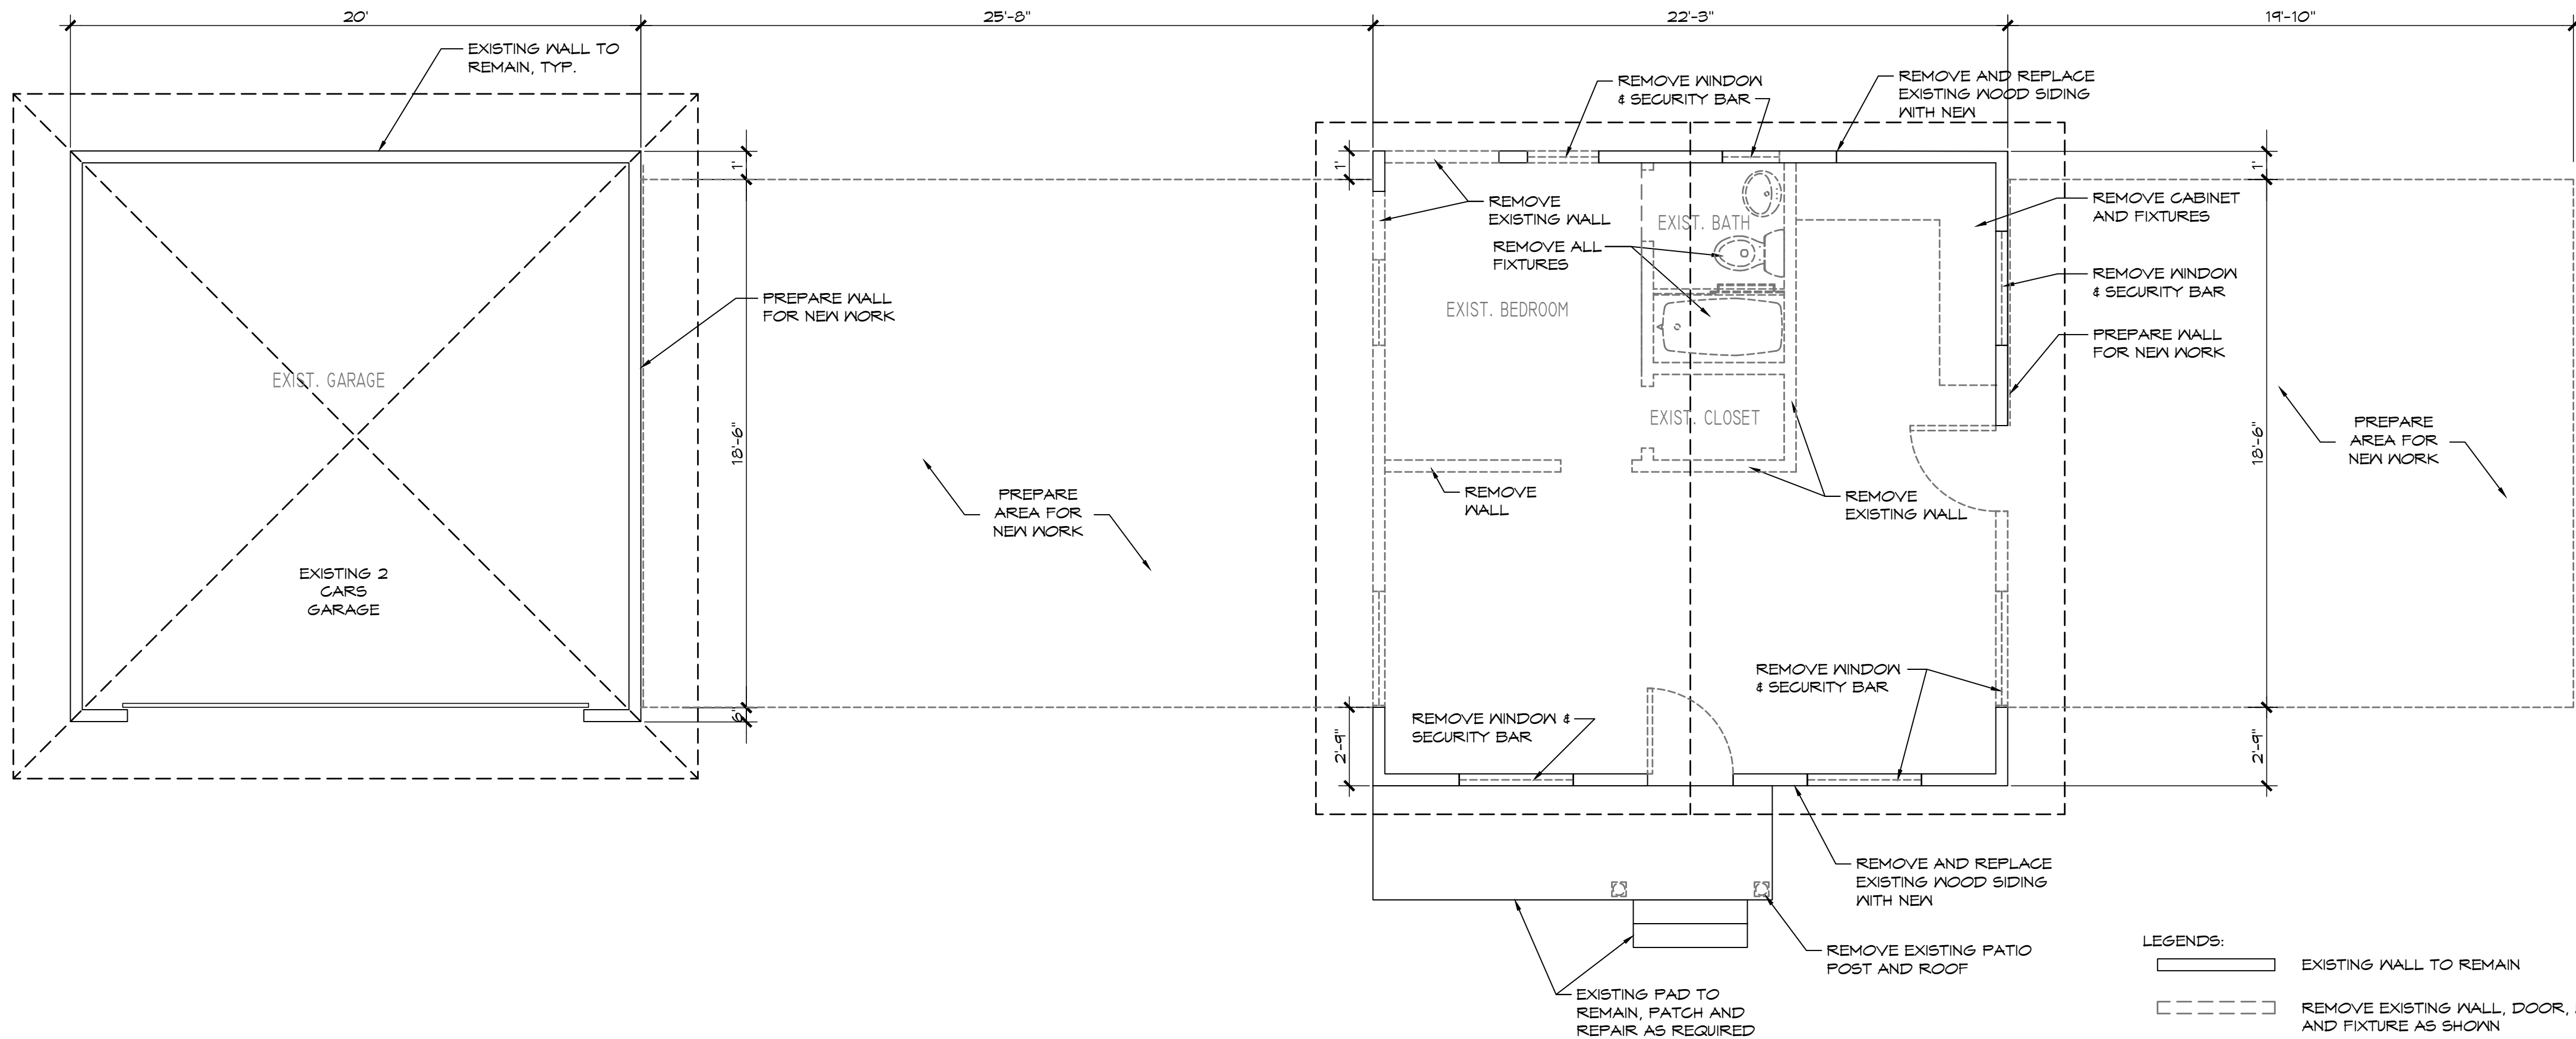
CITY STAMP

TITLE SHEET:

**DEMO & CONSTRUCTION
FLOOR PLANS**

DATE: 2.5.2020
JOB No.
SHEET:



A2.0



DEMO FLOOR PLAN

SCALE: 1/4" = 1'-0"
FILE:

2

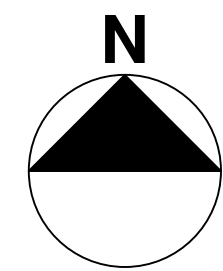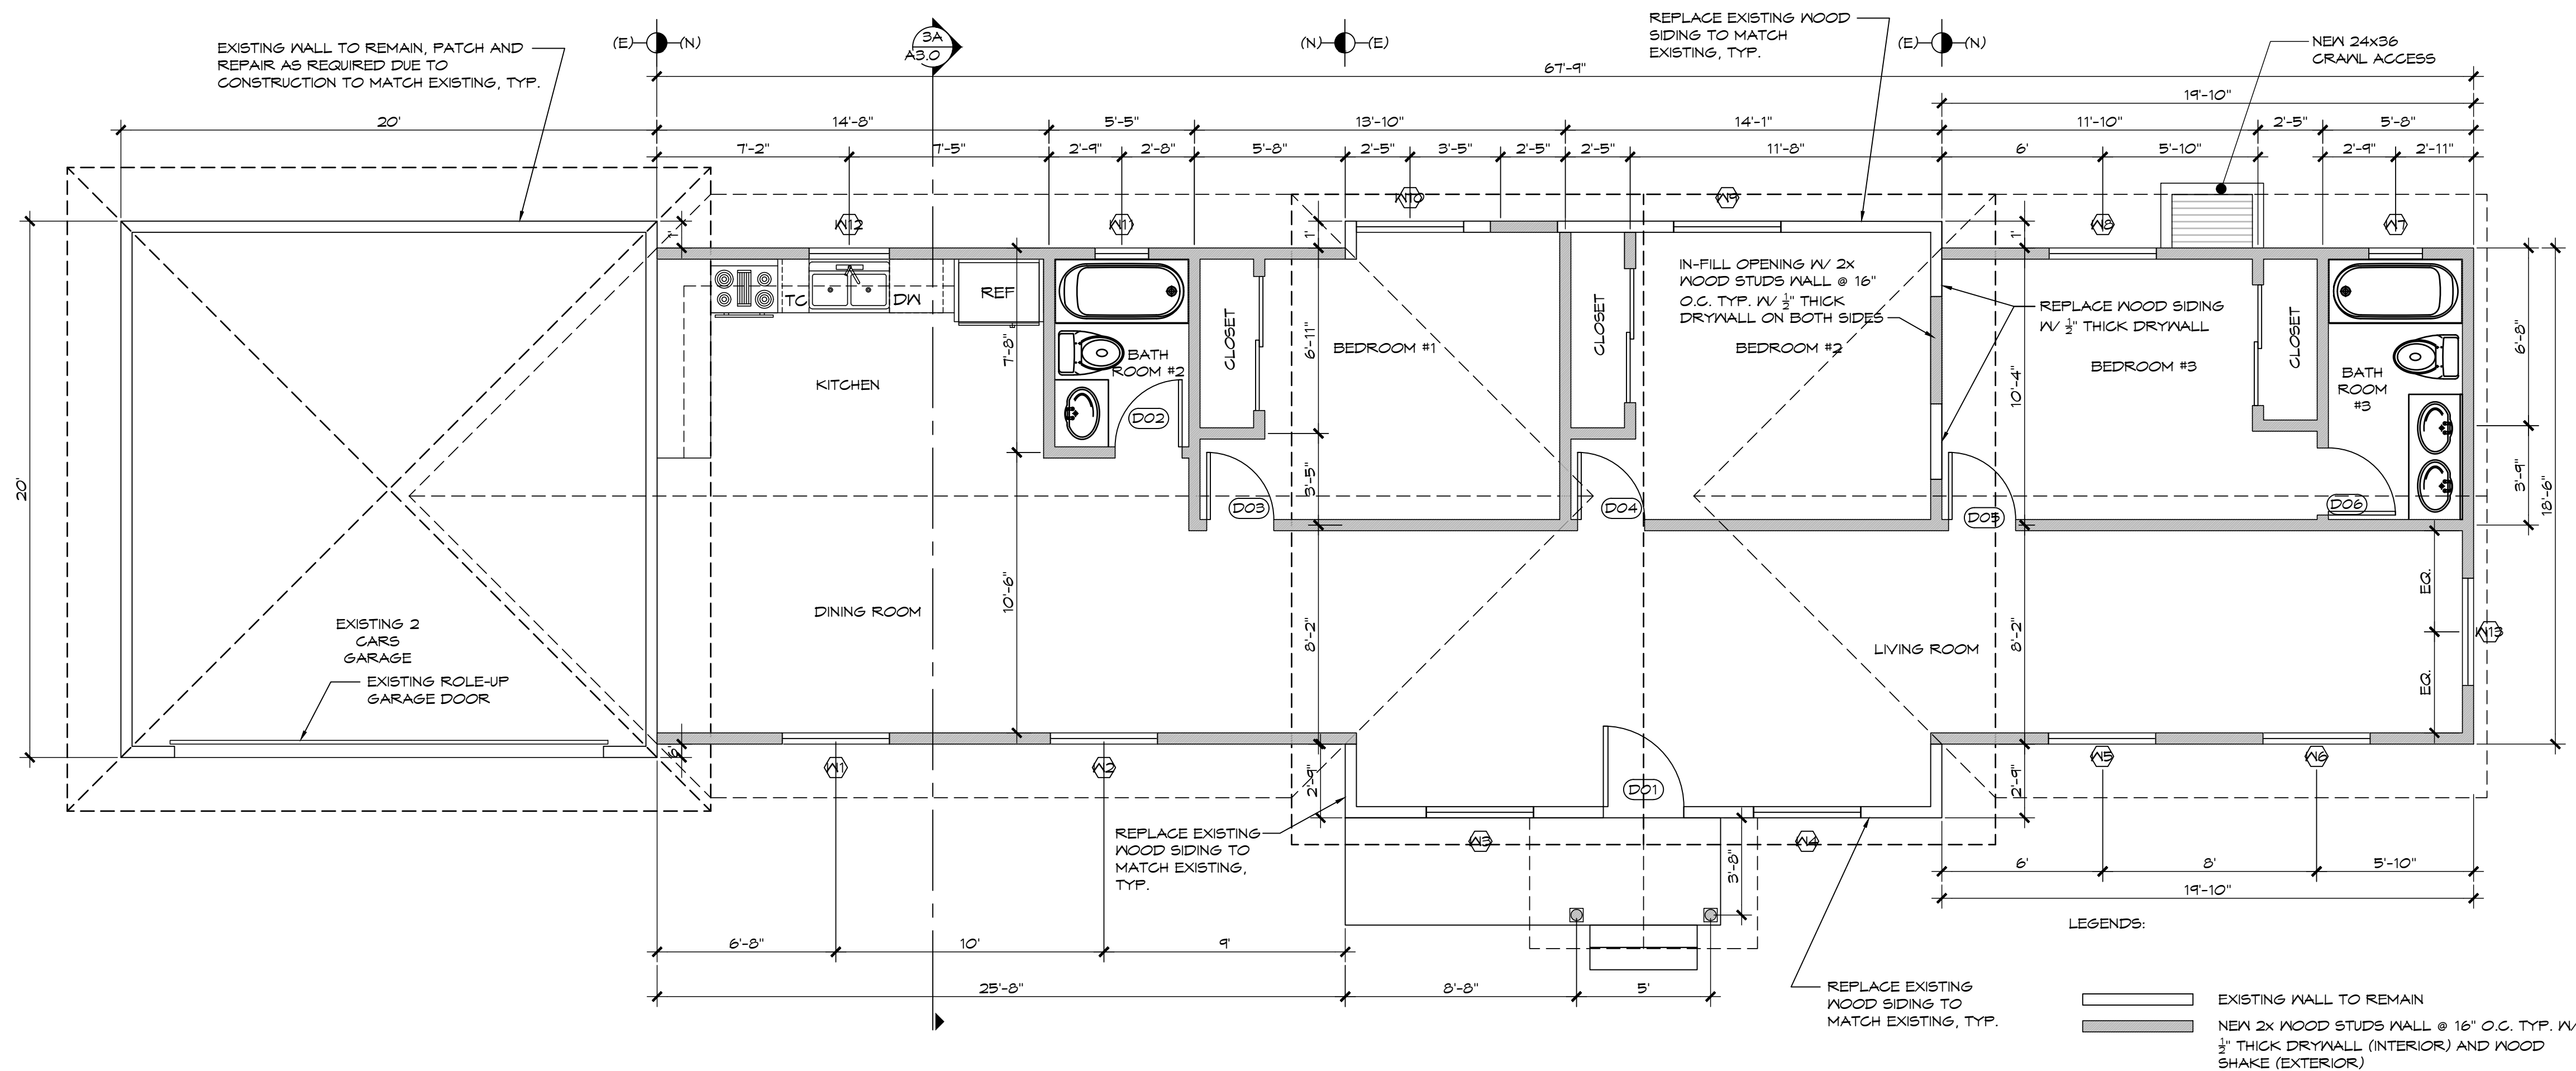

PROPOSED FLOOR PLAN

SCALE: 1/4" = 1'-0"
FILE:

1

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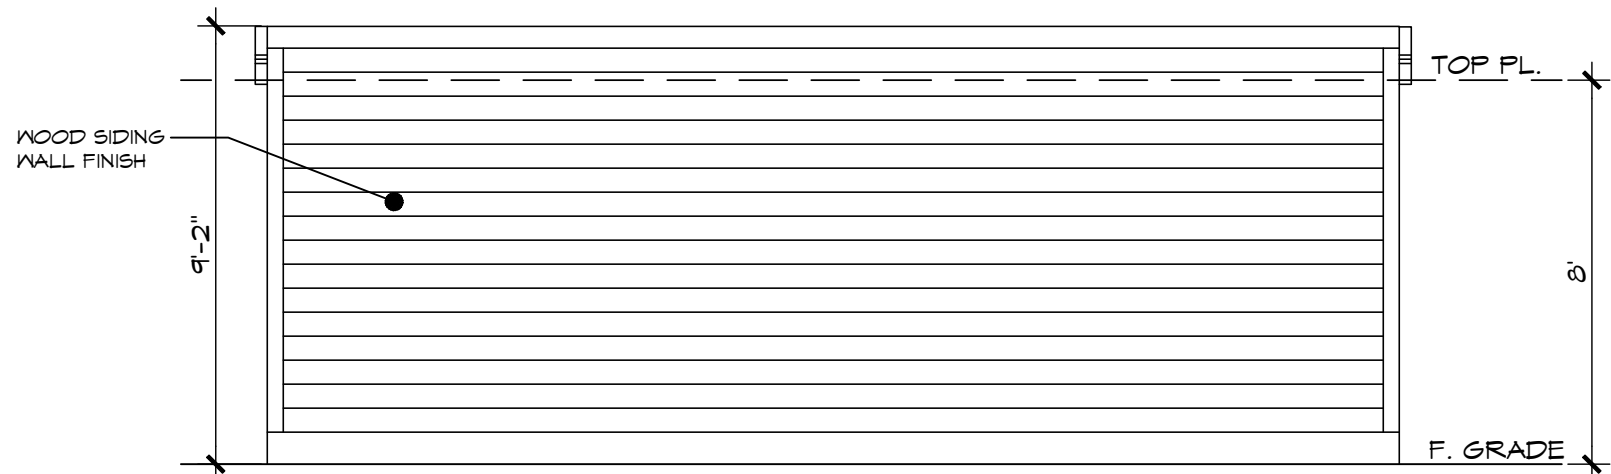
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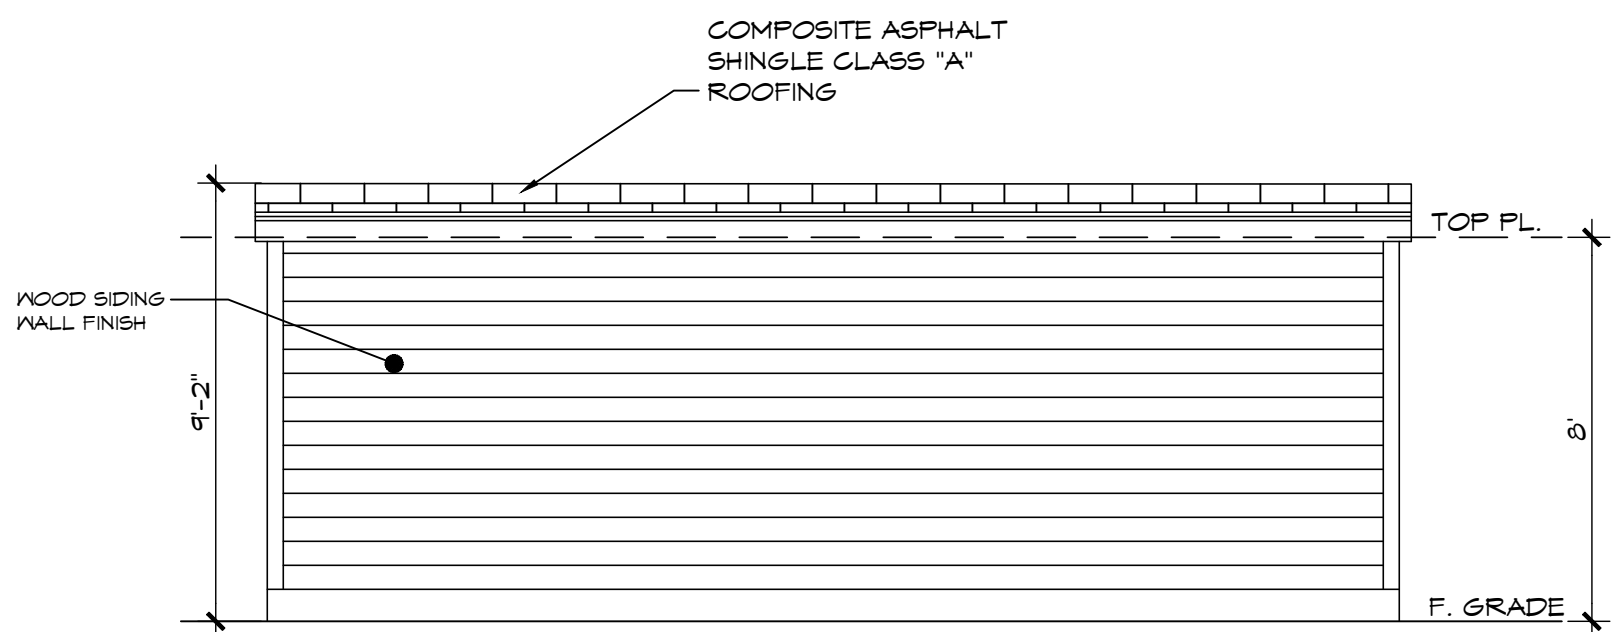
NEW GARAGE FLOOR
PLAN & ELEVATION

DATE: 2.5.2020
JOB No. -
SHEET:


A2.1




SOUTH ELEVATION




NORTH ELEVATION

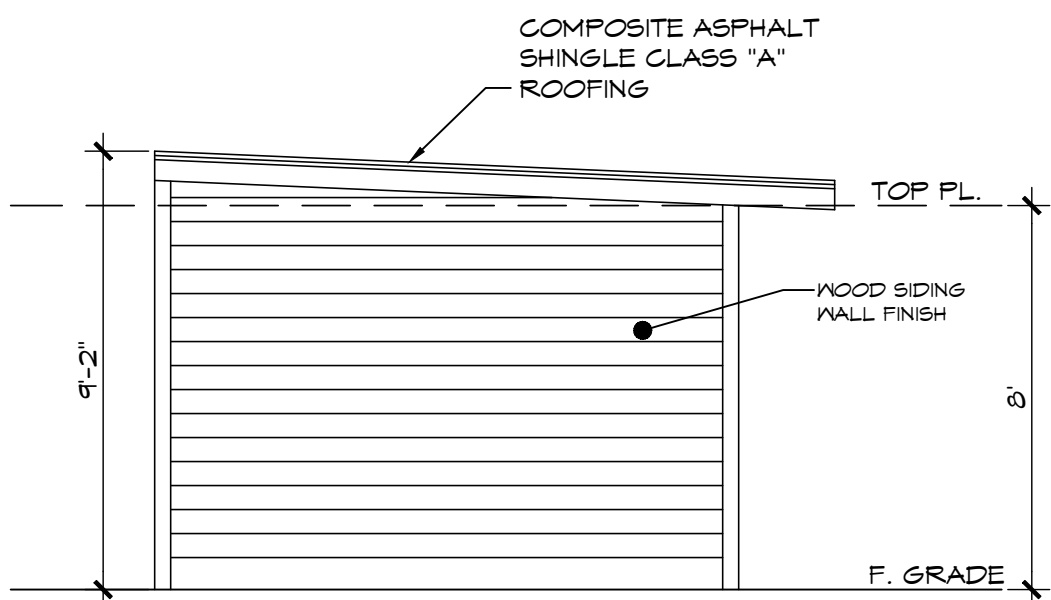

WEST ELEVATION

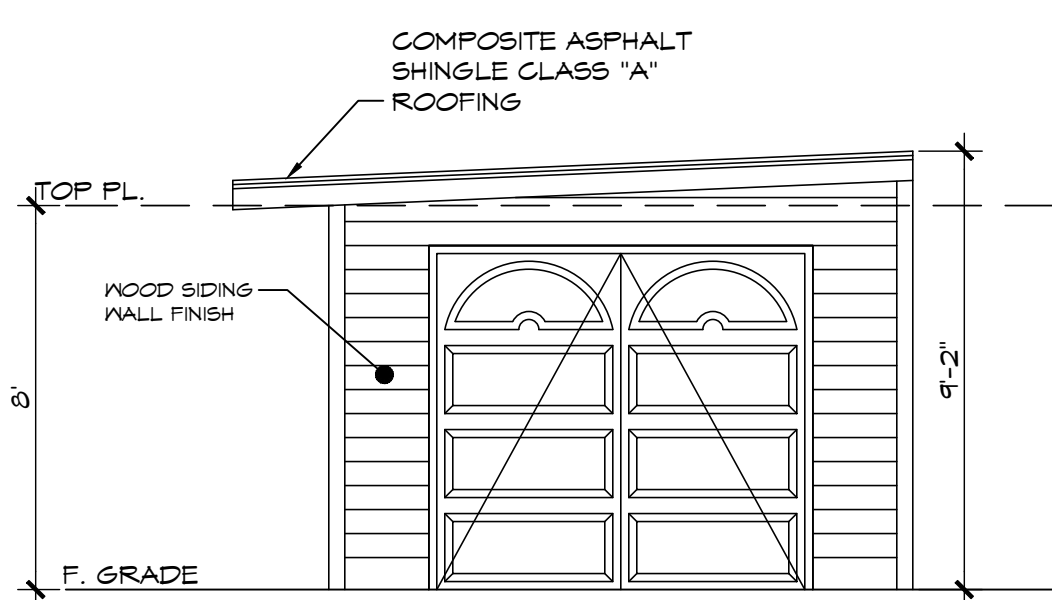



EAST ELEVATION

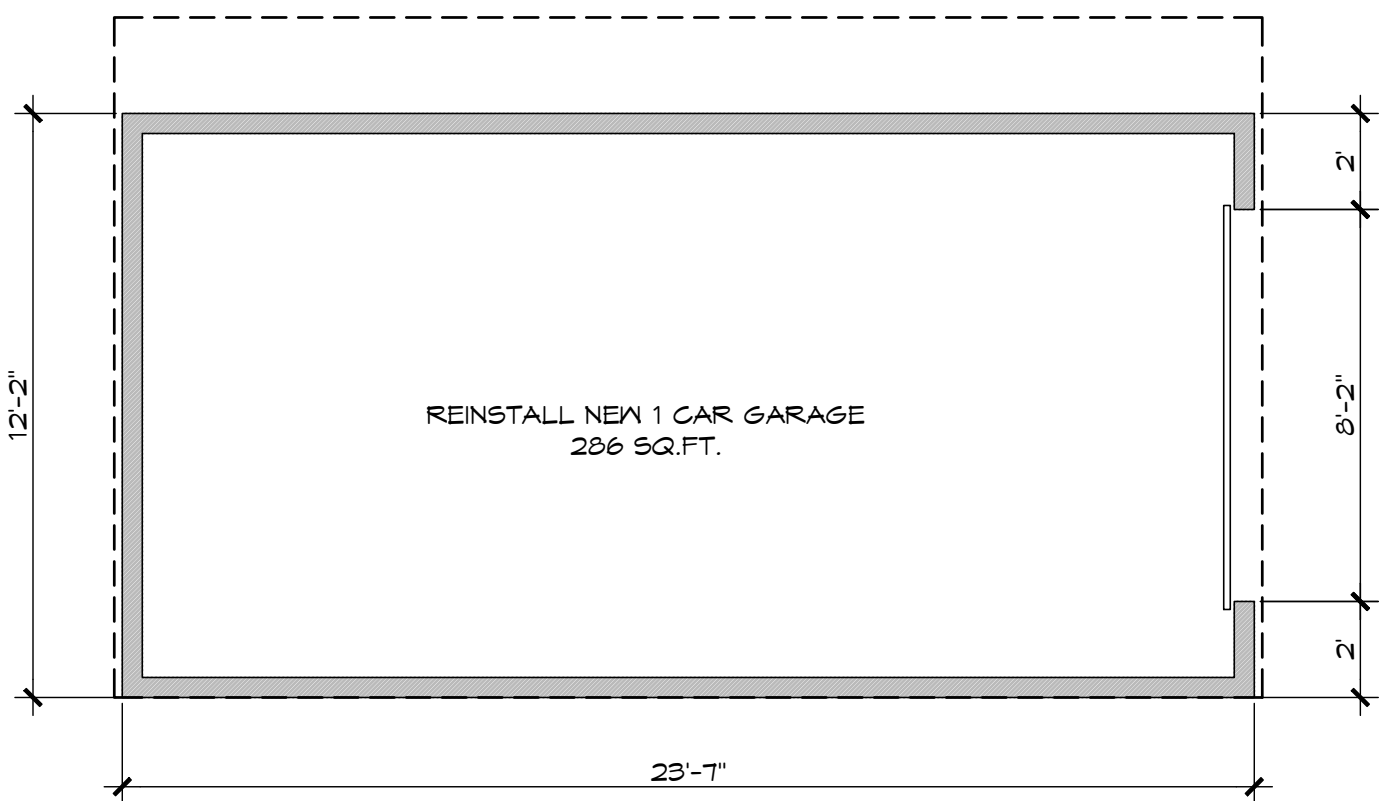

GARAGE FLOOR PLAN

LEGENDS:


NEW 2x WOOD STUDS WALL @ 16" O.C. TYP. W/
1/2" THICK DRYWALL INTERIOR AND WOOD
SIDING EXTERIOR

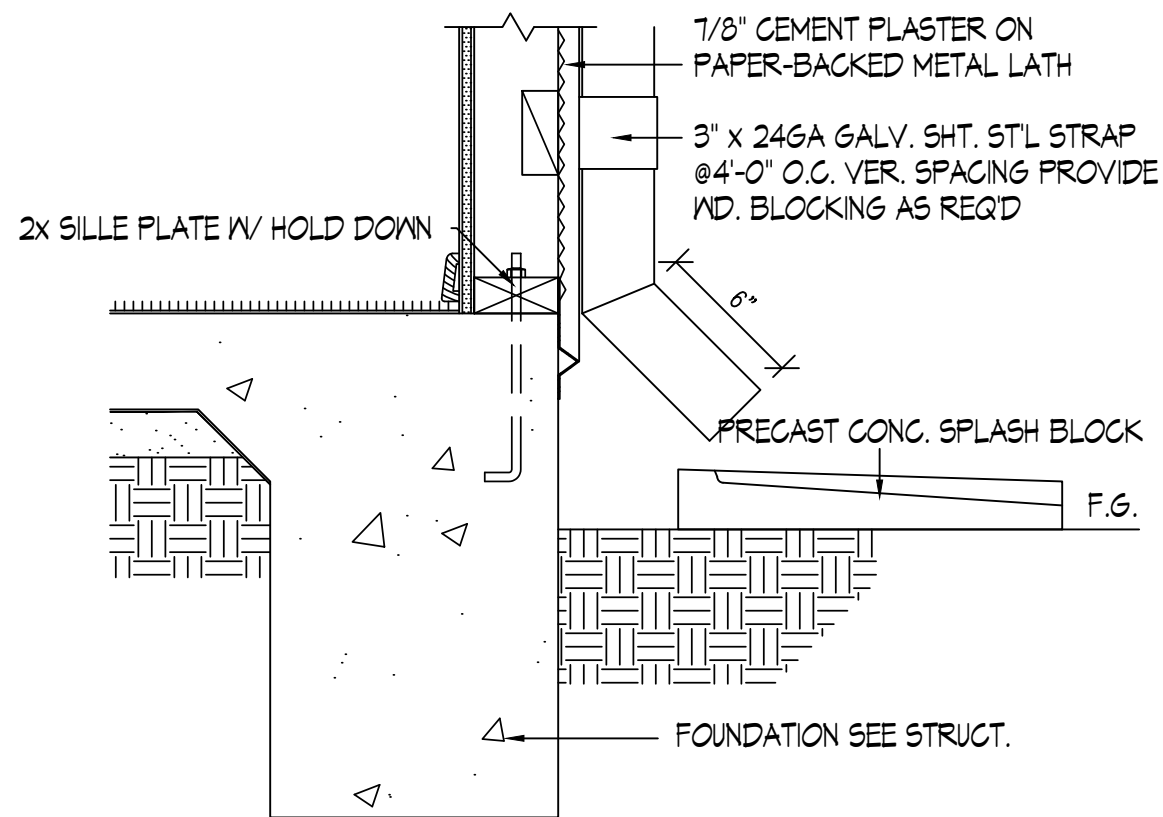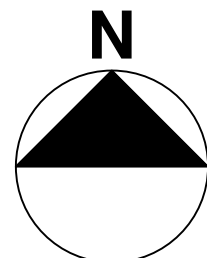

DOWNSPOUT/SPLASH BLOCK

SCALE: 1 1/2" = 1'-0"
FILE:

8

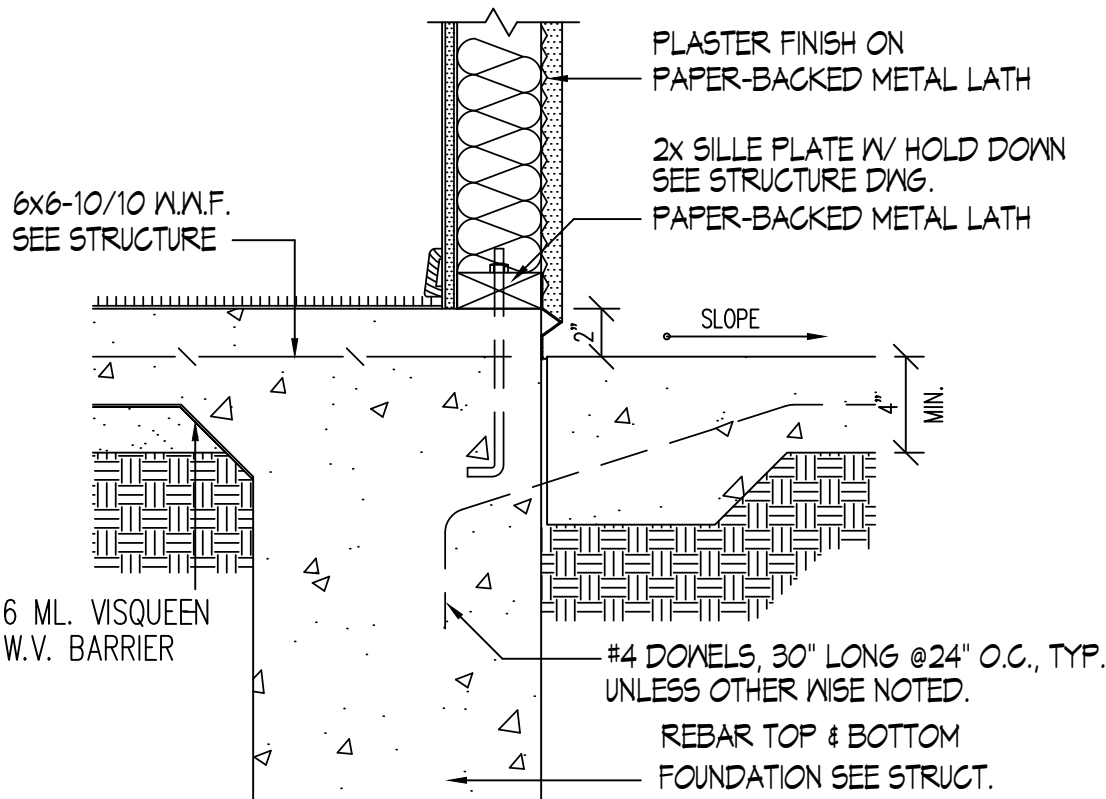

PORCH & SLAB CONNECTION

SCALE: 1 1/2" = 1'-0"
FILE:

7

1 CAR GARAGE FLOOR PLAN & ELEVATION

SCALE: 1/4" = 1'-0"
FILE:

1

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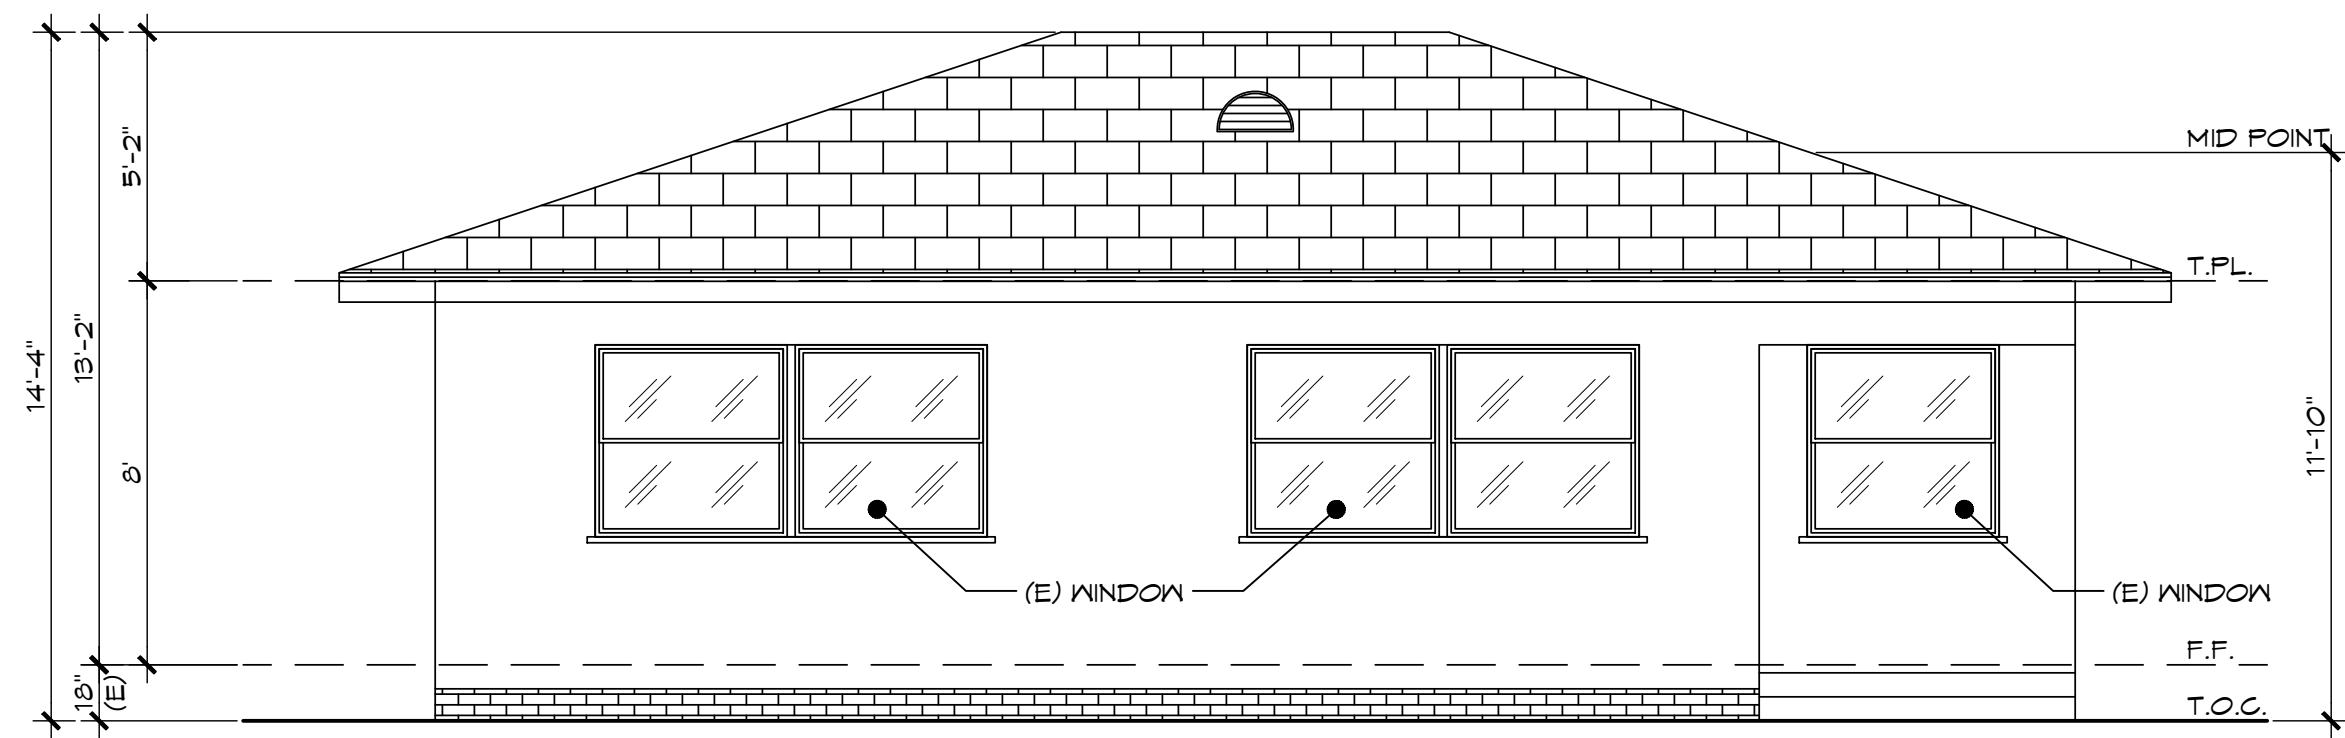
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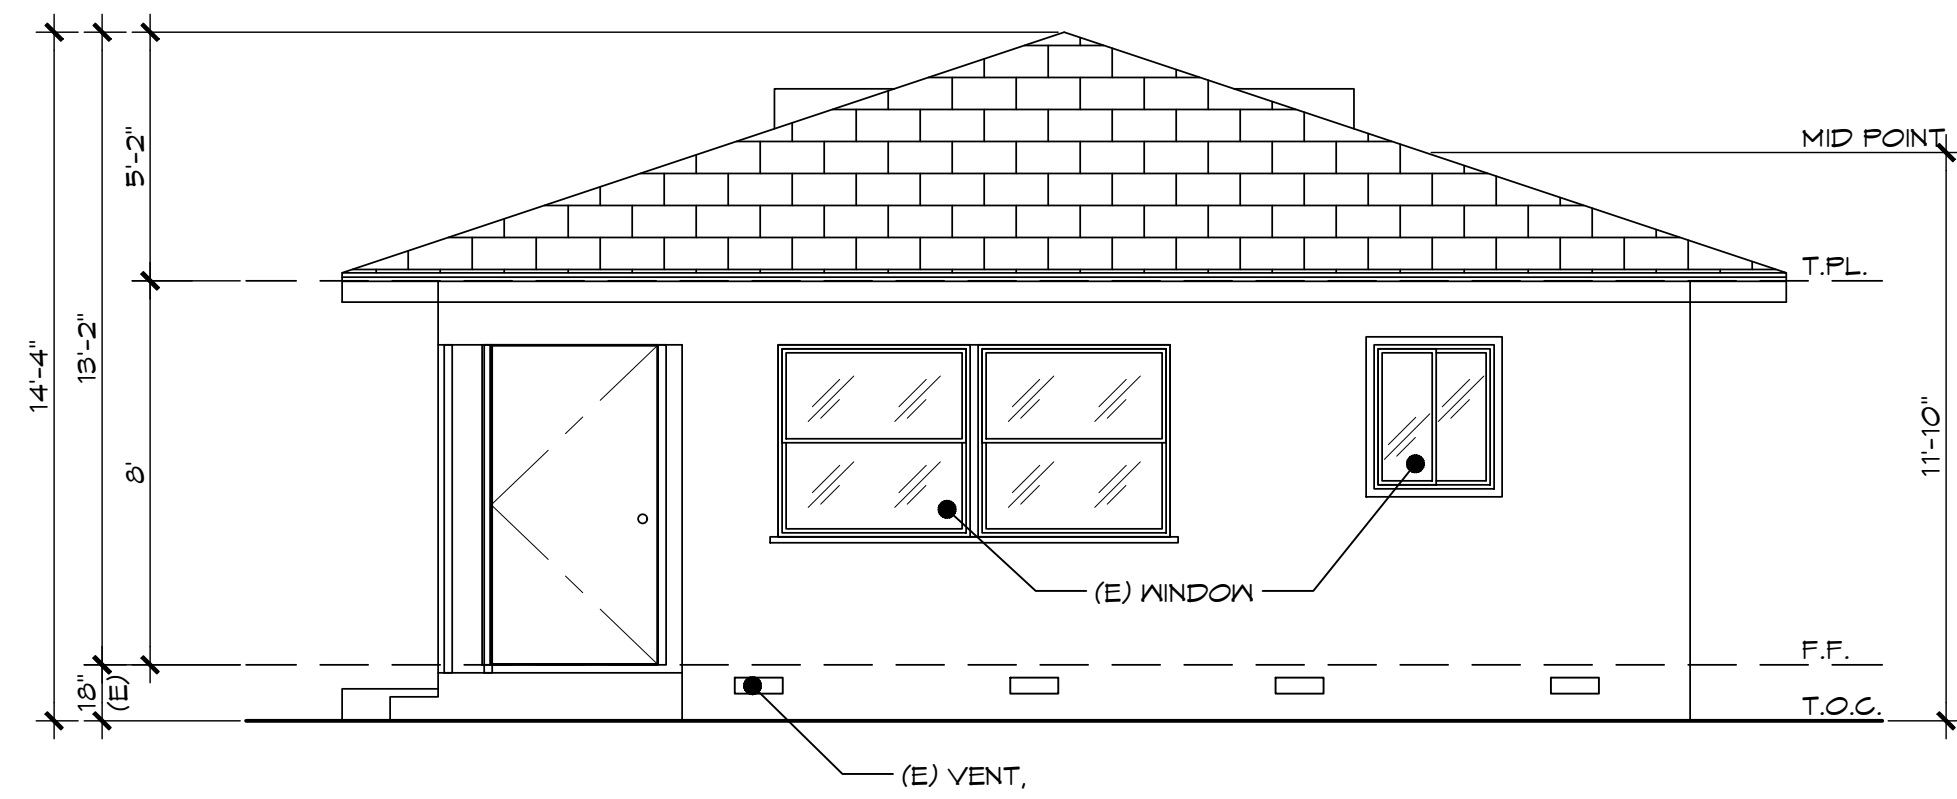
**EXISTING MAIN HOUSE
FLOOR PLAN &
ELEVATIONS**

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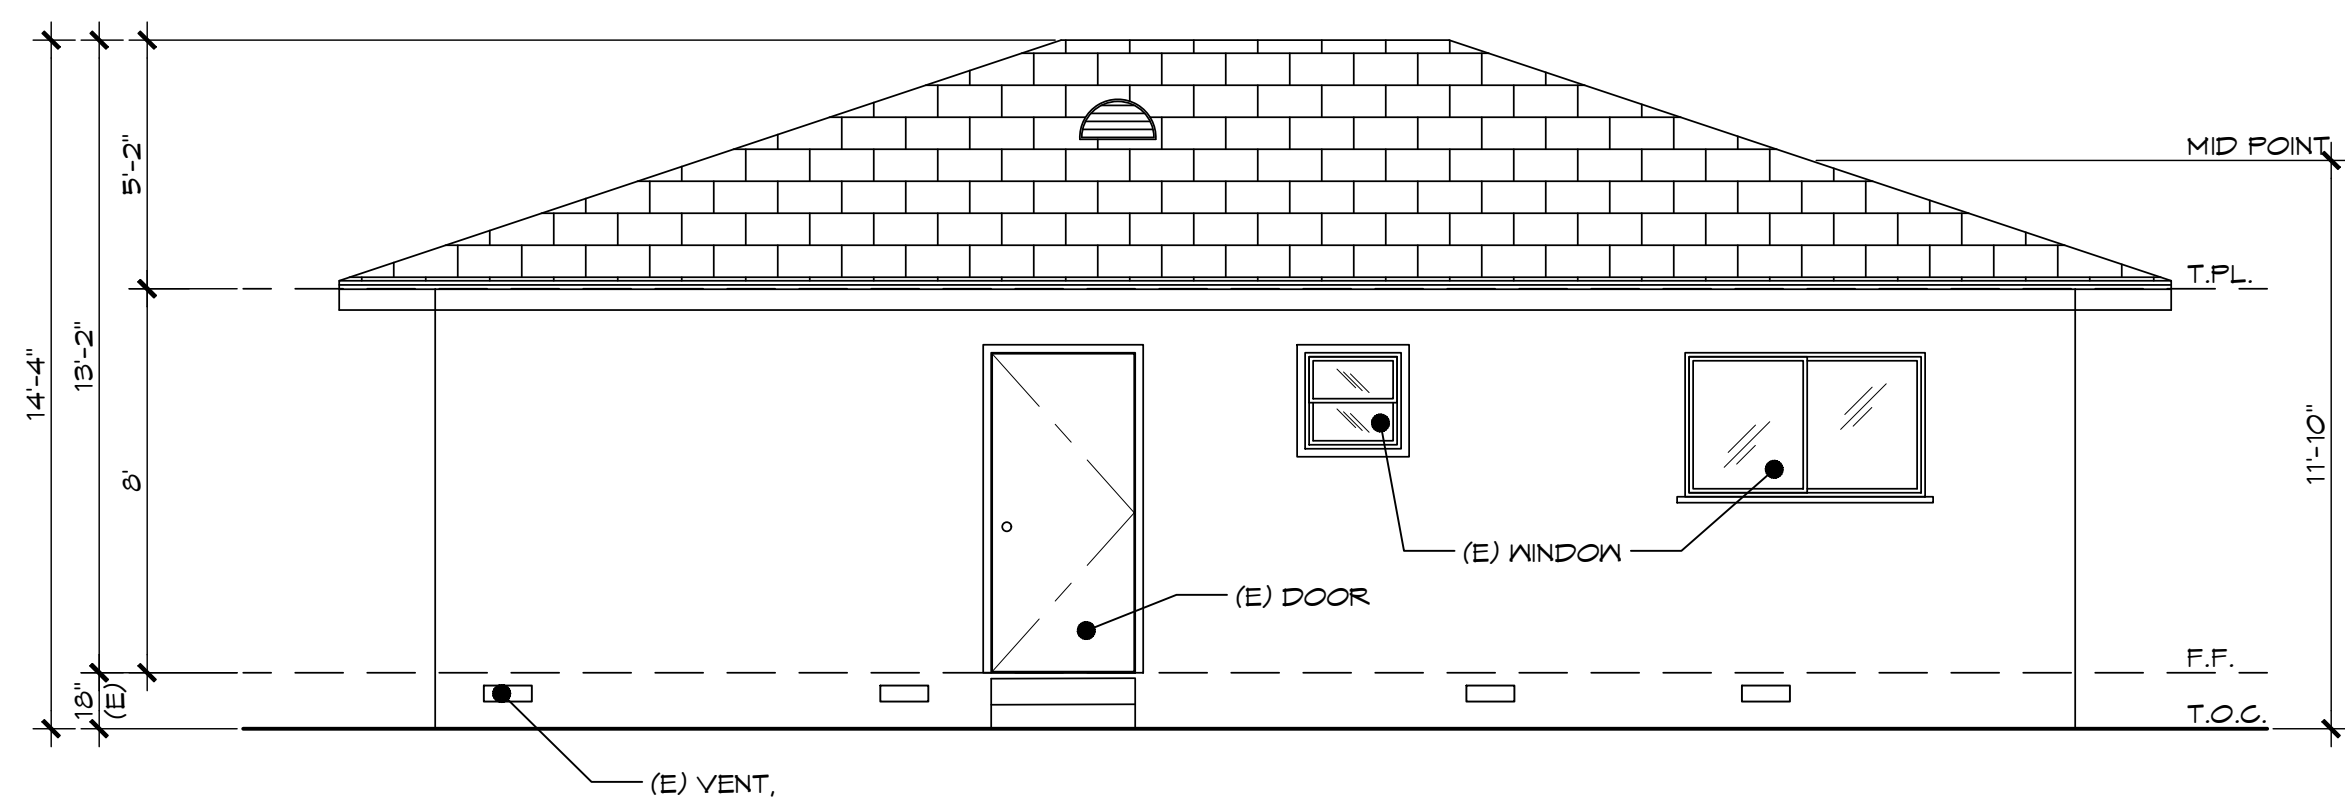
A2.2




WEST ELEVATION




NORTH ELEVATION




EAST ELEVATION

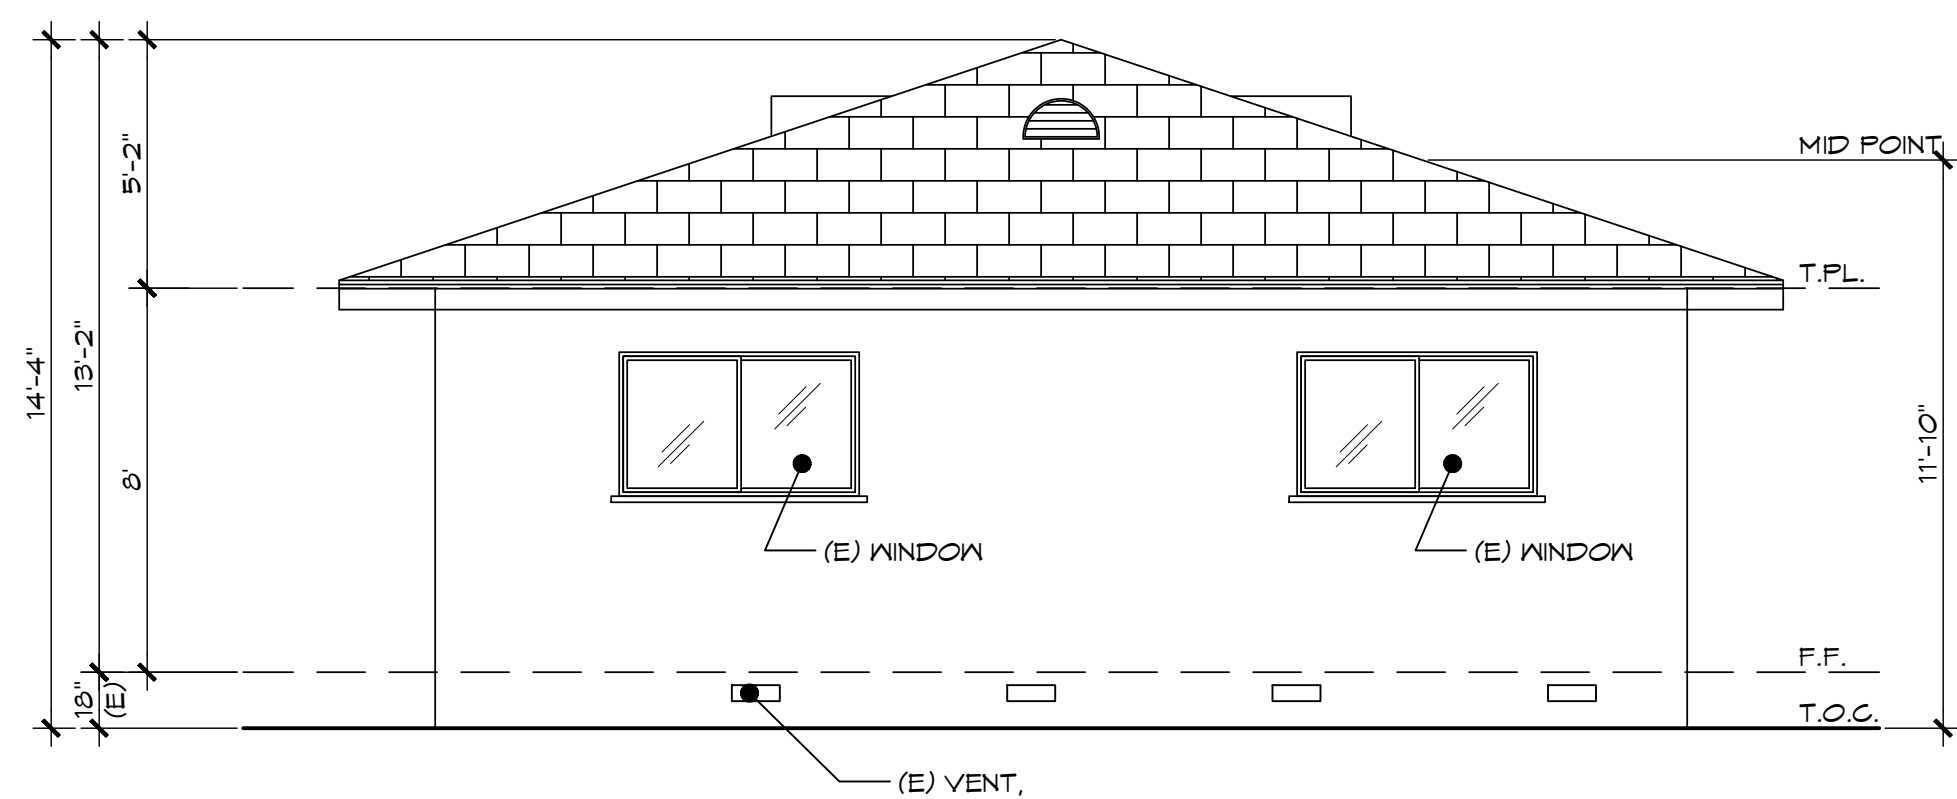

SOUTH ELEVATION

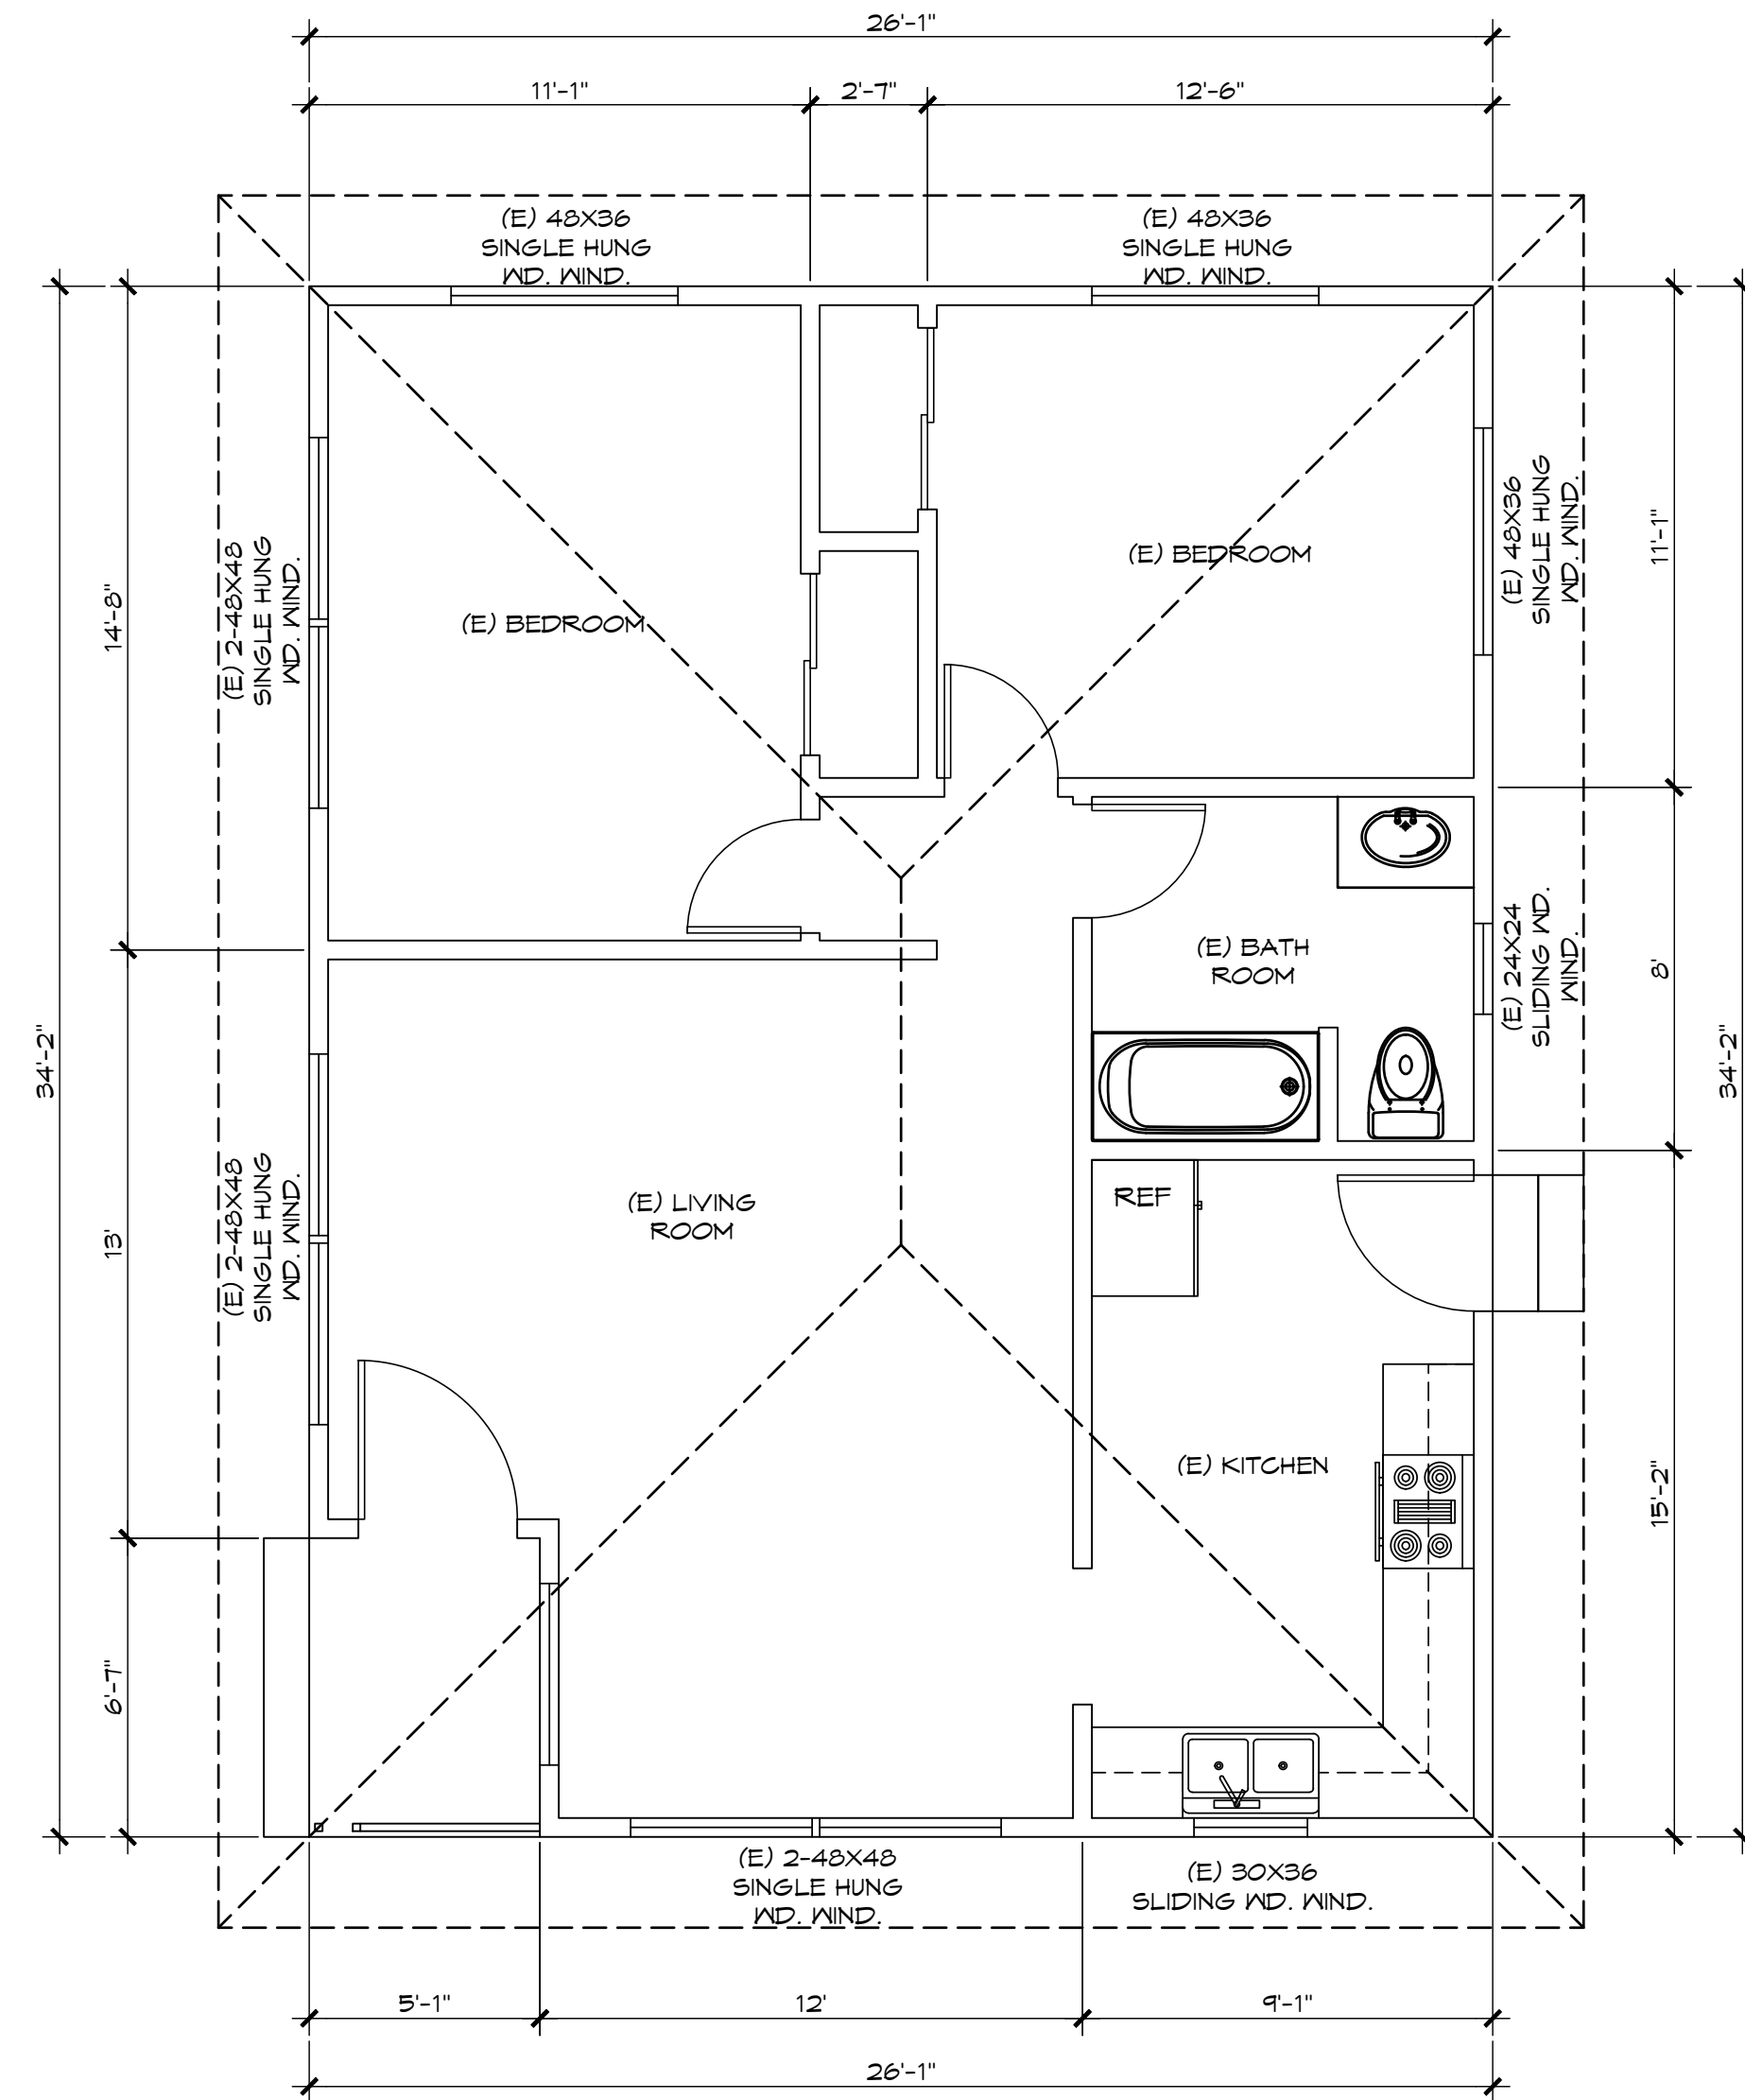

EXISTING FLOOR PLAN OF MAIN HOUSE

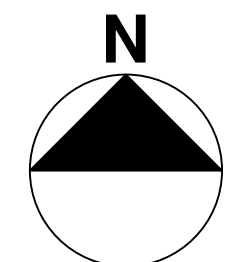

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EXTERIOR ELEVATIONS

DATE: 2.5.2020
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SHEET:

A3.0

VARIES
SEE SCHED.

2'

4'

2'-3"

TYPE-A
DOUBLE HUNG WINDOWS

2'

4'-5"

TYPE-B
SLIDER WINDOWS

Door & Window Legend:

AL ALUMINUM
GL GLASS
HM HOLOM METAL
WD WOOD

Space-Heating: Automatic Setback Req'd.
Duct R-value: R-6.0
Alternative Glazing Maximum Under Package D With Ducts No Testing:
SHGC (Solar Heat Gain Coeff.) = 0.31
U-Factor (conductivity) = 0.35
Gas Water Heater Energy Factor = 0.55 Min or R-12 Ext Blanket
Note: High Efficiency Lamp Luminaires shall be applied to all general lighting in up to 50% or more of the kitchen wattage, and except closets less than 10 feet or a dimmer switch or a manual-on controlled motion sensor to be installed.

SYM.	TYPE	SIZE (WxH)	FRAME	GLASS	HEAD HT.	REMARK
(W)	A	4'-0" X 4'-0"	WOOD	TEMP.	6'-10" A.F.F.	DINING ROOM
(W)	A	4'-0" X 4'-0"	WOOD	TEMP.	6'-10" A.F.F.	DINING ROOM
(W)	A	4'-0" X 4'-0"	WOOD	TEMP.	6'-10" A.F.F.	LIVING ROOM
(W)	A	4'-0" X 4'-0"	WOOD	TEMP.	6'-10" A.F.F.	LIVING ROOM
(W)	A	4'-0" X 4'-0"	WOOD	TEMP.	6'-10" A.F.F.	LIVING ROOM
(W)	A	4'-0" X 4'-0"	WOOD	TEMP.	6'-10" A.F.F.	LIVING ROOM
(W)	B	2'-0" X 2'-0"	WOOD	TEMP.	6'-10" A.F.F.	BATHROOM #3
(W)	A	4'-0" X 4'-0"	WOOD	TEMP.	6'-10" A.F.F.	BEDROOM #3
(W)	A	4'-0" X 4'-0"	WOOD	TEMP.	6'-10" A.F.F.	BEDROOM #2
(W)	A	4'-0" X 4'-0"	WOOD	TEMP.	6'-10" A.F.F.	BEDROOM #1
(W)	B	2'-0" X 2'-0"	WOOD	TEMP.	6'-10" A.F.F.	BATHROOM #2
(K)	A	3'-6" X 4'-0"	WOOD	TEMP.	6'-10" A.F.F.	KITCHEN
(W)	A	4'-0" X 4'-0"	WOOD	TEMP.	6'-10" A.F.F.	LIVING ROOM

18" HAFT ROUND DOWER ROOF VENT
w/ INSECT SCREEN. PAINT TO MATCH
ROOF COLOR

EXISTING COMPOSITE ASPHALT SHINGLE
CLASS "A" ROOFING

MID POINT

TOP FL.

TOP OF WINDOW

6'-8"

11'-6"

F. FLOOR

F. GRADE

18" MIN

SCALE: 1/4" = 1'-0"

9

SECTION A

SCALE: 1/4" = 1'-0"

3

EXISTING COMPOSITE ASPHALT
SHINGLE CLASS "A" ROOFING

MID POINT

TOP FL.

TOP OF WINDOW

6'-8"

11'-6"

F. FLOOR

T. CONC.

2'-9"

SEE PLAN

1'

SEE PLAN

NEW WOOD SIDING TO MATCH
EXISTING, PAINT WHITE

TEMP.

(W)

EAST ELEVATION

EXISTING COMPOSITE ASPHALT
SHINGLE CLASS "A" ROOFING

MID POINT

TOP FL.

TOP OF WINDOW

6'-8"

11'-6"

F. FLOOR

T. CONC.

EXISTING STUCCO
WALL TO REMAIN

TEMP.

(W)

WEST ELEVATION

COMPOSITE ASPHALT SHINGLE CLASS "A"
ROOFING (COLOR & TEXTURE TO MATCH
EXISTING)

18" HAFT ROUND DOWER
ROOF VENT w/ INSECT
SCREEN. PAINT TO MATCH
ROOF COLOR

COMPOSITE ASPHALT SHINGLE CLASS "A"
ROOFING (COLOR & TEXTURE TO MATCH
EXISTING)

18" HAFT ROUND DOWER
ROOF VENT w/ INSECT
SCREEN. PAINT TO MATCH
ROOF COLOR

COMPOSITE ASPHALT SHINGLE CLASS "A"
ROOFING (COLOR & TEXTURE TO MATCH
EXISTING)

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