# Exhibit B

CODES:

BUILDING: 2016 CALIFORNIA BUILDING CODE - TITLE 24, PART 2
RESIDENTIAL: 2016 CALIFORNIA RESIDENTIAL CODE - TITLE 24, PART 2.5
ELECTRICAL: 2016 CALIFORNIA ELECTRICAL CODE - TITLE 24, PART 3
MECHANICAL: 2016 CALIFORNIA MECHANICAL CODE - TITLE 24, PART 4
PLUMBING: 2016 CALIFORNIA PLUMBING CODE - TITLE 24, PART 5
ENERGY: 2016 CALIFORNIA ENERGY CODE - TITLE 24, PART 6
FIRE: 2016 CALIFORNIA FIRE CODE - TITLE 24
GREEN BUILDING: 2016 CALIFORNIA GREEN BUILDING STANDARDS CODE

4,800.00 SQ. FT.

TITLE 24, PART II

PROJECT SUMMARY
GROSS LOT AREA
(E) RESIDENCE

 (E) RESIDENCE
 1,809.00
 SQ. FT.

 (N) ADDITION TO SECOND FLOOR
 + 19.00
 SQ. FT.

 (N) TOTAL LIVING AREA
 1,829.00
 SQ. FT.

(E) GARAGE 636.00 SQ. FT.

OCCUPANCY:

ZONE:

CONSTRUCTION TYPE:

FIRE SPRINLER:

R-3/U


R-3/U


V-B

NO

LOT COVERAGE:

ADDITION OF 19 SQ. FT. SHOWER TO THE SECOND FLOOR.

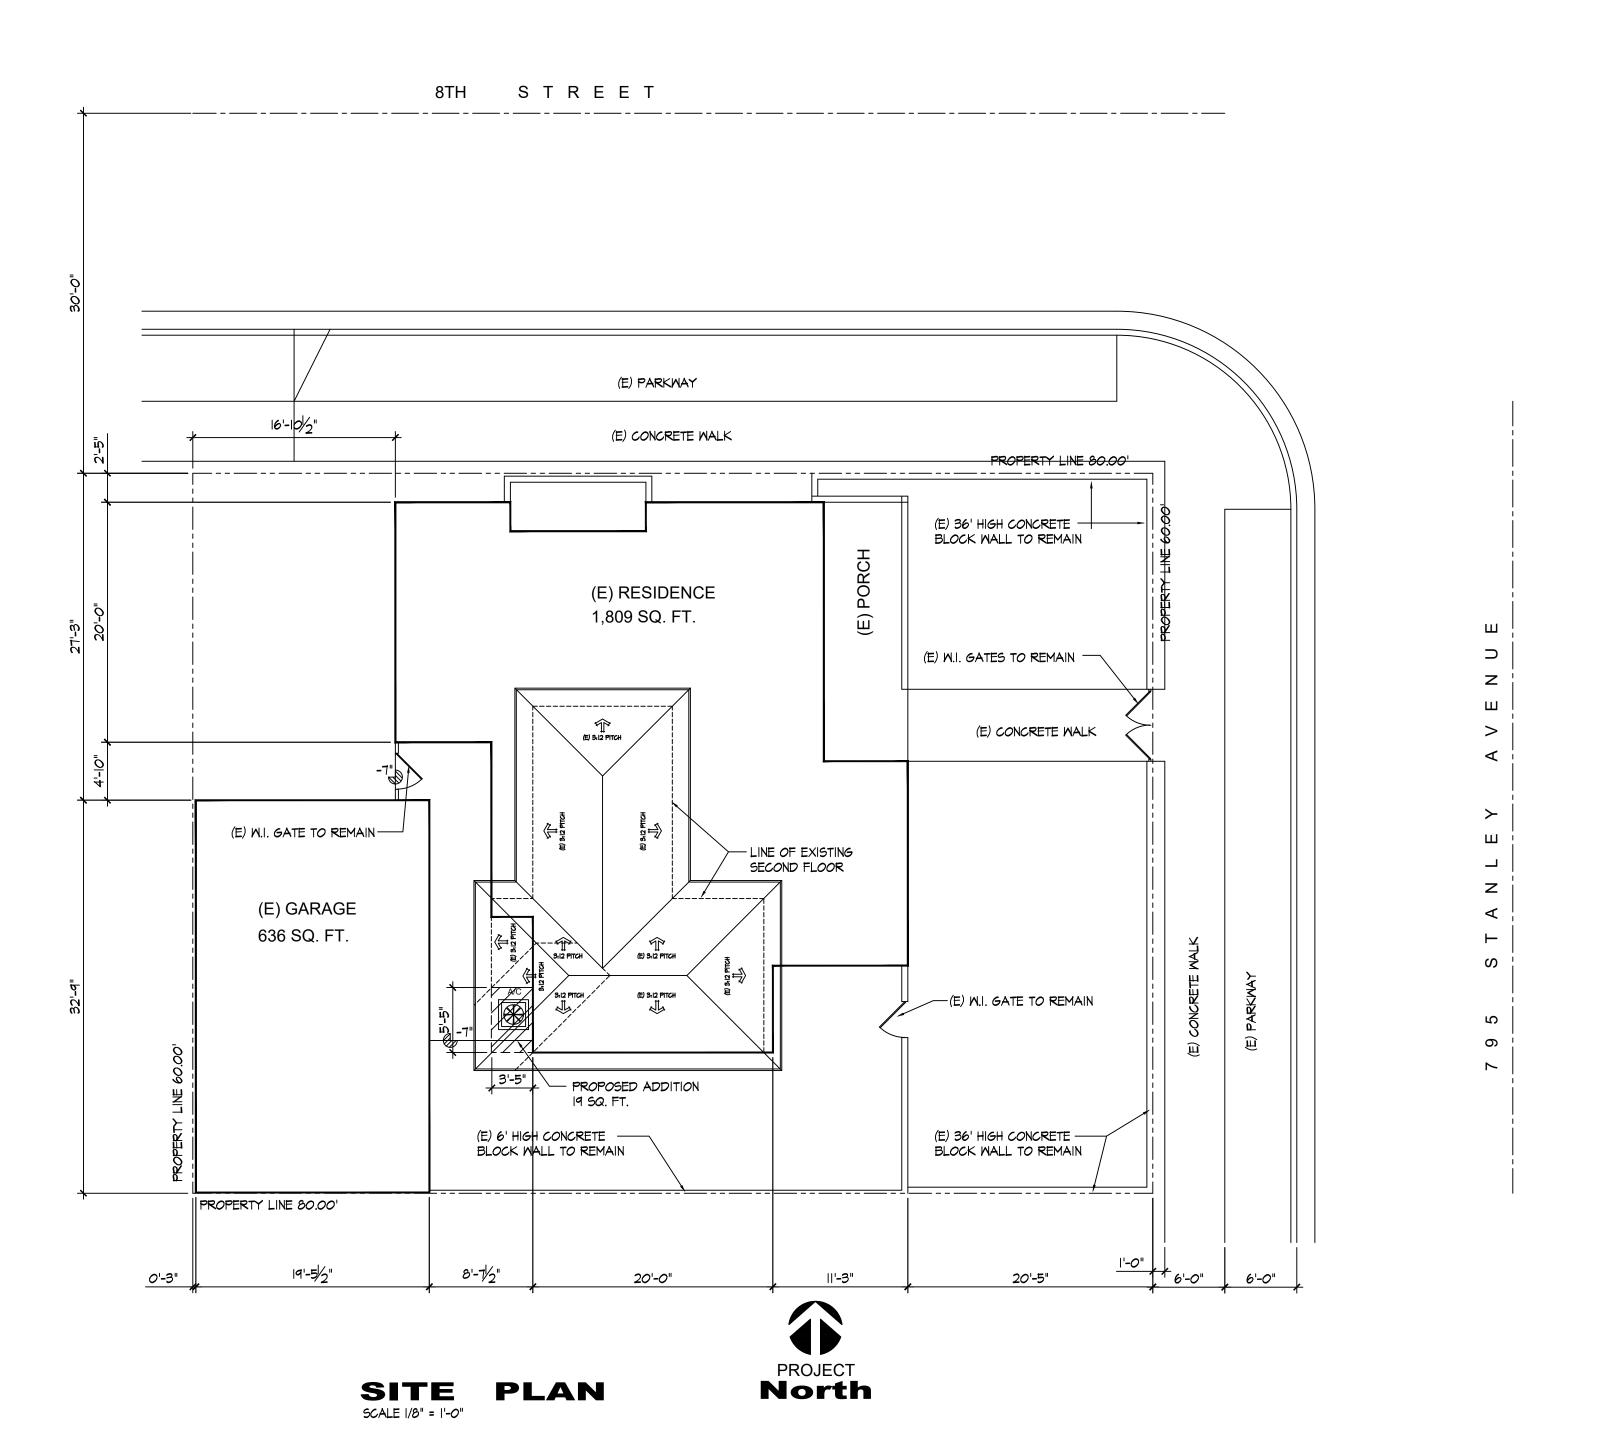

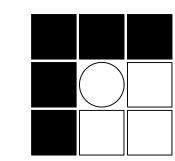



CONSULTANT :

OWNER INFORMATION :

Haj Residence

Mr. Ray Haj 705 Stanley Avenue Long Beach, Ca. 90804

PROJECT LOCATION:

795 Stanley Avenue

Long Beach, Ca. 90804

ISSUE / DATE:

REVISION :

REVISION:

The above drawings and specifications and ideas, designs and arrangements represented thereby are and shall remain the property of the designer, and no part thereof shall be copied, disclosed to others or used in connection with any work or project other than the specified project for which they have been prepared and developed without the written concent of the designer. Visual contact with these plans or specifications shall constitute conclusive evidence of acceptance of these restrictions.


Written dimensions on these drawings shall have precedence over scaled dimensions. Contractor shall verify and be responsible for all dimensions and conditions on the job and this office must be notified of any variations from the dimensions and conditions shown by these drawings. Shop details must be submitted to this office for approval before proceeding with fabrication.


project no: 1901003
phase: Cd's
date:


scale: 1/8" = 1-0" drawn by:

SHEET TITLE:

SHEET NO. :

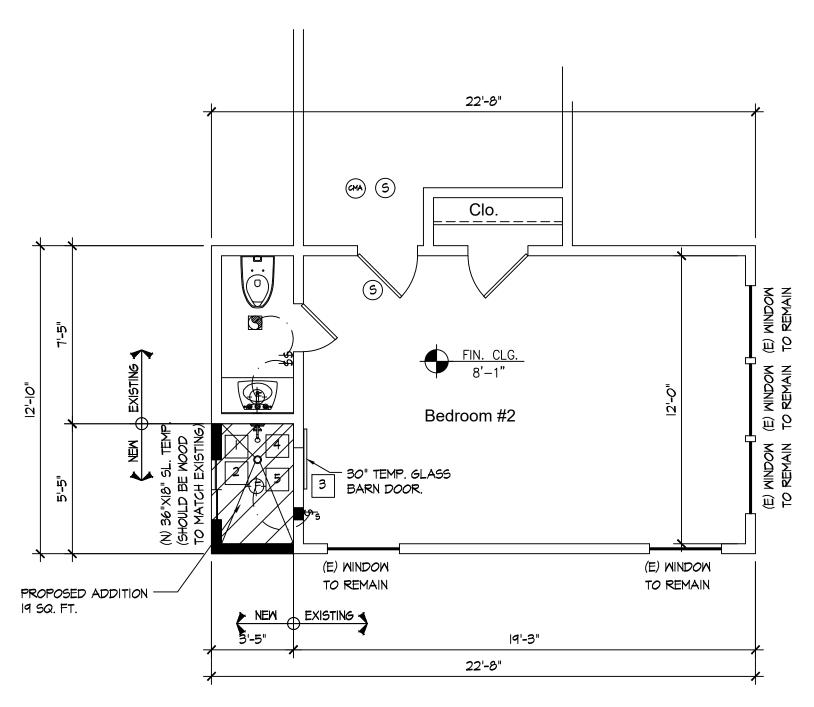

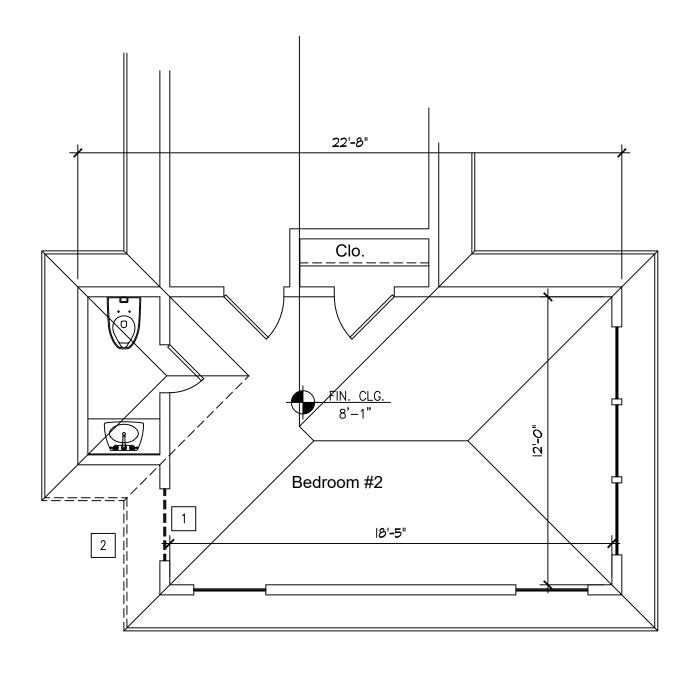

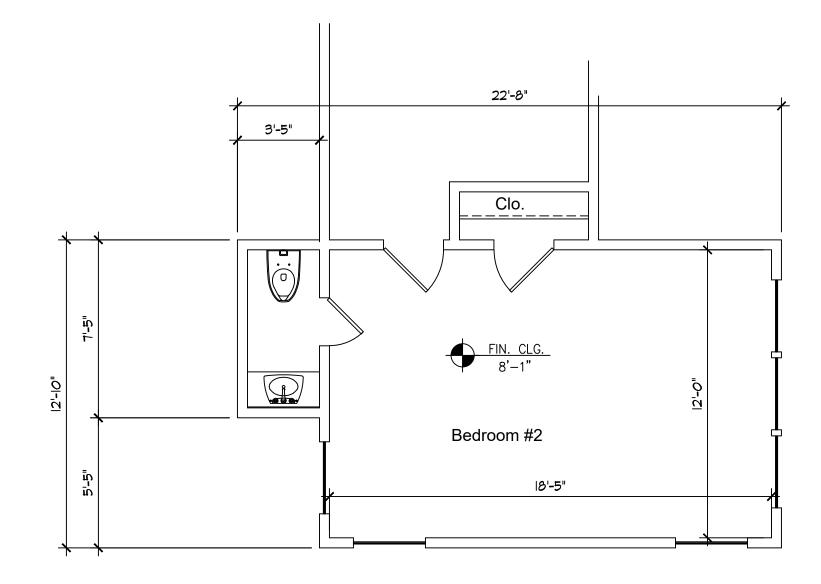

#### (N) SECOND FLOOR PLAN SCALE 1/4" = 1'-0"

## (E) SECOND FLOOR / ROOF PLAN

FLOOR NOTES:

RIGID FIT CONNECTION.

36" X 60" SHOWER, INSTALL PER MFG. SPECS

SAFETY GLASS (TEMP.) ENCLOSURE WITH METAL FRAME. CRC R308.

FAUCETS IN KITCHENS, WET BARS, LAVATORIES, LAUNDRY SINKS, ECT. SHALL BE 1.8 GALLONS PER MINUTE.

SHOMER HEADS SHALL BE DESIGN AND INSTALLED SO THAT THEY WILL NOT EXCEED A WATER SUPPLY FLOW RATE OF 2.0 GALLON PER MINUTE MEASURED AT 80 psi. CPC 402.1.1 " ALL SHOWER AND TUB-SHOWERS SHALL HAVE A PRESSURE BALANCE, THERMOSTATIC MIXING VALVE, OR A COMBUSTION PRESSURE BALANCE/ THERMOSTATIC MIXING TYPE VALVE." CPC 418.0.

WATER CLOSETS, EITHER FLUSH TANK, FLUSHOMETER TANK, OR FLUSHOMETER VALVE OPERATED, SHALL HAVE AN AVERAGE CONSUMPTION OF MAXIMUM OF 1.28 GALLONS (6.1 LITERS) OF WATER PER FLUSH. CPC 402.2.

#### **ELECTRICAL SYMBOLS**

CEILING LIGHT FIXTURE. HIGH EFFICACY OR SENSOR. CEC 410.8

WALL HUNG FIXTURE. HIGH EFFICACY OR SENSOR.

ELECTRIC EXHAUST FAN CAPABLE OF PROVIDING 50 CFM BATHROOM WITH HUMIDITY CONTRL. 100 CFM IN KITCHENS AND 50 CFM IN LAUNDRY / UTILITY ROOMS. EXHAUST VENTS SHALL BE SEPERATELY SWITCHED FROM THE LIGHTING. (ENERGY STAR)

AFCI ALL NEW RECEPTACLES SHALL BE TAMPERPROOF 2016 CEC 406.11 ALL NEW 120 V-SINGLE PHASE, 15a-20a BRANCH CIRCUITS IN AREAS DEFINED BY 2016 CEC 210.12(B).

GFI DUPLEX OUTLET, 120 V-SINGLE PHASE, 15a-20a BRANCH CIRCUITS IN AREA OF KITCHEN (AFCI) GFI DUPLEX OUTLET, 2016 CEC 210.52(C).

SINGLE POLE SWITCH AT 48" HIGH. SENSOR SMITCH AT 48" HIGH.

IN THE INDIVIDUAL UNIT (CRC RI5.7).

HARDWIRE AND INTERCONNECTED ALL SMOKE ALARMS WHERE ACCESS IS AVAILABLE WITHOUT THE REMOVAL OF BUILDING FINISHES PER R314.4.

CARBON MONOXIDE ALARMS SHALL RECEIVE THEIR PRIMARY POWER FROM THE BUILDING WIRING WHERE SUCH WIRING IS SERVED FROM A COMMERCIAL SOURCE AND, WHERE PRIMARY POWER IS INTERRUPTED, SHALL RECEIVE POWER FROM A BATTERY.

WHERE MORE THAN ONE CARBON MONOXIDE ALARM IS REQUIRED TO BE INSTALLED WITHIN A DWELLING UNIT OR WITHIN A SLEEPING UNIT IN GROUP R OCCUPANCIES, THE ALARMS SHALL BE INTERCONNECTED IN A MANNER THAT ACTIVATION OF ONE ALARM SHALL ACTIVATE ALL OF THE ALARMS

### **DEMOLITION NOTES**

#### A. GENERAL

(E) SECOND FLOOR / ROOF / DEMO PLAN

1. By careful study of the Contract Documents, determine the location of extent of selective demolition to be performed. In company with the Owner, visit the site and verify the extent and location of selective demolition requiréd.

\* Carefully identify limits of selective demolition. \* Mark interface surfaces as required to enable required men also to identify items to be removed and items to be left in placé intact.

\* Prepare and follow an organized plan for demolition and removal of items.

2. General work shall not proceed until all protective work is placed as required to protect the buildings activities, properties, and personnel from the hazards of the work. Noise, dust, etc., shall be kept to a minimum, by careful handling, dampening, etc., as

3. Existing work damaged in the prosecution of the work shall be repaired or restored to it's original condition at the Contractor's expense. of such work.

Demolition shall be done only by experienced workers using appropriate tools and equipment and provided with all necessary safeguards.

5. Wherever the removal of any existing finished surface is required by the drawings and/or specifications, the contractor shall make due allowance

for finishing all unfinished surfaces exposed as a result 6. All materials removed under this contract which are not to be salvaged or reused shall become the property of the contractor and be promptly removed from the site. At all times use movable debris boxes, covered, to convey the material through the building. Do not store or permit debris to accumulate on the site.

7. Extreme care shall be exercised to prevent chipping, breakage, bending, and mishandling of all materials.

8. Upon completion of demolition work, leave the property and adjacent areas clean and satisfactory to the Designer and Owner.

B. MECHANICAL AND ELECTRICAL

1. Carefully review drawings, and determine lines to be removed and those to be kept active or to be reactivated. Protect lines to remain. Provide for minimum service interruption of lines to remain.

2. Remove fixtures and equipment as indicated. When indicated for reuse, clean, store as directed, and protect. Identify point of reuse. See mechanical drawings for additional information on demolition required for H.V.A.C.. and plumbing work.

3. Remove lines completely wherever possible. Cut and cap, or plug in a positive manner, behind the back


4. Contractor shall maintain and/or reconnect continuity for all HVAC, Plumbing, Electrical and Gas utility services that serve other rooms or areas.

5. Patch and repair all floor penetrations from existing Plumbing, Electrical and Mechanical utilities being demolished.

NOTES

1 (E) WINDOW TO BE REMOVED

2 (E) EAVE TO BE REMOVED

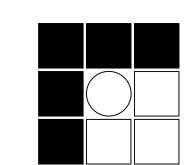



adstudiodowney@gmail.com

CONSULTANT

OWNER INFORMATION

Haj Residence

Mr. Ray Haj 705 Stanley Avenue Long Beach, Ca. 90804

PROJECT LOCATION:

795 Stanley Avenue

100 Otariloy / Worldo				
Long Beach, Ca. 9080				

ISSUE / DATE:

REVISION:

The above drawings and specifications and ideas, designs and arrangements represented thereby are and shall remain the property of the

designer, and no part thereof shall be copied, disclosed to others or used in connection with any work or project other than the specified project for which they have been prepared and developed without the written concent of the designer. Visual contact with these plans or specifications shall constitute conclusive evidence of acceptance of these restrictions. Written dimensions on these drawings shall have precedence over scaled dimensions. Contractor shall verify and be responsible for all dimensions and conditions on the job and this office must be notified of any variations from the dimensions and conditions shown by these drawings. Shop details must be submitted to this office for approval before proceeding with fabrication.


project no: phase: Cd's

date: scale: 1/4" = 1-0" drawn by:

SHEET TITLE :


(E) Floor Plan (E) Floor / Demo Plan


SHEET NO.

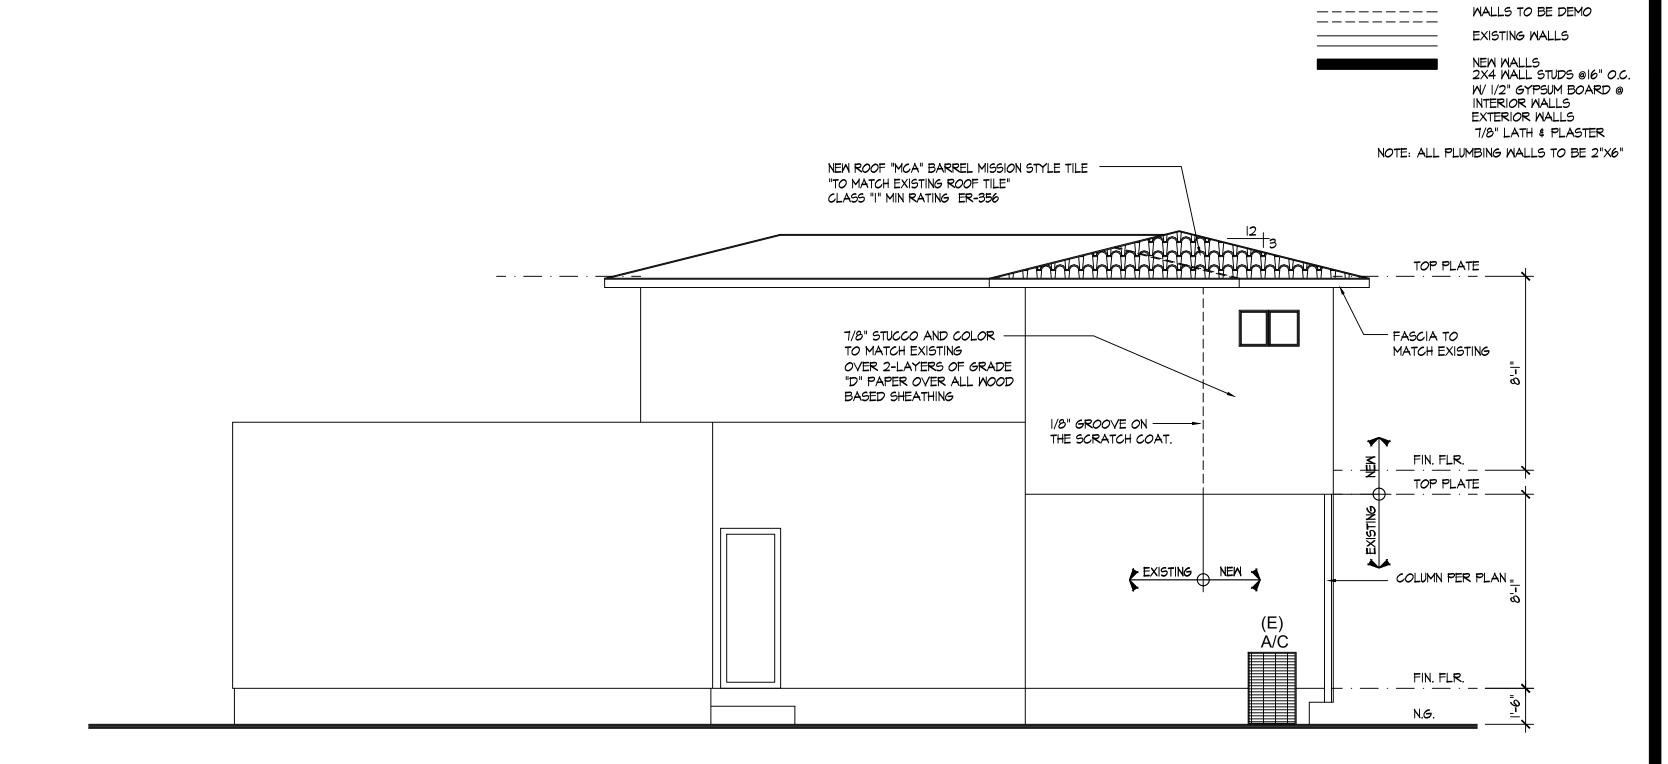

## WEST ELEVATION

SCALE 1/4" = 1'-0"

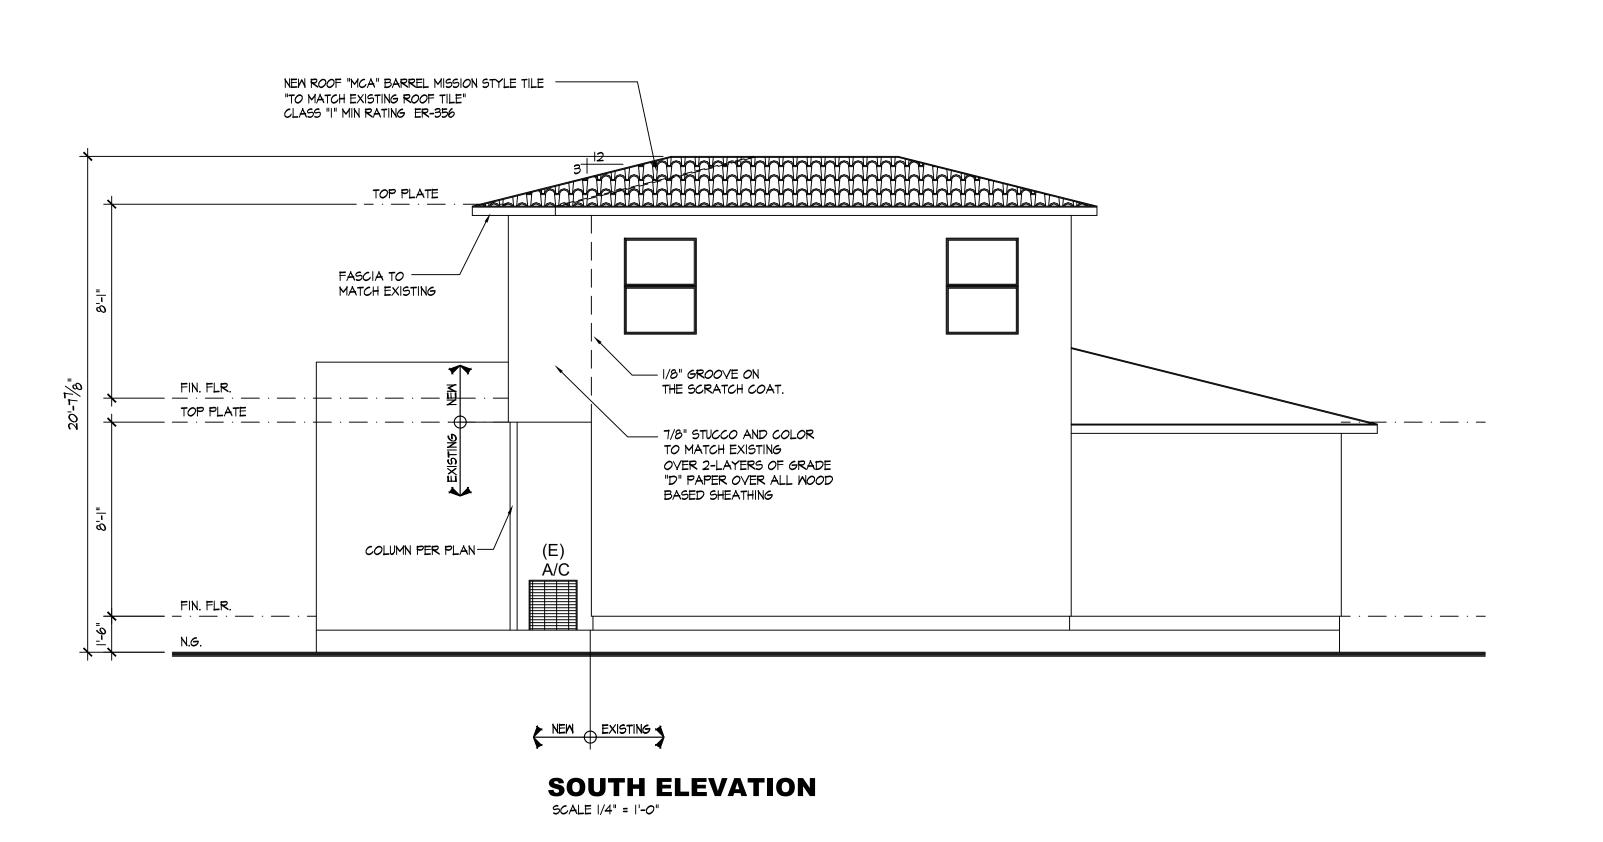

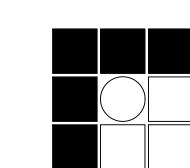

WALL LEGEND



CONSULTANT:

OWNER INFORMATION :

Haj Residence

Mr. Ray Haj 705 Stanley Avenue Long Beach, Ca. 90804

PROJECT LOCATION:

. 795 Stanley Avenue Long Beach, Ca. 90804

ISSUE / DATE:

REVISION :

The above drawings and specifications and ideas, designs and arrangements represented thereby are and shall remain the property of the designer, and no part thereof shall be copied, disclosed to others or used in connection with any work or project other than the specified project for which they have been prepared and developed without the written concent of the designer. Visual contact with these plans or specifications shall constitute conclusive evidence of acceptance of these restrictions.


Written dimensions on these drawings shall have precedence over scaled dimensions. Contractor shall verify and be responsible for all dimensions and conditions on the job and this office must be notified of any variations from the dimensions and conditions shown by these drawings. Shop details must be submitted to this office for approval before proceeding with fabrication.

project no: 1901003 phase: Cd's

SHEET TITLE:

A

SHEET NO. :

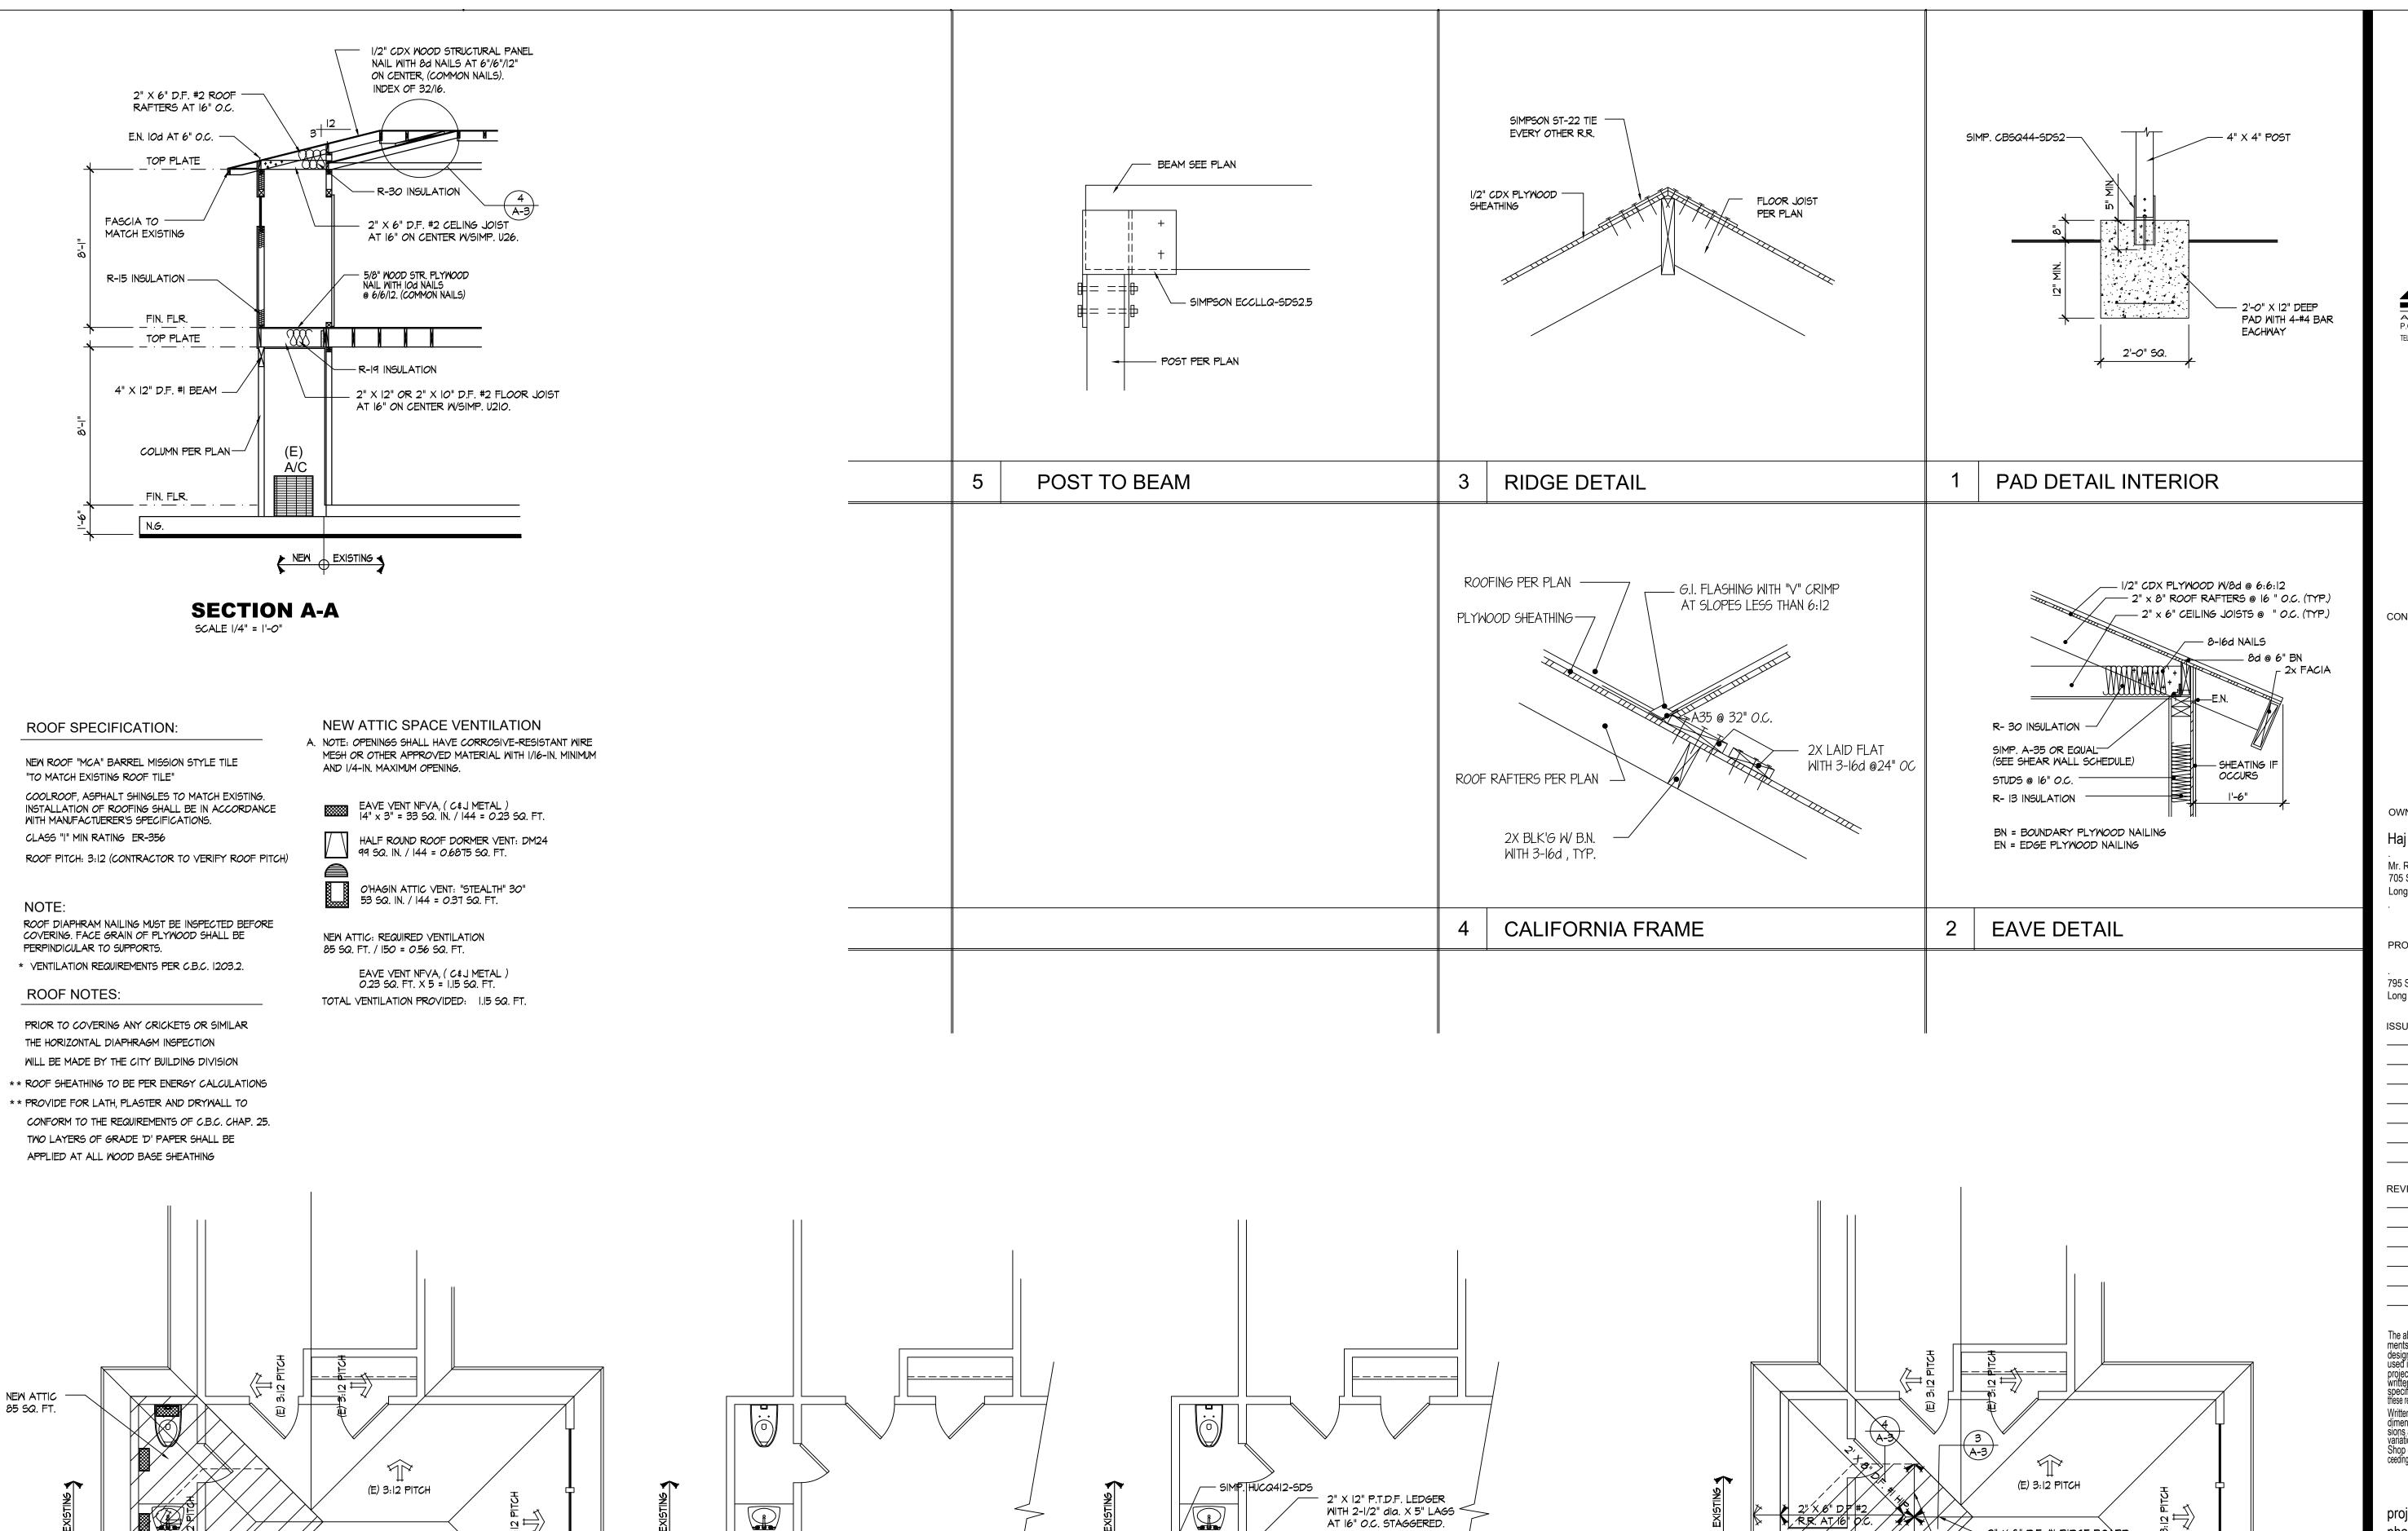

(N) 2" X 12" OR 2" X 10" FLOOR

**SECOND FLOOR FRAMING PLAN** 

(N) 2" X 6" D.F. #2 ——

CEILING JOIST AT 16" O.C. 2

JOIST AT 16" O.C.

SIMP. HUCQ412-SDS

/4" X |2"/D.F. #| BEAM

SCALE 1/4" = 1'-0"

4" x 4" POST / SIMP. CC44

- 2'-0" SQ. X 12" DEEP

**FOUNDATION PLAN** 


SCALE 1/4" = 1'-0"

SIMP. CBSQ44-SDS2

WITH 4-#4 EACH WAY.

(E) 3:12 PITCH

(N) SECOND FLOOR ROOF PLAN SCALE 1/4" = 1'-0"

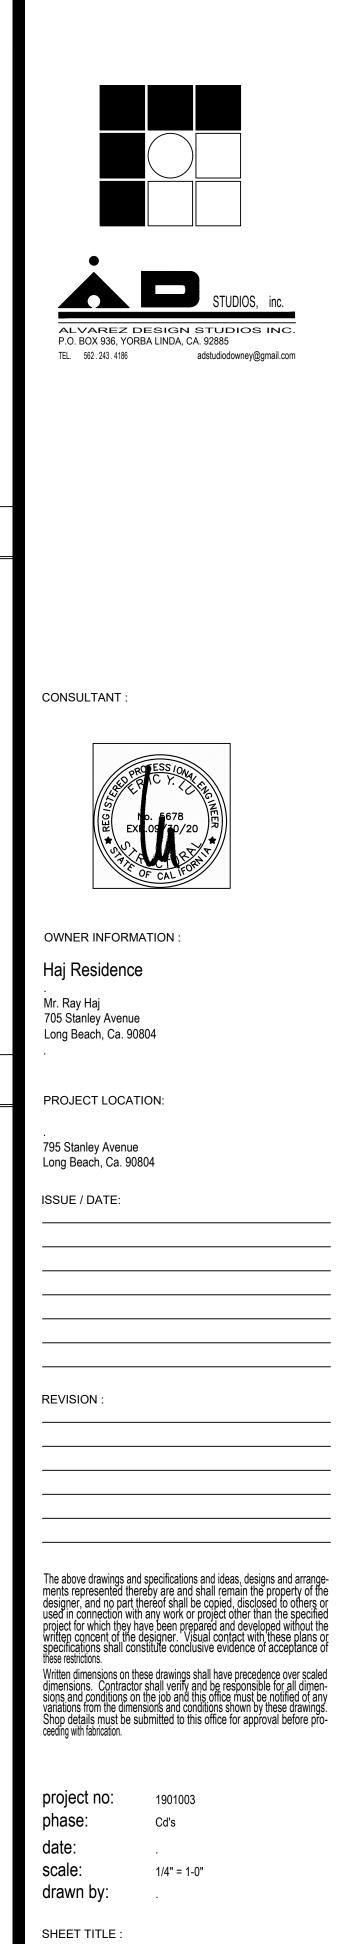

A-3

(E) Floor Plan

SHEET NO. :

(E) Floor / Demo Plan

2" X 6" D.F #2

CALIFORNIA FRAME

**FRAMING PLAN** 

SCALE 1/4" = 1'-0"

R.R. AT 16" O.C.

#### SITE PHOTOGRAPHS 795 Stanley Avenue Application No. COAC1904-01 June 10, 2019





Site Photographs Application No. COAC1904-01 June 10, 2019 Page 2 of 3





Site Photographs Application No. COAC1904-01 June 10, 2019 Page 3 of 3

