

UNDERGROUND SERVICE ALERT OF SOUTHERN CALIFORNIA 800-227-2600

48 HOURS BEFORE YOU DIG

T - Mobile

JS INFRASTRUCTURE AZ - CA - CO - ID - NM - NV - TX - UT

2030 MAIN STREET, SUITE 200 IRVINE, CA 92614

T-MOBILE WEST LLC

SITE NUMBER: LA33958B SITE NAME: EL DORADO MODEL AIRPLANE FIELD (SCE TOWER #:M3-T4 ALAMITOS-CENTER 220kV YEAR BUILT: 1955)

> N/O E. WARDLOW ROAD AND E/O STEVELY AVE. LONG BEACH, CA 90808

	NSB SCOPE (OF WORK	Κ:	VICINITY MAP				SHT	DRAW	ING INDEX	REV	SITE NUMBER:	
SCOPE OF WORK: INSTALLA INSTALL (1) 16'-0" x 16'-0" C	TION OF NEW TELECOMMUNICATION F	FACILITY CONSIST	ING OF THE FOLLOWING:		0 00 00				T01	TITLE SHEET	·	8	LA33958B
INSTALL (1) BBU CABINET C INSTALL (2) RBS 6102 CABIN	ON (1) (P) CONCRETE PAD	CONCRETE PAD				T02	GENERAL NOTES, ABBREVIATIONS & SYMBOLS		8	SITE NAME:			
 INSTALL (1) GPS ANTENNA 									LS-1	TOPOGRAPHIC SURV	Y (FINAL)	8	EL DORADO MODEL
INSTALL (1) H-FRAME INSTALL (1) TELCO CABINET									LS-2	TOPOGRAPHIC SURV	EY (FINAL)	8	AIRPLANE FIELD
 INSTALL (1) PPC w/GENPLU INSTALL (1) CABLE SHROUD)								A01	OVERALL SITE PLAN		8	
 INSTALL (6) RRUS, (2) PER SE 	IA, (3) PER SECTOR, (3) SECTORS TOTAL ECTOR, (3) SECTORS TOTAL			1	7 17		Parul sendanyon		A01.1	SITE PLAN		8	N/O E. WARDLOW ROAD
INSTALL (1) 2' Ø MW DISH	Average and a second se				severk Hom Ashrovicher	Michael C Illing Total Vene & Flags Author Machael Pene S		E 81111.00	A02	PROPOSED EQUIPME	NT PLAN	8	AND E/O STEVELY STREET LONG BEACH, CA 90808
SITE ADDRESS:	N/O E. WARDLOW ROAD AND E/O STEVELY STREET.	APPLICANT:	T-MOBILE WEST CORPORATION	78	Long flow n with Year ()	000			A03	PROPOSED ANTENNA	PLAN	8	
	LONG BEACH, CA 90808		3257 E. GUASTI RD, SUITE 200 ONTARIO, CA 91761	geriei 3		Application Sheet	O Presidente les	· · · · ·	A04	NORTH ELEVATION		8	8 12/06/17 100% ZD: MINOR REV PER SCE JD
PROPERTY OWNER/LESSOF	E: SOUTHERN CALIFORNIA EDISON 2 INNOVATION WAY, 1ST FLOOR	CONTACT:	AMIEE WEEKS	100 to 10			Desirny Lama Cun 🖸	and a	A05	EAST ELEVATION		8	7 11/27/17 100% ZD: REVISION PER RF JD 6 11/17/17 100% ZD: REVISION PER SCE JD
CONTACT PHONE:	POMONA, CA 91768 (626)695-5888		T-MOBILE WEST, LLC Amiee.Weeks3@t-mobile.com	actit 190	Police Police O			6 1 2	A06	SOUTH ELEVATION		8	5 11/02/17 100% ZD: REVISION PER RF JD
CONTACT FROME.	(020)095-5888	SITE ACQ /	JILLIANNE NEWCOMER	,					A07	WEST ELEVATION		8	4 10/05/17 100% 2D: ISSUED FOR ZONING JD 3 09/14/17 100% ZD: REVISION PER SCE JD
ZONING:	PUBLIC RIGHT-OF-WAY	ZONING CONTACT:	J5 INFRASTRUCTURE PARTNERS jnewcomer@j5ip.com	The second					D01	DETAILS		8	2 09/08/17 100% ZD: REVISION PER DRM JD
JURISDICTION:	CITY OF LONG BEACH	100000000000000000000000000000000000000	(951) 382-2523		1				D02	DETAILS		8	0 08/28/17 100% ZD: FINAL SURVEY ADDED JD
LATITUDE:	33° 49' 28.7" N (NAD 83)	PROJECT MANAGER	ERIC LITTLE J5 INFRASTRUCTURE PARTNERS		57	P Dv alo Missi		9	D03	DETAILS		8	E 08/18/17 90% ZD REV PER DRM 7/17/17 PS D 07/19/17 90% ZD REV PER DRM 7/17/17 JD
LONGITUDE:	-118° 05' 27.7" W (NAD 83)		elittle@j5ip.com (949) 842-7002	Y/	///					, ppp	277.17.0		C 07/14/17 90% ZD REVISION PER DRM JD B 07/06/17 90% ZD REVISION PER DRM BH
APN:	7075-002-906	ENGINEER	FRANCIS DONG	GITE						APPR	OVALS:		A 06/28/17 90% ZD ISSUED FOR REVIEW BH
CURRENT USE:	SCE LATTICE TOWER		J5 INFRASTRUCTURE PARTNERS fdong@j5ip.com					N Contract			SIGNATURE	DATE	REV DATE DESCRIPTION
PROPOSERVIOR		ARE MANAGE	(949) 247-7767 x112					96.77	LAND OWNE				
PROPOSED USE:	WIRELESS COMM. FACILITY	A&E MANAGE	J5 INFRASTRUCTURE PARTNERS		No. Tes	O Effection beautifus		1	DEVELOP. M	100000000000000000000000000000000000000		$\sqcup \sqcup$	
ACCESSIBILITY REQUIREMENTS:	THE FACILITY IS UNMANNED AND NOT FOR CONTINUOUS		jdelacruz@j5ip.com (949) 247-7767 x189			#TOENIN QUE!			PROJECT MA				
	HUMAN HABITATION. DISABLED/CHALLENGED	RF ENGINEER:							ZONING MAN				
	ACCESS IS NOT REQUIRED PER CBC 2016, SECTION 11B-203.4		T-MOBILE Christopher.Gamboa7@T-mobile.com					À	TMO RF EN				
	(LIMITED ACCESS SPACE)	CONSTRUCTION	N MATT TRIBBETT VANTAGE COMPANY						SAC. REP:				
		WAINAGER.	(951) 897-5601 matthew.tribbett@vantagecompany.com					5,000	CONST. MANA	AGER			
			matthew.inbbett@vantagecompany.com						NETWORK OF	S:			
	STATE				GENE	RAL CONTRAC	TOR NOTES			CODE CO	MPLIANCE	•	IT IS A VIOLATION OF LAW FOR ANY PERSON, UNLESS THEY ARE ACTING UNDER THE DIRECTION OF A LICENSED PROFESSIONAL ENGINEER,
STRUCTURAL: STRUCTURAL ANALYSIS IS NOT WITHIN THE SCOPE OF WORK CONTAINED IN THIS DRAWINGS SET. FOR ANALYSIS OF EXISTING AND/OR PROPOSED COMPONENTS, REFER TO STRUCTURAL ANALYSIS PROVIDED UNDER SEPARATE COVER. ANTENNA MOUNT ANALYSIS IS NOT WITHIN THE SCOPE OF WORK CONTAINED IN THIS DRAWING SET. FOR ANALYSIS OF ANTENNA MOUNT TO SUPPORT EXISTING AND/OR PROPOSED COMPONENTS. REFER TO ANTENNA MOUNT STRUCTURAL ANALYSIS PROVIDED UNDER SEPARATE COVER.			DO NOT SCALE DRAWINGS SUBCONTRACTOR SHALL VERIFY ALL PLANS & EXISTING DIMENSIONS & CONDITIONS ON THE JOB SITE & SHALL IMMEDIATELY NOTIFY THE ENGINEER IN WRITING OF ANY DISCREPANCIES BEFORE PROCEEDING WITH THE WORK OR BE RESPONSIBLE FOR SAME.			SITE & EDING	PER CALIFORNIA BUILDING STANDARDS CODE, "TITLE 24 OF THE CALIFORNIA CODE OF REGULATIONS" GOVERNS THE DESIGN AND CONSTRUCTION OF ALL BUILDING OCCUPANCIES AND ASSOCIATED FACILITIES AND EQUIPMENT THROUGHOUT CALIFORNIA. RELEVANT CODE SECTIONS ARE (BUT NOT LIMITED TO): 1. 2016 CALIFORNIA BUILDING CODE				SHEET TITLE TITLE SHEET		
PROPRIETARY INFORMATIO	N: THE INFORMATION CONTAINED CLOSURE OTHER THAN AS IT RELA	WITHIN THIS SE	F OF DRAWINGS IS PROPRIETARY E IS STRICTLY PROHIBITED.						3. 2016 CA 4. 2016 CA 5. 2016 CA 6. 2016 CA 7. CITY/CO	ILIFORNIA ELECTRICAL CODE ILIFORNIA ENERGY CODE ILIFORNIA HISTORICAL BUILDING CO ILIFORNIA FIRE CODE ILIFORNIA EXISTING BUILDING CODI DUNTY ORDINANCES A-222-G-2009			SHEET NUMBER TO1
								1		5 700		- 1	

- FOR THE PURPOSE OF THIS CONSTRUCTION DRAWING, THE FOLLOWING DEFINITIONS SHALL APPLY: CONTRACTOR — GENERAL CONTRACTOR (CONSTRUCTION) AND ANY LOWER TIER SUBCONTRACTORS. ENGINEER — J5 INFRASTRUCTURE PARTNERS OWNER — T—MOBILE WIRELESS
- 2. CONTRACTOR SHALL VISIT THE CELL SITE PRIOR TO THE SUBMISSION OF BIDS TO FAMILIARIZE WITH THE EXISTING CONDITIONS AND TO CONFIRM THAT THE WORK CAN BE ACCOMPLISHED AS SHOWN ON THE CONSTRUCTION DRAWINGS. ANY DISCREPANCY, CONFLICT, OR OMISSION FOUND SHALL BE BROUGHT TO THE ATTENTION OF THE ENGINEER FOR RESOLUTION, PRIOR TO BID SUBMISSION & PRIOR TO COMMENCEMENT OF ANY WORK. THE CONTRACTOR SHALL BE RESPONSIBLE FOR CORRECTION OF ANY ERRORS, OMISSIONS, OR DISCREPANCIES DISCOVERED AFTER THE COMMENCEMENT OF CONSTRUCTION WHICH HAVE NOT BEEN BROUGHT TO THE ATTENTION OF THE ENGINEER. ANY COSTS INCURRED TO REMEDY THE SITUATION SHALL BE AT THE EXPENSE OF THE CONTRACTOR. THE ENGINEER SHALL APPROVE ALL METHODS USED TO CORRECTION THE SITUATION.
- 3. ALL MATERIALS FURNISHED AND INSTALLED SHALL BE IN STRICT ACCORDANCE WITH ALL APPLICABLE CODES, REGULATIONS, AND ORDINANCES. CONTRACTOR SHALL ISSUE ALL APPROPRIATE NOTICES AND COMPLY WITH ALL LAWS, ORDINANCES, RULES, REGULATIONS, AND LAWFUL ORDERS OF ANY PUBLIC AUTHORITY REGARDING THE PERFORMANCE OF THE WORK.

ALL WORK CARRIED OUT SHALL COMPLY WITH ALL APPLICABLE MUNICIPAL AND UTILITY COMPANY SPECIFICATIONS AND LOCAL JURISDICTIONAL CODES, ORDINANCES AND APPLICABLE REGULATIONS.

- 4. THE CONTRACTOR SHALL INSTALL ALL EQUIPMENT AND MATERIALS IN ACCORDANCE WITH MANUFACTURER'S RECOMMENDATIONS UNLESS SPECIFICALLY STATED OTHERWISE.
- THE CONTRACTOR SHALL DETERMINE ACTUAL ROUTING OF CONDUITS AND OTHER CABLES. CONTRACTOR SHALL UTILIZE EXISTING TRAYS AND/OR SHALL ADD NEW TRAYS AS NECESSARY.
- THE CONTRACTOR SHALL PROTECT EXISTING IMPROVEMENTS, PAVEMENTS, CURBS, LANDSCAPING AND STRUCTURES. ANY DAMAGES SHALL BE REPAIRED AT CONTRACTOR'S EXPENSE TO THE SATISFACTION OF OWNER.
- CONTRACTOR SHALL LEGALLY AND PROPERLY DISPOSE OF ALL SCRAP MATERIALS SUCH AS COAXIAL CABLES AND OTHER
 ITEMS REMOVED FROM THE EXISTING FACILITY. ANTENNAS REMOVED SHALL BE RETURNED TO THE OWNER'S DESIGNATED
 LOCATION.
- 8. AT ANY TIME DURING THE DURATION OF CONSTRUCTION, THE CONTRACTOR SHALL BE RESPONSIBLE FOR THE SECURITY OF THE SITE. CONTRACTOR SHALL LEAVE PREMISES IN CLEAN CONDITION.
- AS MAY BE REQUIRED BY THE GOVERNING AGENCY OR PROPERTY OWNER, THE CONTRACTOR SHALL PROVIDE TEMPORARY POWER, WATER, OR TOILET FACILITIES.
- 10. THE EXISTING CELL SITE IS ASSUMED TO BE IN FULL COMMERCIAL OPERATION. ANY CONSTRUCTION WORK BY SUBCONTRACTOR SHALL NOT DISRUPT THE EXISTING NORMAL OPERATION. ANY WORK ON EXISTING EQUIPMENT MUST BE COORDINATED WITH THE OWNER. ALSO, WORK MAY NEED TO BE SCHEDULED FOR AN APPROPRIATE MAINTENANCE WINDOW USUALLY IN LOW TRAFFIC PERIODS AFTER MIDNIGHT.
- 11. THE CONTRACTOR SHALL COMPLY WITH ALL OSHA REGULATIONS DURING THE ENTIRE CONSTRUCTION PERIOD. SINCE THE CELL SITE MAY BE ACTIVE, ALL SAFETY PRECAUTIONS MUST BE TAKEN WHEN WORKING AROUND HIGH LEVELS OF ELECTROMAGNETIC RADIATION. EQUIPMENT SHOULD BE SHUTDOWN PRIOR TO PERFORMING ANY WORK THAT COULD EXPOSE THE WORKERS TO DANGER. PERSONAL RF EXPOSURE MONITORS ARE REQUIRED TO BE WORN TO ALERT OF ANY DANGEROUS EXPOSURE LEVELS.
- 12. THE CONTRACTOR SHALL NOT USE OR INSTALL ANY MATERIAL CONTAINING ASBESTOS OR LEAD PAINT CONTENT. THE USE OF SUCH MATERIAL IS STRICTLY PROHIBITED.
- 13. IT IS THE RESPONSIBILITY OF THE CONTRACTOR TO LOCATE ALL EXISTING UTILITIES, WHETHER OR NOT SHOWN ON PLANS, AND TO AVOID OR PROTECT THEM FROM ANY DAMAGE. ANY COSTS INCURRED TO REPAIR UTILITIES DAMAGED DURING CONSTRUCTION SHALL BE AT THE SOLE COST OF THE CONTRACTOR. TELEPHONE 811 FOR USA DIG ALERT.
- 14. THE GOVERNING AGENCY MAY REQUIRE A COPY OF THE APPROVED PLANS TO BE KEPT ON SITE AT ALL TIMES. THE CONTRACTOR SHALL MAKE SUCH A SET AVAILABLE FOR INSPECTION AT ALL TIMES. ANY DEVIATIONS FROM THE APPROVED SET SHALL BE DOCUMENTED AND PROVIDED TO THE ENGINEER FOR APPROVAL. THE CONTRACTOR SHALL BEAR THE SOLE COST TO CORRECT ANY INSTALLATION WHICH DEVIATES FROM APPROVED PLANS AND IS NOT ACCEPTED BY THE ENGINEER.
- 15. THE CONTRACTOR IS SOLELY RESPONSIBLE FOR ALL MEANS & METHODS, TECHNIQUES, SEQUENCING, AND PROCEDURES REQUIRED TO PERFORM THE WORK. ANY ANALYSIS OF THE STRUCTURE UNDER TEMPORARY CONSTRUCTION LOADING CONDITIONS IS OUTSIDE OF THE SCOPE OF THESE DRAWINGS. THE CONTRACTOR SHOULD EVENLY DISTRIBUTE ANY MATERIAL TO BE STORED ON SITE DURING CONSTRUCTION SO THAT THE LOAD DOES NOT EXCEED THE STRUCTURES DESIGNED LIVE LOAD; OR PROVIDE TEMPORARY SHORING OR BRACING IN THESE AREAS.
- 16. DRAWINGS ARE NOT TO BE SCALED. DIMENSIONS SHOWN TAKE PRECEDENCE OVER SCALE.
- 17. ALL NEW COMPONENTS ADD TO THE EXTERIOR OF THE STRUCTURE, WHICH ARE VISIBLE FROM PUBLIC VIEW, SHALL BE PAINTED TO MATCH THE EXISTING CONDITIONS.
- 18. ALL DETAILS AND NOTES INDICATED IN THESE PLANS ARE THE MINIMUM REQUIREMENTS.
- 19. IT MAY BE NECESSARY TO TEMPORARILY RELOCATE, REMOVE, REPLACE, OR WORK AROUND VARIOUS ARCHITECTURAL FEATURES, PIPES, FIXTURES, CABLING, OR OTHER NON-STRUCTURAL ITEMS IN ORDER TO COMPLETE THE PROPOSED WORK. CONTRACTOR SHALL RESTORE THESE ITEMS TO THEIR ORIGINAL CONDITION AT THEIR EXPENSE UNLESS OTHERWISE NOTED IN THESE PLANS.

		SYMBOLS				ABBREVIATIONS	5	
	S/G	SOLID GROUND BUS BAR		ND ROD WITH ACCESS	AGL	ABOVE GRADE LEVEL	(P)	PROPOSED
	S/N	SOLID NEUTRAL BUS BAR	(TEST	WELL)	(E) MIN	EXISTING MINIMUM	ЕМТ	ELECTRICAL METALLIC TUBING
ANY	A	SUPPLEMENTAL GROUND CONDUCTOR	—— G ——	GROUNDING WIRE, DASHED REPRESENTS UNDERGROUND	N.T.S.	111102111111111111	GND	GROUND
т		2-POLE THERMAL-MAGNETIC CIRCUIT BREAKER	— т —	TELEPHONE LINE, DASHED REPRESENTS UNDERGROUND	REF RF	REFERENCE RADIO FREQUENCY	GPS	GLOBAL POSITIONING SYSTEM
s	<u></u>	SINGLE-POLE THERMAL-MAGNETIC CIRCUIT BREAKER	— с —	COAXIAL CABLE, DASHED REPRESENTS UNDERGROUND	T.B.D. TYP	TO BE DETERMINED TYPICAL	GFCI	GROUND FAULT CIRCUIT
	\otimes	XIT GROUND ROD (CHEMICAL)	—— A ——	ANTENNA COAX	EGR	EQUIPMENT GROUND RING		
	\otimes	GROUND ROD	— ОН/Е —	OVERHEAD ELECTRICAL CABLES	AWG	AMERICAN WIRE GAUGE	BTCW	BARE TINNED COPPER WIRE
	h	DISCONNECT SWITCH		CABLES				
CAL	M	UTILITY METER			MGB	MASTER GROUND BUS		
	1 ()				EG	EQUIPMENT GROUND		
		EXOTHERMIC CONNECTION (CADWELD) TO GROUND RING AND COMPRESSION TO GROUND HALO			BCW GEN	BARE COPPER WIRE GENERATOR		
		COMPRESSION, CLAMP, OR DOUBLE HOLE LUG TYPE GROUND CONNECTION			IGR	INTERIOR GROUND RING (HALO)		
-	1 = 0 =	N.I.S.						

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THE INFORMATION CONTAINED IN THIS SET OF DRAWINGS IS PROPRIETARY & CONFIDENTIAL TO -MOBILE ANY USE OR DISCLOSURE OTHER THAN AS IT RELATES TO T -MOBILE IS STRICTLY PROHIBITED



2030 MAIN STREET, SUITE 200 IRVINE, CA 92614

LEGEND

- 1. ALL GROUNDING WORK SHALL COMPLY WITH THE LATEST EDITION OF THE CALIFORNIA ELECTRICAL CODE, AS WELL AS WITH ALL LOCAL, STATE, AND NATIONAL CODES, LAWS, AND ORDINANCES APPLICABLE TO GROUNDING WORK.
- 2. EXOTHERMIC WELDS SHALL BE USED FOR ALL GROUNDING CONNECTIONS BELOW GRADE.
- 3. THE CONTRACTOR IS RESPONSIBLE FOR PROPERLY SEQUENCING GROUNDING AND UNDERGROUND CONDUIT INSTALLATION SO AS TO PREVENT ANY LOSS OF CONTINUITY IN THE GROUNDING SYSTEM OR DAMAGE TO THE CONDUIT.
- 4. ALL DETAILS ARE SHOWN IN GENERAL TERMS. ACTUAL GROUNDING INSTALLATION SHALL BE ACCORDING TO SPECIFIC SITE CONDITIONS.
- 5. GROUNDING CONDUCTORS SHALL BE #2 AWG SOLID BARE TINNED COPPER WIRE, UNLESS NOTED OTHERWISE.
- 6. APPROVED ANTIOXIDANT COATINGS (I.E., CONDUCTIVE GEL OR PASTE) SHALL BE USED ON ALL COMPRESSION AND BOLTED GROUND CONNECTIONS.
- 7. INSTALL GROUND CONDUCTORS AND GROUND ROD A MINIMUM OF 1'-0" FROM CONCRETE SLAB, FOOTING, OR FENCE.
- 8. ALL GROUNDING INSTALLATIONS AND CONNECTIONS SHALL BE MADE BY AN ELECTRICAL CONTRACTOR.
- 9. MISCELLANEOUS ELECTRICAL AND NON-ELECTRICAL METAL BOXES, FRAMES AND SUPPORTS SHALL BE BONDED TO THE GROUND RING, IN ACCORDANCE WITH THE NEC.
- 10. METAL CONDUIT AND TRAY SHALL BE GROUNDED AND MADE ELECTRICALLY CONTINUOUS WITH LISTED BONDING FITTINGS OR BY BONDING ACROSS THE DISCONTINUITY WITH 6 AWG COPPER WIRE AND UL APPROVED GROUNDING TYPE CONDUIT CLAMPS.
- 11. GROUND CONDUCTORS USED IN THE FACILITY GROUND AND LIGHTNING PROTECTION SYSTEMS SHALL NOT BE ROUTED THROUGH METALLIC OBJECTS THAT FORM A RING AROUND THE CONDUCTOR, SUCH AS METAL SUPPORT CLIPS OR SLEEVES THROUGH WALLS OR FLOORS. WHEN IT IS REQUIRED TO BE HOUSED IN CONDUIT TO MEET CODE REQUIREMENTS OR LOCAL CONDITIONS, NON-METALLIC MATERIAL SUCH AS PVC PLASTIC CONDUIT SHALL BE USED. WHERE USE OF METAL CONDUIT IS UNAVOIDABLE (E.G., NON-METALLIC CONDUIT PROHIBITED BY LOCAL CODE) THE GROUND CONDUCTOR SHALL BE BONDED TO EACH END OF THE
- 12. CHEMICAL GROUND SHALL BE XIT, CHEM-ROC, OR APPROVED EQUAL, WHEN REQUIRED.
- 13. CONNECTIONS TO THE GROUND BARS SHALL NOT BE DOUBLED UP OR STACKED. BACK-TO-BACK CONNECTIONS ON OPPOSITE SIDES OF THE GROUND BAR ARE PERMITTED.
- 14. NOTIFY PROJECT MANAGER IF THERE ARE DIFFICULTIES INSTALLING GROUNDING SYSTEM DUE TO SOIL CONDITIONS.
- 15. ANY EQUIPMENT, BOX, SKID TO BE GROUNDED AND DOES NOT HAVE A DESIGNATED GROUND CONNECTION SHALL BE DRILLED AS NECESSARY TO CONNECT A GROUND WIRE. REMOVE PAINT IN AREA UNDER LUG. APPLY ANTI-OXIDANT COMPOUND AND CONNECT WITH TWO-HOLE, COMPRESSION LUG.

GROUNDING NOTES

- CONTRACTOR SHALL BE RESPONSIBLE FOR PROVIDING ALL MEANS AND METHODS TO COMPLETE ALL UPGRADES AS INDICATED IN THIS DOCUMENT.
- 2. ALL DIMENSIONS, SECTIONS AND DETAILS OF THE EXISTING STRUCTURE ARE INCLUDED FOR INFORMATION PURPOSES ONLY. THE CONTRACTOR SHALL VERIFY ALL RELEVANT INFORMATION PRIOR TO CONSTRUCTION OR FABRICATION. NOTIFY THE ENGINEER-OF-RECORD IMMEDIATELY OF ANY DISCREPANCIES. ALL NEW WORK SHALL ACCOMMODATE EXISTING CONDITIONS.
- 3. CONTRACTOR IS RESPONSIBLE FOR ERECTING TEMPORARY BARRICADES AND/OR FENCING TO PROTECT THE SAFETY OF THE PUBLIC DURING CONSTRUCTION. THE CONTRACTOR SHALL REMOVE ALL TEMPORARY BARRIERS AND REPAIR ALL DAMAGE TO PROPERTY ON THE SITE CAUSED BY THIS CONSTRUCTION. THE COST OF REPAIR IS THE CONTRACTOR'S RESPONSIBILITY.
- 4. ALL WORK SHALL BE IN ACCORDANCE WITH APPLICABLE LOCAL, STATE, AND FEDERAL REQUIREMENTS.
- 5. COORDINATE WORK INDICATED ON THESE DRAWINGS WITH THE NEW EQUIPMENT, EXISTING EQUIPMENT, WAVEGUIDE ETC.
- 6. THE CONTRACTOR SHALL BE RESPONSIBLE FOR VERIFICATION OF ALL MEASUREMENTS AT THE SITE PRIOR TO ORDERING ANY MATERIALS OR CONDUCTING ANY WORK.
- 7. ALL DETAILING, FABRICATION AND ERECTION OF STRUCTURAL STEEL SHALL CONFORM TO AISC SPECIFICATIONS AND CODES, LATEST EDITION.
- 8. CONTRACTOR SHALL COLD-GALVANIZE ALL RAW STEEL AS REQUIRED DURING CONSTRUCTION PROCESS.

SITE NUMBER:

LA33958B

SITE NAME: EL DORADO MODEL AIRPLANE FIELD

N/O E. WARDLOW ROAD AND E/O STEVELY STREET LONG BEACH, CA 90808

06/28/17	90% ZD ISSUED FOR REVIEW	BH
07/06/17	90% ZD REVISION PER DRM	Bi
07/14/17	90% ZD REVISION PER DRM	Ji
07/19/17	90% ZD REV PER DRM 7/17/17	JI
08/18/17	90% ZD REV PER DRM 7/17/17	P
08/28/17	100% ZD: FINAL SURVEY ADDED	3
08/31/17	100% ZD: POWER & TECLO POC	J
09/08/17	100% ZD: REVISION PER DRM	J
09/14/17	100% ZD: REVISION PER SCE	J
10/05/17	100% ZD: ISSUED FOR ZONING	J
11/02/17	100% ZD: REVISION PER RF	J
11/17/17	100% ZD: REVISION PER SCE	J
11/27/17	100% ZD: REVISION PER RF	9
12/06/17	100% ZD: MINOR REV PER SCE	1
	11/27/17 11/17/17 11/17/17 11/02/17 10/05/17 09/14/17 09/08/17 08/31/17 08/18/17 07/19/17	11/27/17 100% ZD: REVISION PER RF 11/17/17 100% ZD: REVISION PER RF 11/17/17 100% ZD: REVISION PER RF 10/05/17 100% ZD: REVISION PER RF 10/05/17 100% ZD: REVISION PER RF 09/08/17 100% ZD: REVISION PER DRM 08/31/17 100% ZD: REVISION PER DRM 08/31/17 100% ZD: POWER & TECLO POC 08/29/17 100% ZD: FINAL SURVEY ADDED 08/18/17 90% ZD: REV PER DRM 7/17/17 07/19/17 90% ZD: REV PER DRM 7/17/17 07/19/17 90% ZD: REV PER DRM

IT IS A VIOLATION OF LAW FOR ANY PERSON, INLESS THEY ARE ACTING UNDER THE DIRECTIC OF A LICENSED PROFESSIONAL ENGINEER, TO ALTER THIS DOCUMENT.

GENERAL NOTES, ABBREVIATIONS, AND SYMBOLS

T02

GENERAL UPGRADE NOTES

GENERAL NOTES

SCHEDULE B ITEMS A-D ARE TAX/LIENS RELATED ITEMS 1,20 ARE RIGHTS RELATED ITEMS 3,6,7,13,14,17,19 ARE DEED RELATED EASEMENT(S) FOR THE PURPOSE(S) SHOWN BELOW AND RIGHTS INCIDENTAL THERETO, AS GRANTED IN A DOCUMENT: GRANTED TO: LOS ANGELES COUNTY FLOOD CONTROL DISTRICT PURPOSE: THE CONSTRUCTION, RECONSTRUCTION, INSPECTION, MAINTENANCE AND REPAIR OF PROTECTION WORKS FOR THE PURPOSE OF CONFINING THE WATER OF THE SAN GABRIEL RIVER IN A SINGLE CHANNEL AND FOR THE PURPOSE OF ESTABLISHING AN OFFICIAL CHANNEL TO CARRY THE WATER OF THE SAID STREAM IN A DEFINITE COURSE, SAID EASEMENT AND RIGHT OF WAY TO EXTEND OVER, ACROSS AND UPON RECORDING NO: IN BOOK 5109 PAGE 392 OFFICIAL RECORDS AFFECTS: LOT 62 4. EASEMENT(S) FOR THE PURPOSE(S) SHOWN BELOW AND RIGHTS INCIDENTAL THERETO, AS GRANTED IN A DOCUMENT: GRANTED TO: PACIFIC LIGHTING GAS SUPPLY COMPANY, A CORPORATION PURPOSE: PIPE LINES RECORDING DATE: MAY 1, 1951 RECORDING NO: IN BOOK 36185 PAGE 1 OFFICIAL RECORDS THE EASEMENT DOES NOT AFFECT THE SUBJECT PARCEL. FASEMENT(S) FOR THE PURPOSE(S) SHOWN BELOW AND RIGHTS INCIDENTAL THERETO, AS GRANTED IN A DOCUMENT: GRANTED TO: SOUTHERN CALIFORNIA EDISON COMPANY PURPOSE: ROADS, ELECTRICAL TRANSMISSION LINES, OVERHEAD AND UNDERGROUND DATE: SEPTEMBER 3, 1953 RECORDING NO: IN 300K 42614 PAGE 258 OFFICIAL RECORDS AFFECTS: AS DESCRIBED THEREIN. AN AGREEMENT TO MODIFY THE TERMS AND PROVISIONS OF THE SAID DOCUMENT, AS THEREIN PROVIDED EXECUTED BY: CITY OF LONG BEACH, AND SOUTHERN CALIFORNIA EDISON COMPANY PERCORDING DATE: MARPL 27, 1961.

RECORDING DATE: MARCH 27, 1961
RECORDING NO: 4995 IN BOOK D1169 PAGE 199 OFFICIAL RECORDS
AN AGREEMENT TO MODIFY THE TERMS AND PROVISIONS OF THE SAID DOCUMENT, AS THEREIN PROVIDED EXECUTED BY: CITY OF LONG BEACH, A CORPORATION, AND SOUTHERN CALIFORNIA EDISON COMPANY, A CORPORATION
RECORDING DATE: NOVEMBER 14, 1962
RECORDING NO: 4556 IN BOOK D1822 PAGE 262 OFFICIAL RECORDS
LIMITATIONS ON THE USE, BY THE OWNERS OF SAID LAND, OF THE EASEMENT AREA AS SET FORTH IN THE EASEMENT
DOCUMENT SHOWN HERITMABOVE. DOCUMENT SHOWN HEREIMABOVE.
REFERENCE IS HEREBY MADE TO SAID DOCUMENT FOR FULL PARTICULARS.
MATTERS CONTAINED IN THAT CERTAIN DOCUMENT
ENTITLED: ASSIGNMENT AND ASSUMPTION OF EASEMENTS ENTITIED: ASSIGNMENT AND ASSIGNMENT OF CASEMENTS

EXECUTED BY: PACIFIC TERMINALS LLC, A DELAWARE LIMITED LIABILITY COMPANY ('ASSIGNOR') AND

SOUTHERN CALIFORNIA EDISON COMPANY, A CALIFORNIA CORPORATION ('ASSIGNEE')

RECORDING DATE: APRIL 25, 2005

RECORDING NO: 05-0956006 OFFICIAL RECORDSREFERENCE IS HEREBY MADE TO SAID DOCUMENT FOR FULL PARTICULARS.

EASEMENT(S) FOR THE PURPOSE(S) SHOWN BELOW AND RIGHTS INCIDENTAL THERETO, AS GRANTED IN A DOCUMENT: CRANTED TO: METROPOLITAN WATER DISTRICT OF SOUTHERN CALIFORNIA, A PUBLIC CORPORATION PURPOSE: TEMPORARY EASEMENT RECORDING DATE: MAY 12, 1966 RECORDING NO: 2318 OFFICIAL RECORDS AFFECTS: AS DESCRIBED THEREIN

EASEMENT(S) FOR THE PURPOSE(S) SHOWN BELOW AND RIGHTS INCIDENTAL THERETO, AS GRANTED IN A DOCUMENT:
GRANTED TO: METROPOLITAN WATER DISTRICT OF SOUTHERN CALIFORNIA, A PUBLIC CORPORATION
PURPOSE: INSTALLATION, OPERATION, MAINTENANCE, REPAIR AND REPLACEMENT OF A WATER MAIN FOR
THE TRANSPORTATION OF WATER, TOGETHER WITH THE RIGHT OF INGRESS AND EGRESS
RECORDING DATE: MAY 12, 1966
RECORDING NO: 2319 OFFICIAL RECORDS

EASEMENT(S) FOR THE PURPOSE(S) SHOWN BELOW AND RIGHTS INCIDENTAL THERETO, AS GRANTED IN A DOCUMENT: GRANTED TO: METROPOLITAN WATER DISTRICT OF SOUTHERN CALIFORNIA, A PUBLIC CORPORATION PURPOSE: UNDERGROUND PIPELINE RECORDING DATE: NOVEMBER 29, 1966 RECORDING NO: 2512 OFFICIAL RECORDS AFFECTS: AS DESCRIBED THEREIN.

11. EASEMENT(S) FOR THE PURPOSE(S) SHOWN BELOW AND RIGHTS INCIDENTAL THERETO, AS GRANTED IN A DOCUMENT: CRANTED TO: LOS ANGELES COUNTY FLOOD CONTROL DISTRICT, A BODY CORPORATE AND POLITIC PURPOSE: COVERED STORM DRAIN AND APPURTENANT STRUCTURES

RECORDING DATE: AUGUST 23, 1976 RECORDING NO: 3467 OFFICIAL RECORDS

THE EASEMENT DOES NOT AFFECT THE SUBJECT PARCEL

AFFECTS: AS DESCRIBED THEREIN

A EASEMENT(S) FOR THE PURPOSE(S) SHOWN BELOW AND RIGHTS INCIDENTAL THERETO, AS GRANTED IN A DOCUMENT. GRANTED TO: COUNTY OF LOS ANGELES
PURPOSE: BICYCLE TRAIL ON, OVER AND ACROSS
RECORDING DATE: MAY 22, 1979
RECORDING NO: 79-552875 OFFICIAL RECORDS AFFECTS: AS DESCRIBED THEREIN.

A EASEMENT(S) FOR THE PURPOSE(S) SHOWN BELOW AND RIGHTS INCIDENTAL THERETO, AS GRANTED IN A DOCUMENT GRANIED TO: SOUTHERN CALIFORNIA LISTSON COMPANY, A CORPORATION PURPOSE: UNDERGROUND ELECTRICAL SUPPLY SYSTEMS AND COMMUNICATION SYSTEMS RECORDING DATE: AUGUST 17, 1998
RECORDING DATE: AUGUST 17, 1998
RECORDING NO: 98–1450873 OFFICIAL RECORDS

EASEMENT(S) FOR THE PURPOSE(S) SHOWN BELOW AND RICHTS INCIDENTAL THERETO, AS GRANTED IN A DOCUMENT:
GRANTED TO: SOUTHERN CALIFORNIA EDISON COMPANY, A CORPORATION
PURPOSE: UNDERGROUND ELECTRICAL SUPPLY SYSTEMS AND COMMUNICATION SYSTEMS
RECORDING DATE: AUGUST 17, 1998
RECORDING DATE: AUGUST 17, 1998
RECORDING NO: 98-1450874 OFFICIAL RECORDS
AFFECTS: AS DESCRIBED THEREIN.

MATTERS CONTAINED IN THAT CERTAIN DOCUMENT ENTITLED: STORM DRAIN EASEMENT AGREEMENT


AFFECTS: AS DESCRIBED THEREIN.

ENTITIEED, STOWN ORGAN DESEMBLY AUGMENTAL CORPORATION, AND VESTAY/LEND LEASE LONG BEACH TOWNE CENTER, L.L.C., A DELAWARE LIMITED LIABILITY COMPANY RECORDING DATE: APRIL 8, 1999

RECORDING NO: 99-0603773 OFFICIAL RECORDS

REFERENCE IS HEREBY MADE TO SAID DOCUMENT FOR FULL PARTICULARS.

EASEMENT(S) FOR THE PURPOSE(S) SHOWN BELOW AND RIGHTS INCIDENTAL THERETO, AS GRANTED IN A DOCUMENT:
GRANTED TO: SOUTHERN CALIFORNIA EDISON COMPANY, A CORPORATION
PURPOSE: UNDERCROUND ELECTRICAL SUPPLY SYSTEMS AND COMMUNICATION SYSTEMS
RECORDING DATE: JULY 3, 2002
RECORDING NO: 02-1520039 OFFICIAL RECORDS
AFFECTS: AS DESCRIBED THEREINLIMITATIONS ON THE USE, BY THE OWNERS OF SAID LAND, OF THE EASEMENT AREA AS SET FORTH
IN THE EASEMENTOCUMENT SHOWN HEREINABOVE.REFERENCE IS HEREBY MADE TO SAID DOCUMENT FOR FULL PARTICULARS.

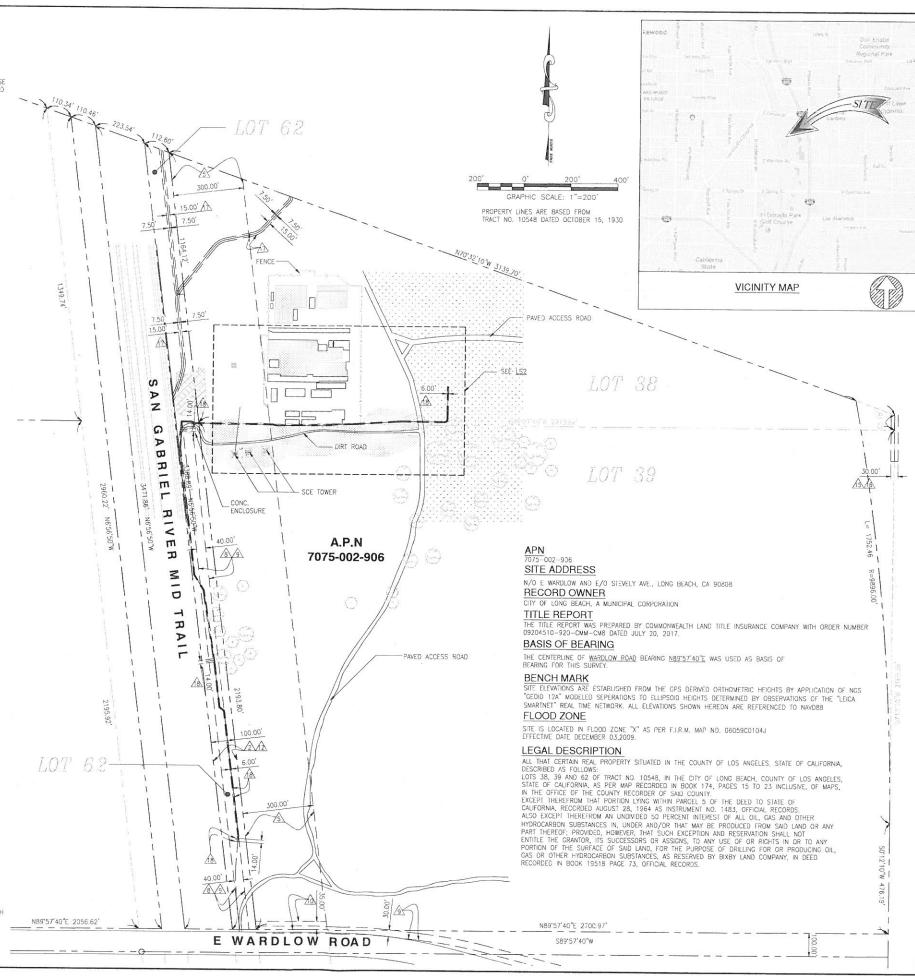







- 1		
1	8/26/2017	FINAL SURVEY
-	7/17/2017	PRELIMINARY SURVEY

AUGUST 26, 2017

FINAL SURVEY

PROJECT INFORMATION: ---

LA 33958 EL DORADO MODEL AIRPLANE FIELD N/O E WARDLOW AND E/O STEVELY AVE. LONG BEACH, CA 90808


DRAWN BY:	LJ
CHECKED BY:	MP

SHEET TITLE: -

TOPOGRAPHIC SURVEY

SHEET NUMBER: -

LS-1

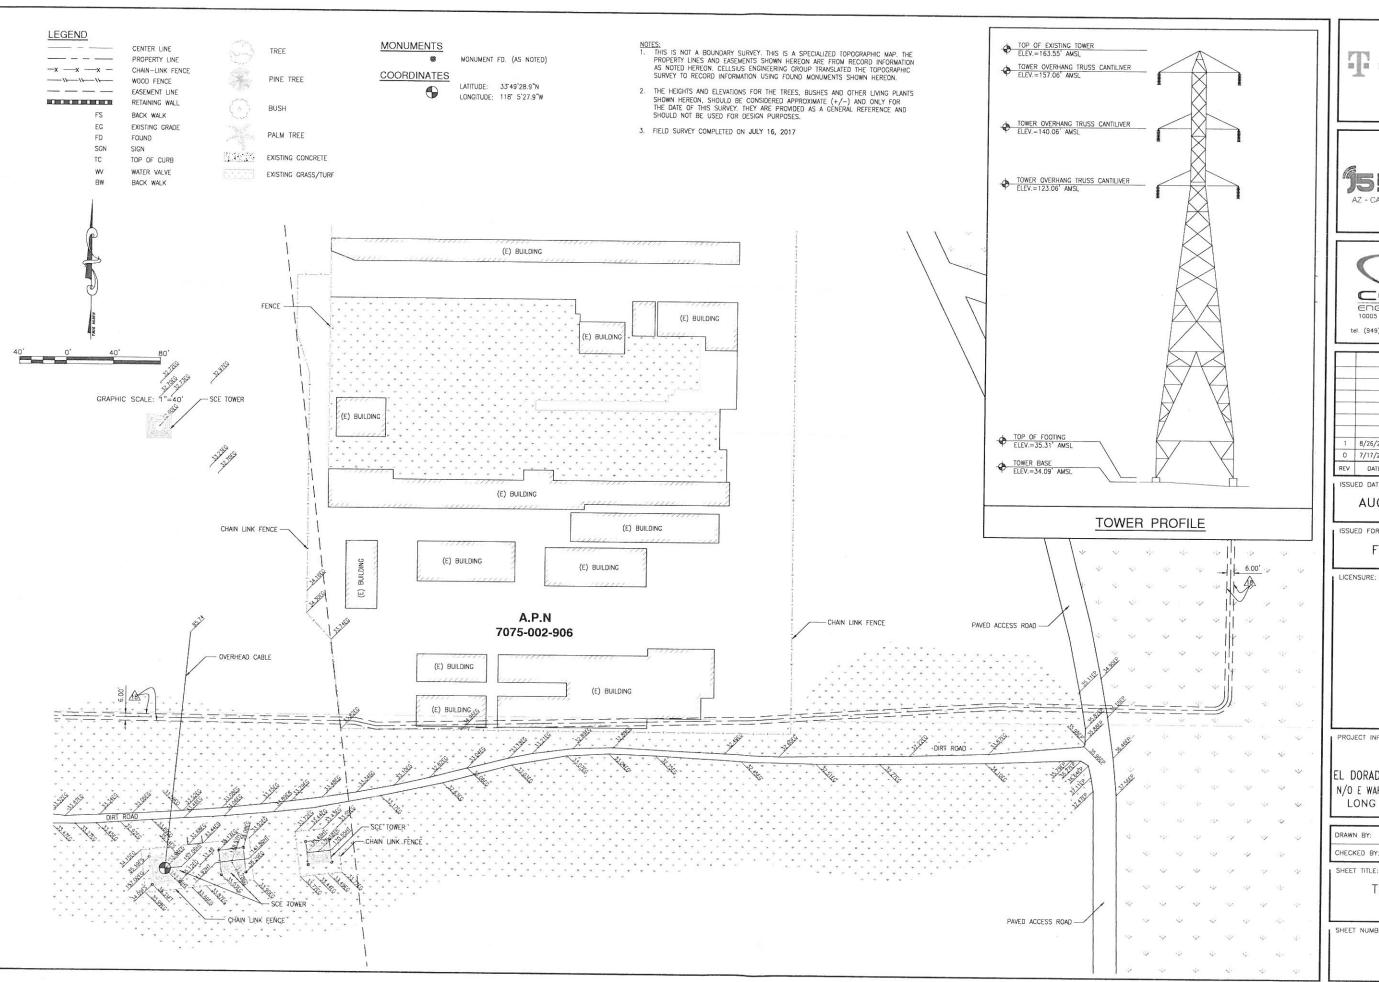

2008 McGAW AVENUE IRVINE, CA 92614





1	8/26/2017	FINAL SURVEY
0	7/17/2017	PRELIMINARY SURVEY
REV	DATE	DESCRIPTION

ISSUED DATE: -

AUGUST 26, 2017

ISSUED FOR: -

FINAL SURVEY


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- 1
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LA 33958 EL DORADO MODEL AIRPLANE FIELD N/O E WARDLOW AND E/O STEVELY AVE., LONG BEACH, CA 90808

L	
MP	

TOPOGRAPHIC SURVEY

LS-2

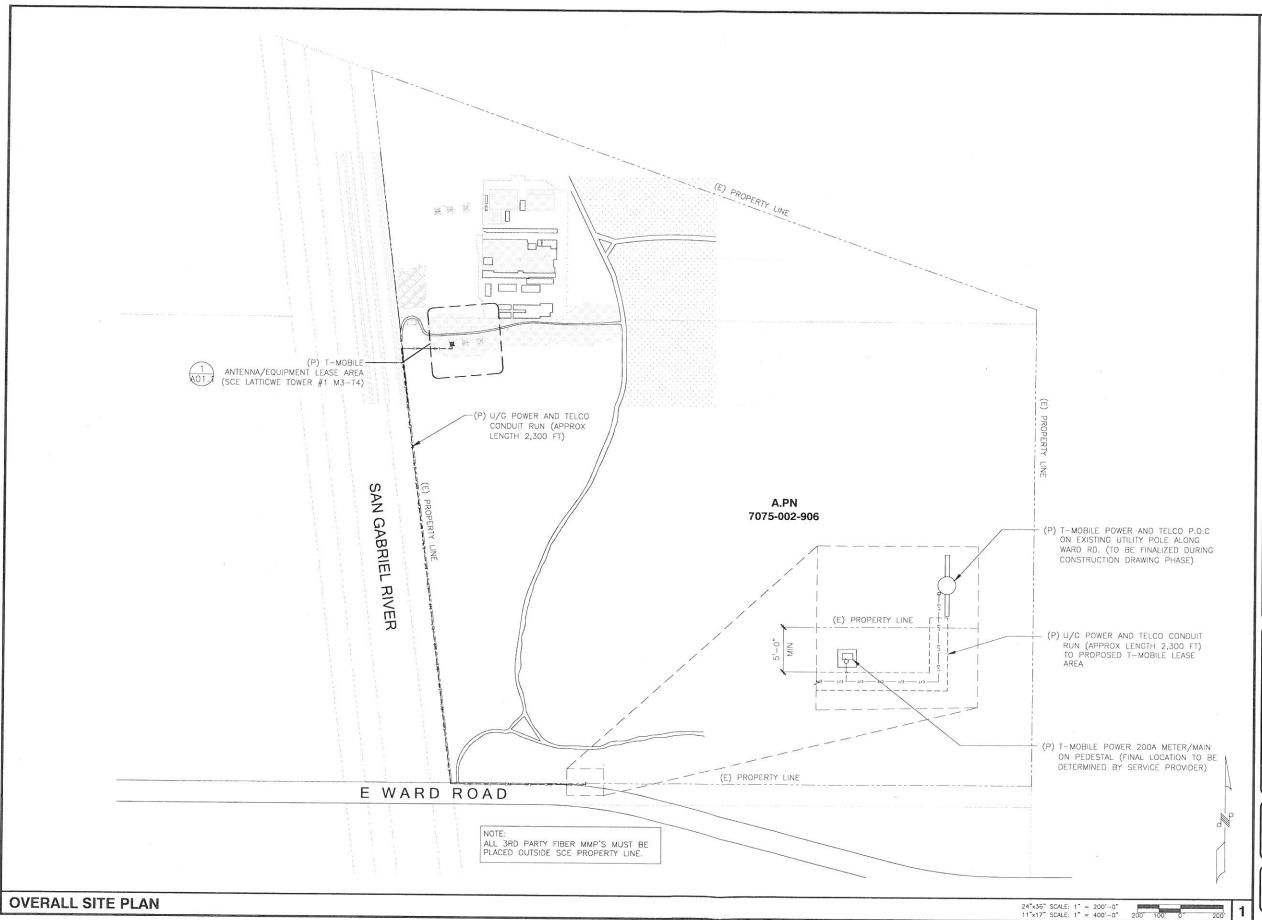

T - Mobile

T-MOBILE WEST LLC

JS INFRASTRUCTURE AZ - CA - CO - ID - NM - NV - TX - UT

2030 MAIN STREET, SUITE 200 IRVINE, CA 92614

SITE NUMBER:

LA33958B

SITE NAME: EL DORADO MODEL AIRPLANE FIELD

N/O E. WARDLOW ROAD AND E/O STEVELY STREET LONG BEACH, CA 90808


		T	Т
			+
8	12/06/17	100% ZD: MINOR REV PER SCE	t
7	11/27/17	100% ZD: REVISION PER RF	1
6	11/17/17	100% ZD: REVISION PER SCE	
5	11/02/17	100% ZD: REVISION PER RF	T
4	10/05/17	100% ZD: ISSUED FOR ZONING	T
3	09/14/17	100% ZD: REVISION PER SCE	T
2	09/08/17	100% ZD: REVISION PER DRM	T
1	08/31/17	100% ZD: POWER & TECLO POC	
0	08/28/17	100% ZD: FINAL SURVEY ADDED	1
ε	08/18/17	90% ZD REV PER DRM 7/17/17	1
D	07/19/17	90% ZD REV PER DRM 7/17/17	I
С	07/14/17	90% ZD REVISION PER DRM	T
В	07/06/17	90% ZD REVISION PER DRM	T
A	06/28/17	90% ZD ISSUED FOR REVIEW	1
REV	DATE	DESCRIPTION	


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OVERALL SITE PLAN

SHEET NUMBER

A01



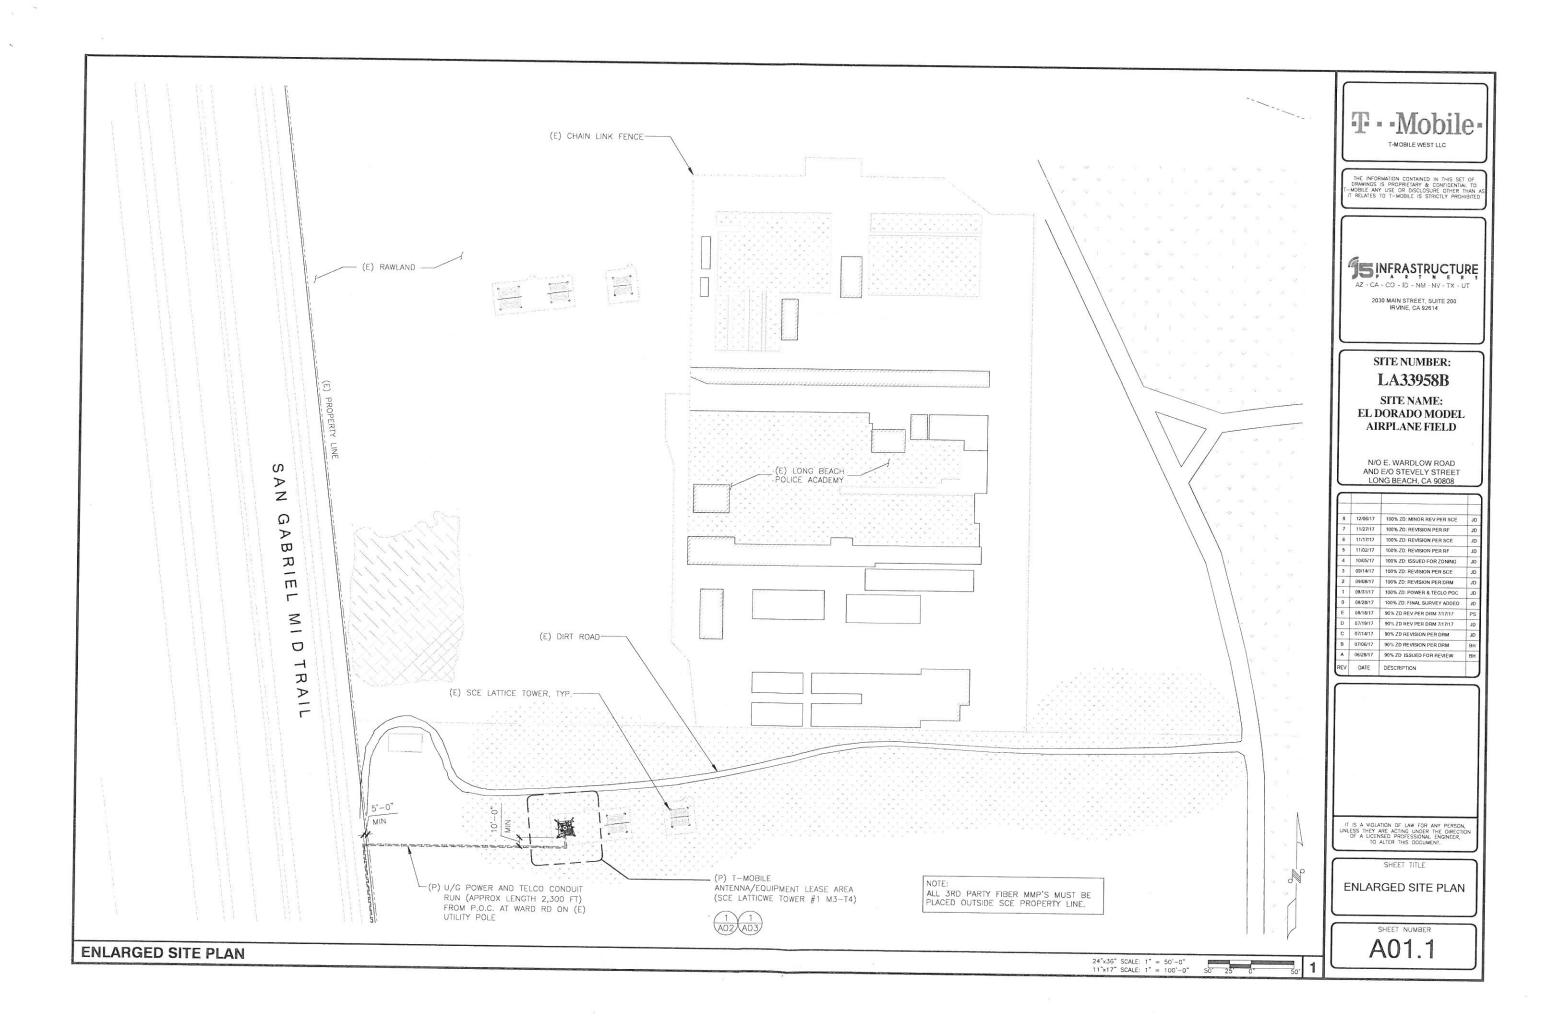

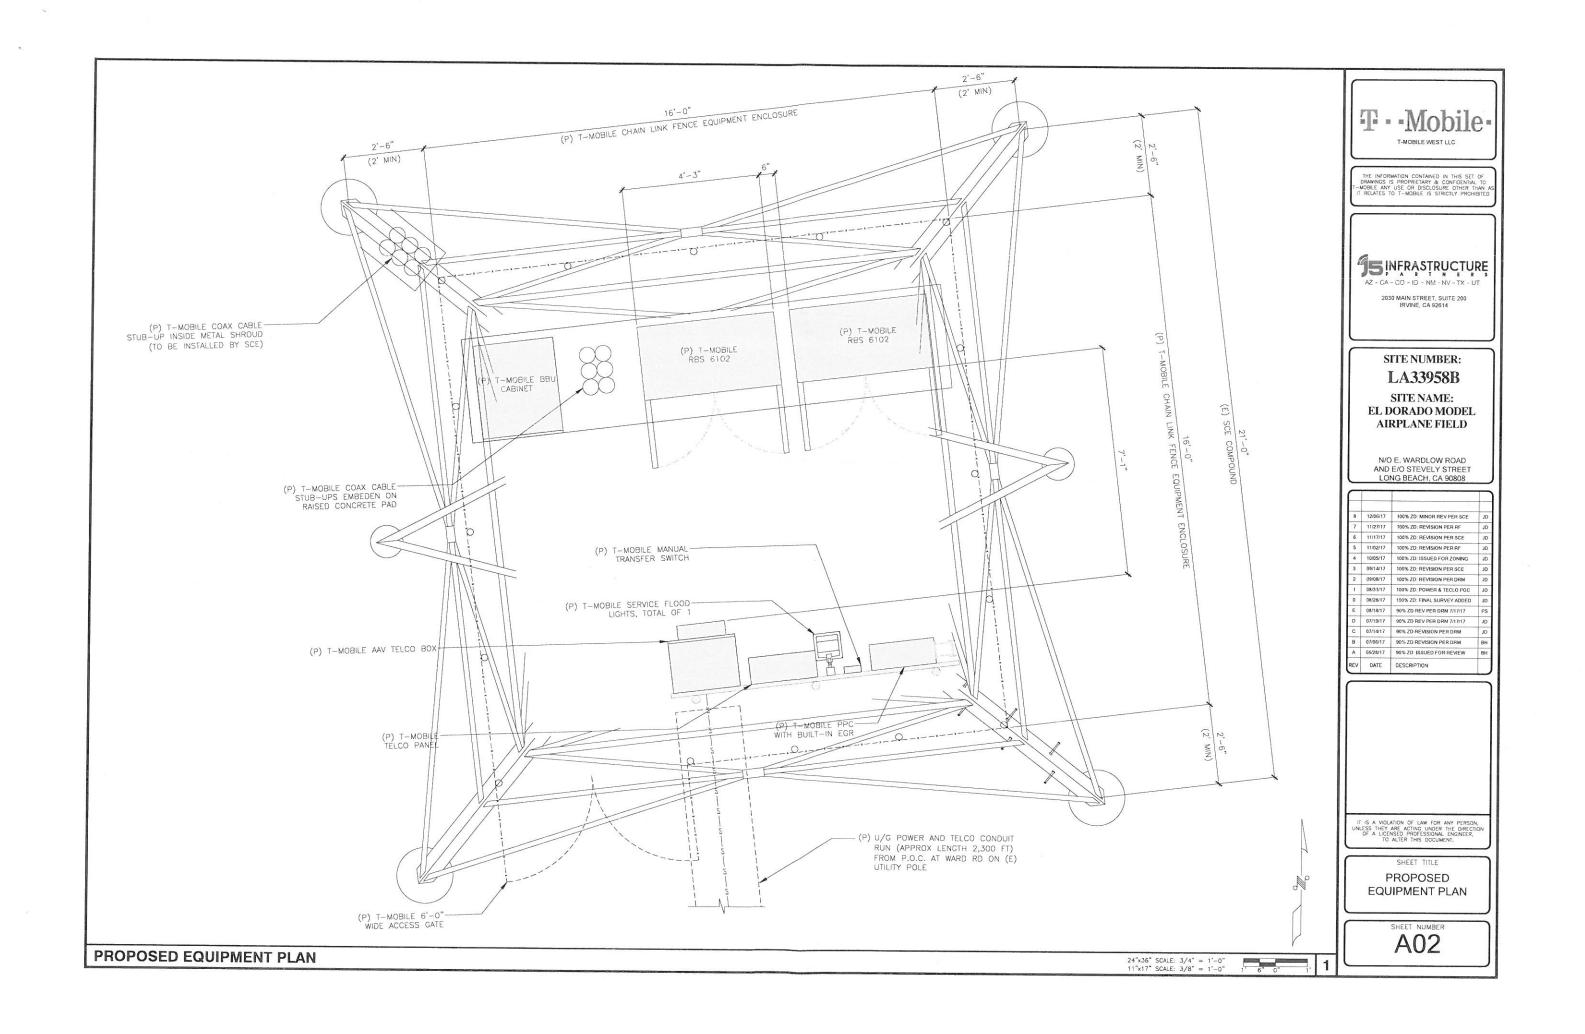				000 000 000 000 000 000 000 000 000 00	PRO	POSED RF	SCHEDULE				VIS-37/2-037
SEC	CTOR		ANT	ENNA				RAD	TMA /	CABLE	CARLE
		MANUFACTURER	MODEL	TECHNOLOGY	HEIGHT WEIGHT		AZIMUTH	CENTER	RRU	TYPE	CABLE
	A1	ERICSSON	AIR32 B66Aa/B2a	L2100 / L1900 U1900	56.6"	132.2 LBS.	0.	51'-0"		(6) FIBER JUMPER	
ALPHA	A2	COMMSCOPE	DBXNH-6565B-A2M	` L700	72.7"	46.3 LBS.	0,	51'-0"	RRUS 11 B12	(1) 6x12 HCS 6AWG DC CONDUCTOR	±100'
ALP	А3	ERICSSON	RRUS-11 B2	L700	19.6"	50.7 LBS.	0.	51'-0"			
,	A4	COMMSCOPE	DBXNH-6565B-A2M	L700	72.9"	33.1 LBS.	0*	51'-0"	DIPLEXER + RADIO 4478		
	B1	ERICSSON	AIR32 B66Aa/B2a	L2100 / L1900 U1900	56.6"	132.2 LBS.	135*	51'-0"		(6) FIBER JUMPER (1) 6x12 HCS 6AWG DC CONDUCTOR	
ETA	B2	COMMSCOPE	DBXNH-6565B-A2M	L700	72.7"	46.3 LBS.	135	51'-0"	RRUS 11 B12		±100'
BE	В3	ERICSSON	RRUS-11 B2	L700	19.6"	50.7 LBS.	135*	51'-0"			
	B4	COMMSCOPE	DBXNH-6565B-A2M	L700	72.9"	33.1 LBS.	135	51'-0"	DIPLEXER + RADIO 4478		
	C1	ERICSSON	AIR32 B66Aa/B2a	L2100 / L1900 U1900	56.6"	132.2 LBS.	245	51'-0"		(6) FIBER JUMPER	±100'
MA	C2	COMMSCOPE	DBXNH-6565B-A2M	L700	72.7"	46.3 LBS.	245	51'-0"	RRUS 11 B12	(1) 6x12 HCS 6AWG DC CONDUCTOR	
CAMMA	С3	ERICSSON	RRUS-11 B2	L700	19.6"	50.7 LBS.	245*	51'-0"			
	C4	COMMSCOPE	DBXNH-6565B-A2M	L700	72.9"	33.1 LBS.	245	51'-0"	DIPLEXER + RADIO 4478		
М	w	COMMSCOPE	VHLP2-13-2WH/B	MICROWAVE ANTENNA	-	23.8 LBS.	TBD	45'-0"		1/2" CABLE JUMPERS	

NOTES:

1. ALL ANTENNA ARRAYS MUST HAVE 1'-0" MINIMUM CLEARANCE FROM TOWER STEEL.

2. LEASE AREA FENCING & EQUIPMENT SHALL KEEP MIN. 2'-0" CLEARANCE FROM ALL TOWER STEEL.





2030 MAIN STREET, SUITE 200 IRVINE, CA 92614

SITE NUMBER: LA33958B

SITE NAME: EL DORADO MODEL AIRPLANE FIELD


N/O E. WARDLOW ROAD AND E/O STEVELY STREET LONG BEACH, CA 90808


8	12/06/17	100% ZD: MINOR REV PER SCE	1
7	11/27/17	100% ZD: REVISION PER RF	1.
6	11/17/17	100% ZD: REVISION PER SCE	1
5	11/02/17	100% ZD: REVISION PER RF	1
4	10/05/17	100% ZD: ISSUED FOR ZONING	J
3	09/14/17	100% ZD: REVISION PER SCE	J
2	09/08/17	100% ZD: REVISION PER DRM	1
1	08/31/17	100% ZD: POWER & TECLO POC	1
0	08/28/17	100% ZD: FINAL SURVEY ADDED	J
Е	08/18/17	90% ZD REV PER DRM 7/17/17	F
D	07/19/17	90% ZD REV PER DRM 7/17/17	J
С	07/14/17	90% ZD REVISION PER DRM	1
В	07/06/17	90% ZD REVISION PER DRM	В
Α	06/28/17	90% ZD ISSUED FOR REVIEW	В
REV	DATE	DESCRIPTION	T


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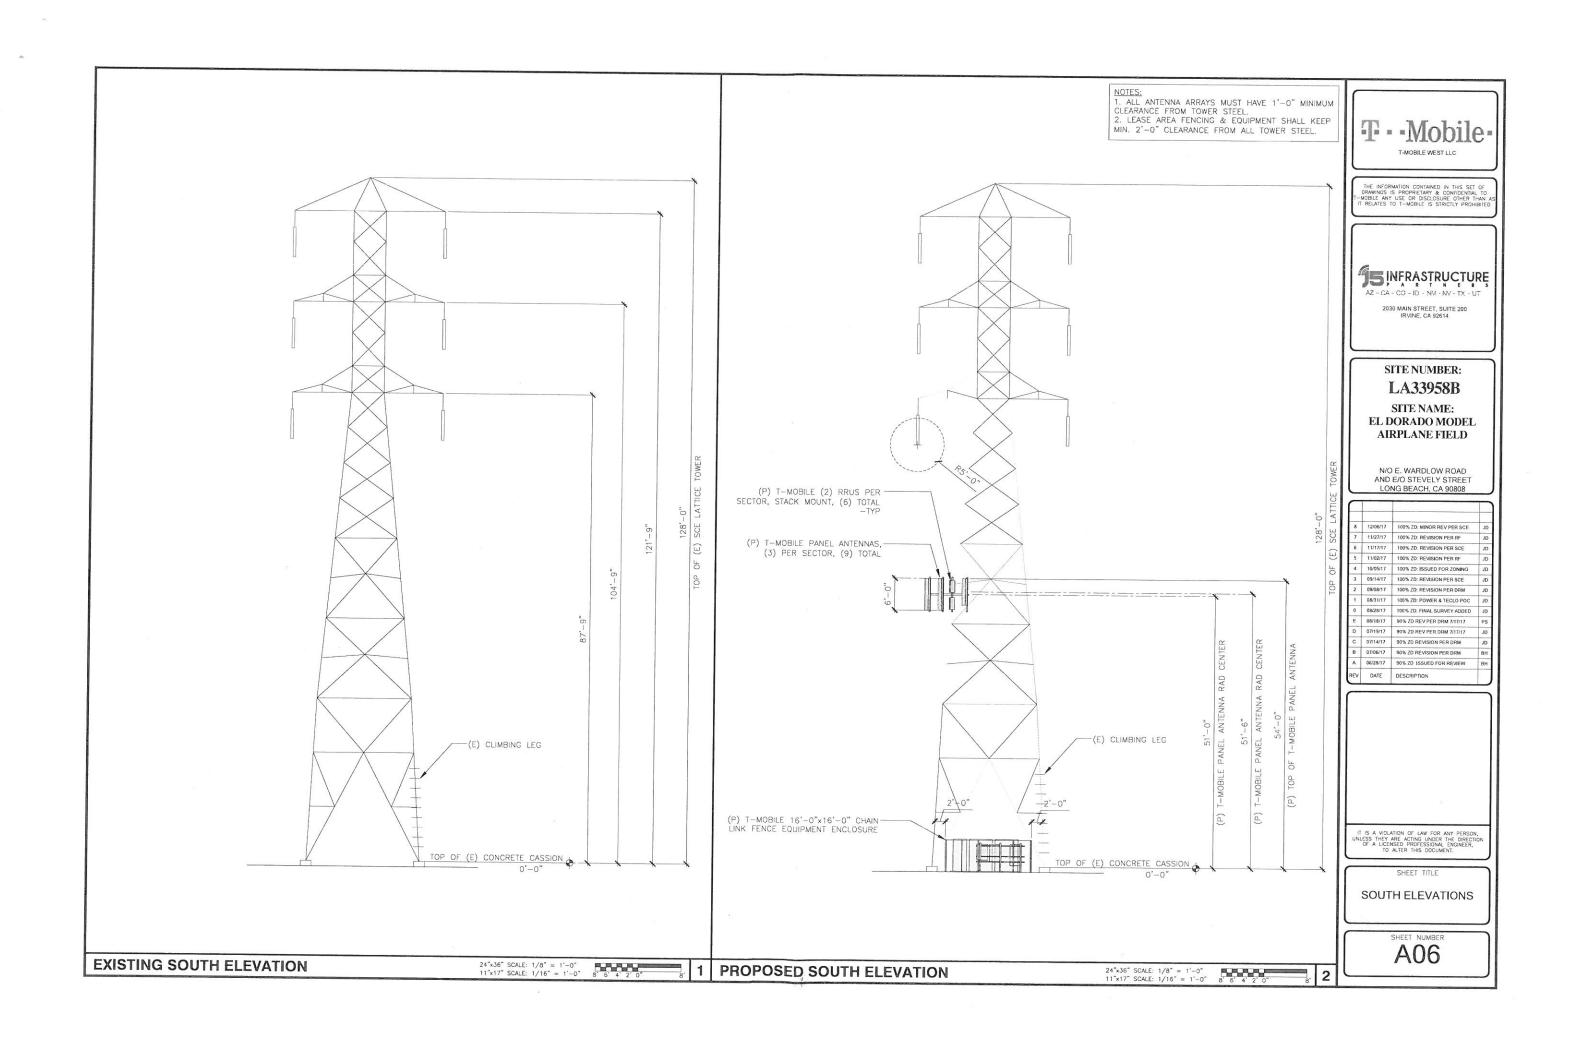
PROPOSED ANTENNA PLAN


A03



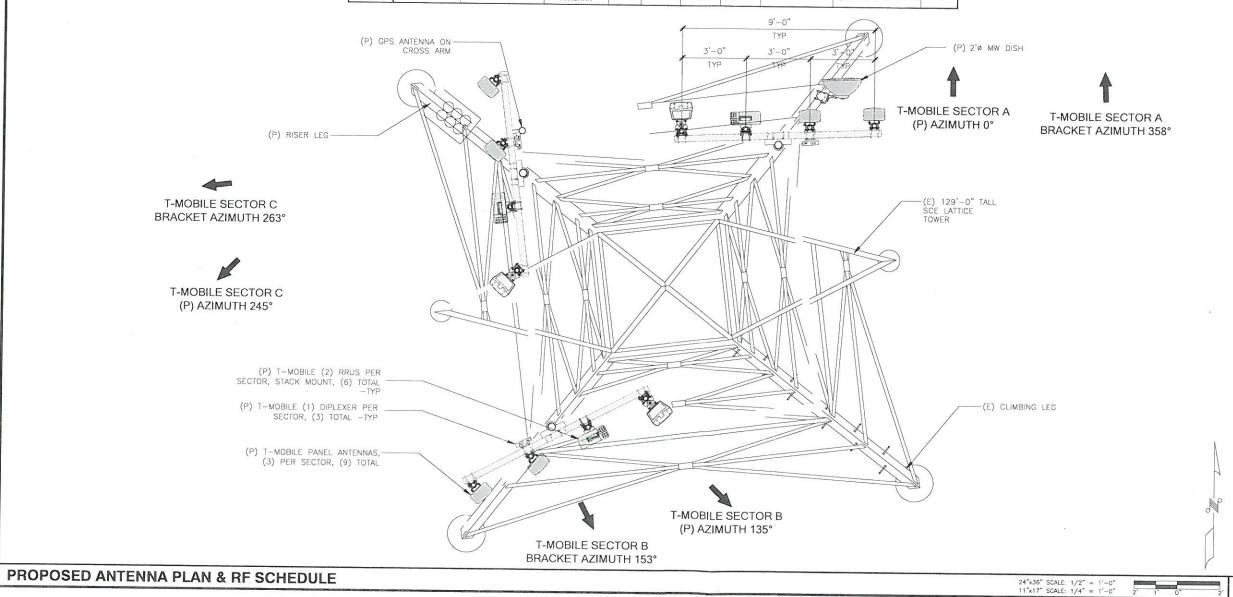

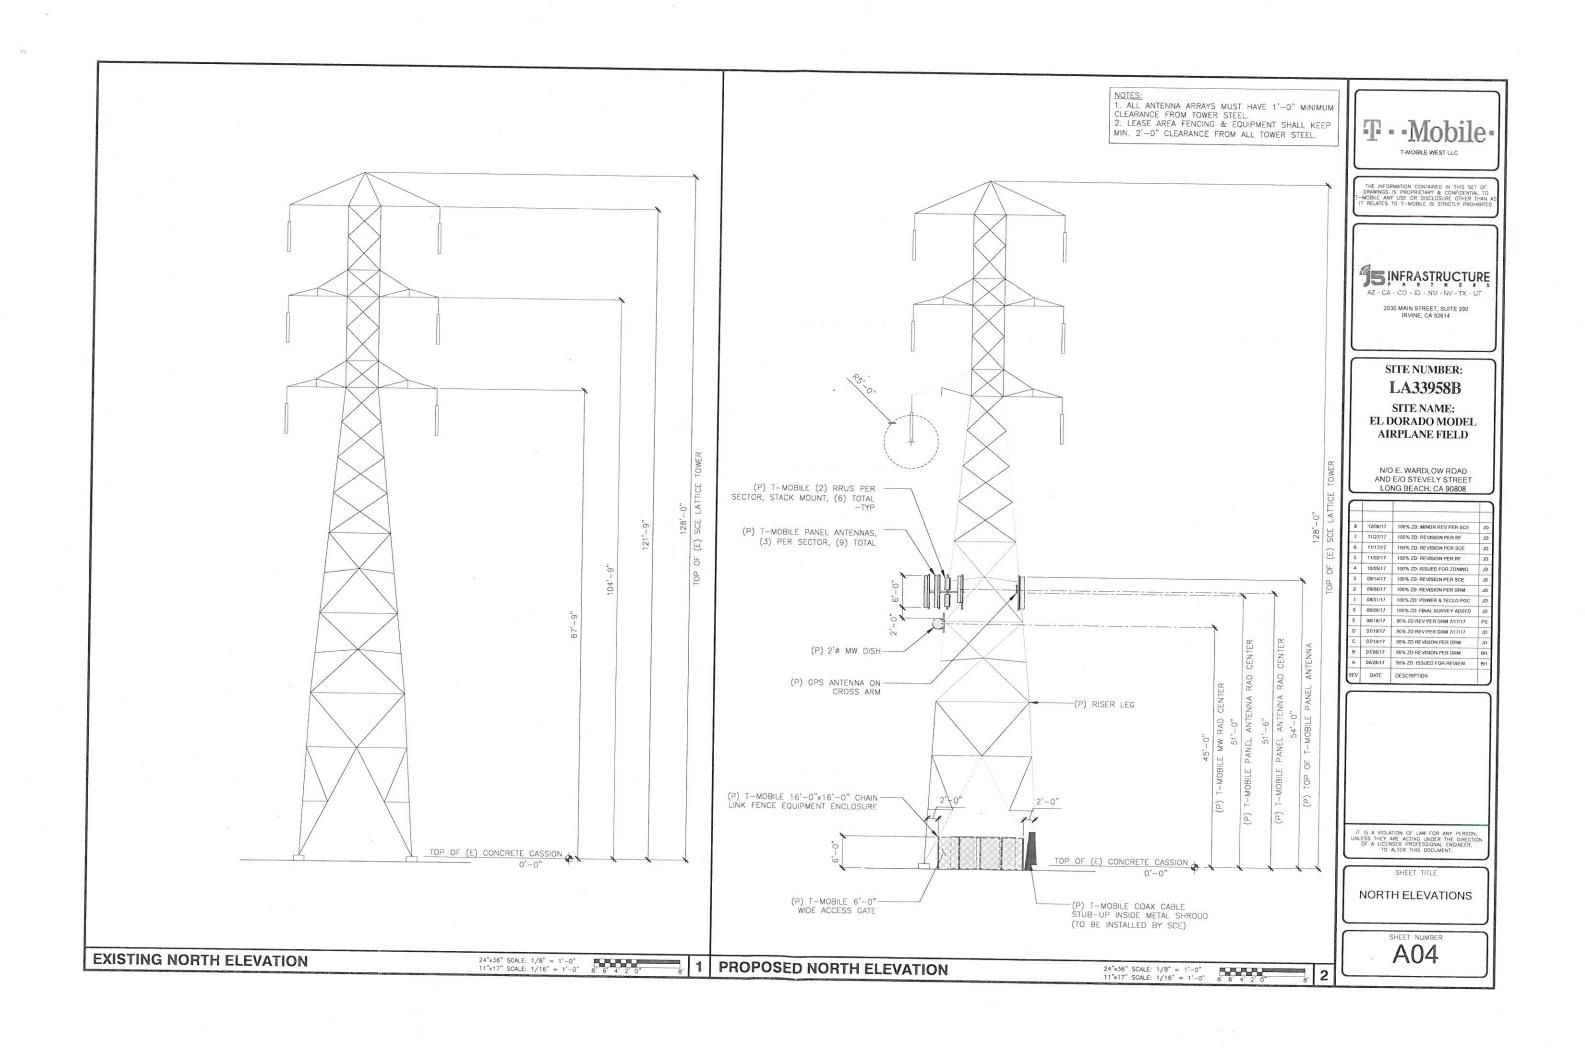

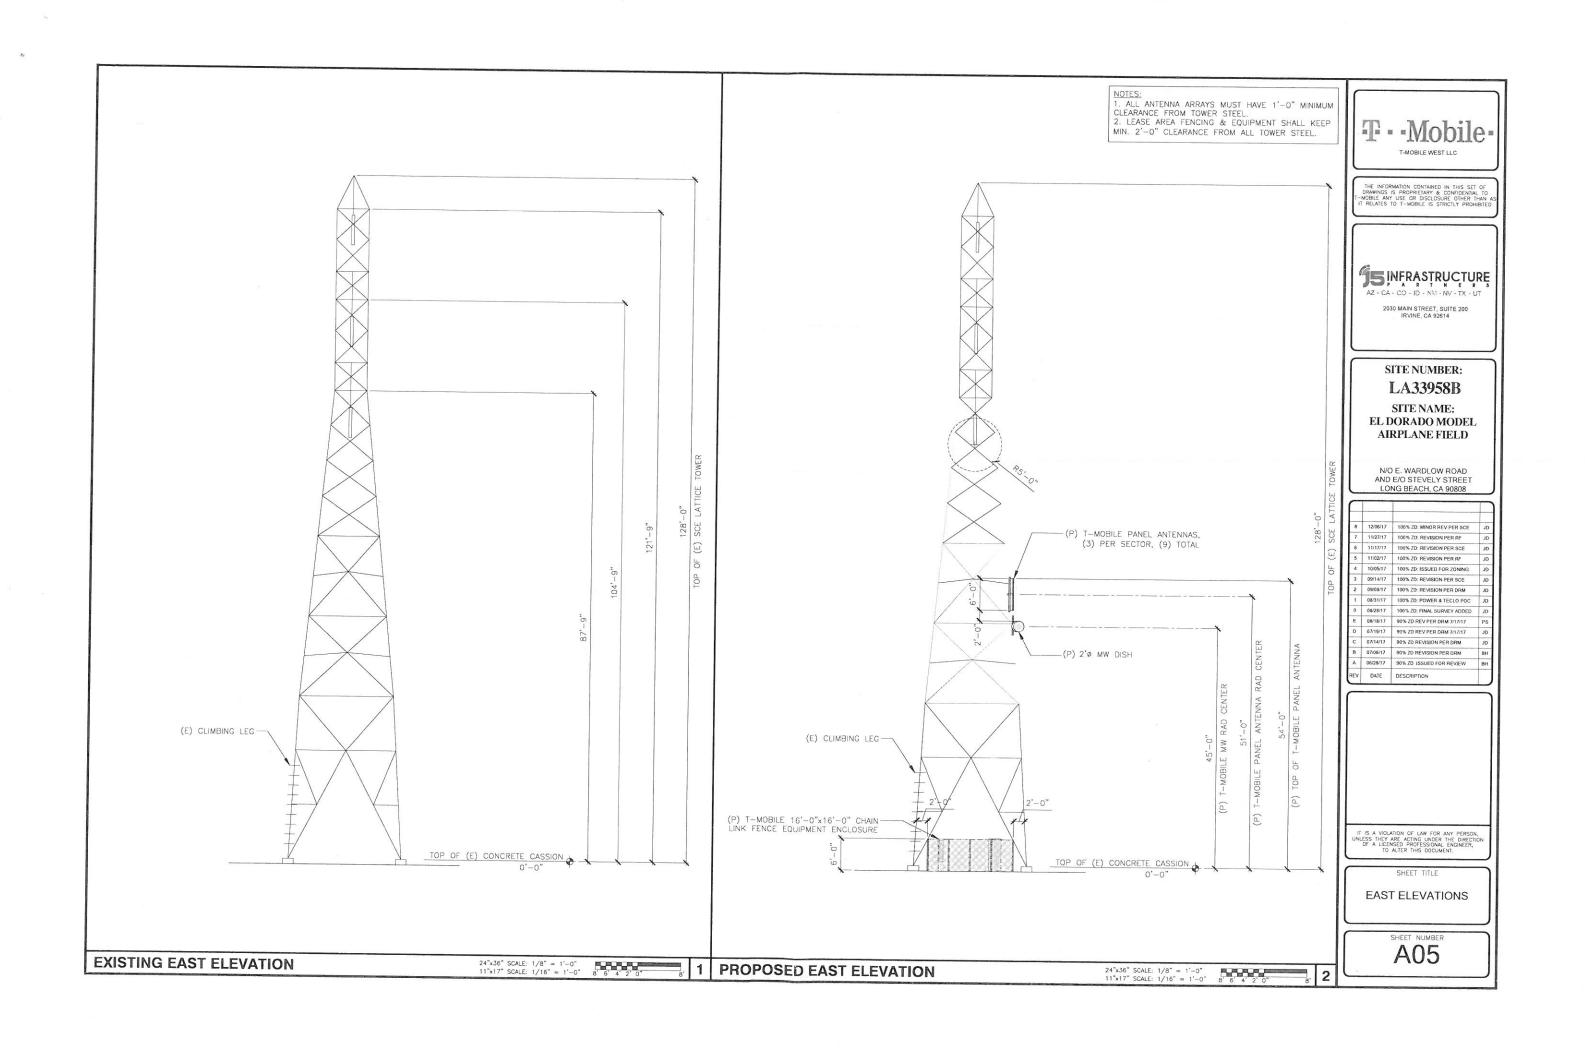

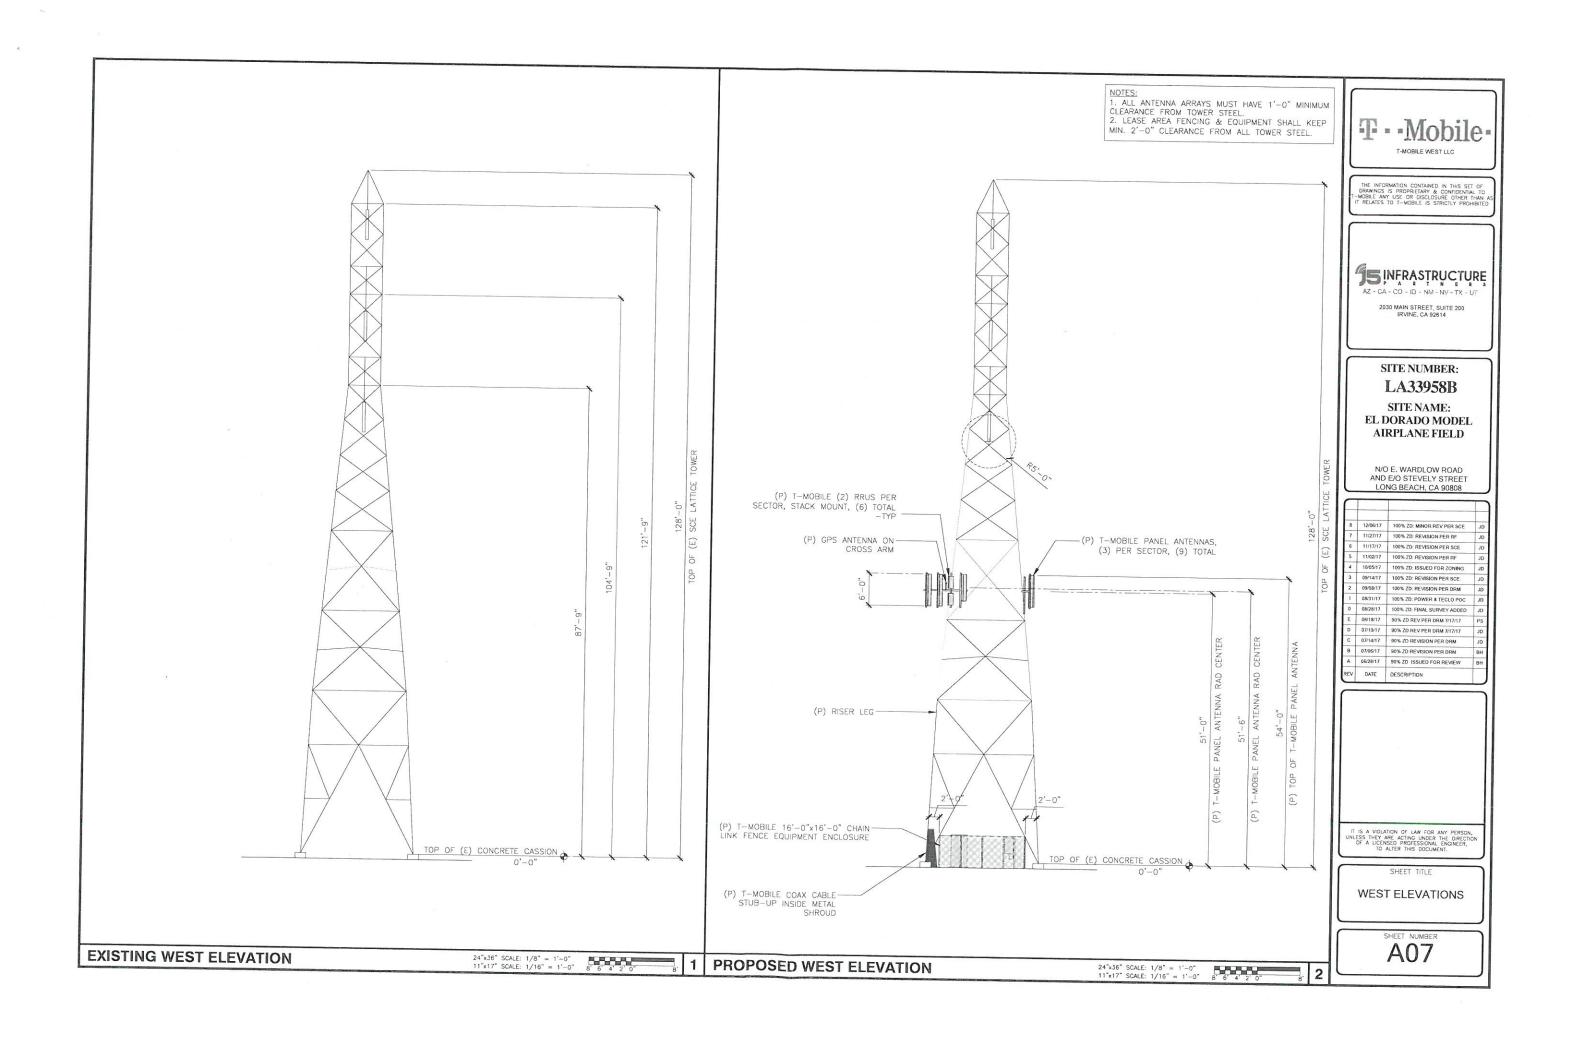


Ericsson Commercial In Confidence



HCS 6 X 12


ERICSSON HYBRID CABLE, 6 DC PAIRS + 12 OPTICAL PAIRS **UL APPROVED**

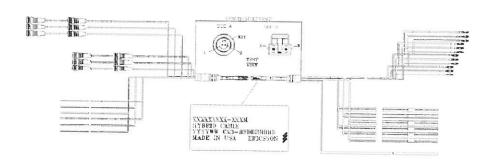


6 x 12 Weight and diameter		
	6 AWG DC wires	4 AWG DC wires
Weight (kg/m)	2.5 (+/- 0.1)	3.6 (+/- 0.1)
Weight (lb/ft)	1.7 (+/- 0.1)	2.4 (+/-0.1)
Diameter (mm)	35 (+/- 2.0 mm)	42 (+/- 2.0 mm)
Diameter (in)	1.38 (+/- 0.1")	1.66 (+/- 0.1")
Coax standard diameter equivalent	1.3/8"	1 5/8"

ERICSSON 6AWG 6X12 HCS CABLE 24"x36" SCALE: NTS 11"x17" SCALE: NTS


24"x36" SCALE: NTS 11"x17" SCALE: NTS

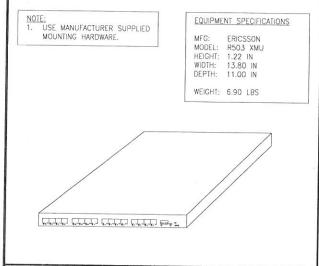

XMU SPECIFICATIONS

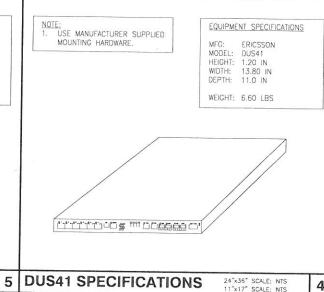

Mechanical	AIR21	AIR32 Single Band (SB)	AIR32 Dual Band (DB)
	B4a B2p	B4a B2p	B66Aa B2a
Weight (without mounting brackets)	41 Kg (=90.4 lbs)	48 Kg (=105.8 lbs)	60 Kg (=132.2 lbs)
Dimensions	1427 x 307 x 200 mm	1439 x 327 x 220 mm	1439 x 327 x 220 nun
(HxWxD)	(=56.2″x 12 1″x 7.9″)	(=56.6"x 12.9" x 8.7")	(=56.6″x 12.9" x 8.7")
Frontal Wind load @ 150 km/h (=42 m/s) wind speed	580 N	650 N	650 N

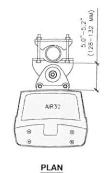


NOTES:
1. INSTALL ANTENNA TO EXISTING PIPE MAST USING MANUFACTURERS SUPPLIED BRACKETS AND MOUNTING HARDWARE

2. SET MECHANICAL DOWNTILT TO VALUE SPECIFIED IN LATEST RFDS

AIR32 SPECIFICATION AND MOUNTING DETAIL

TYPE NO.	85010070
NAME	AIR CLAMP KIT 55-115 MM
STATUS	BESTELLT
VIEW	
SUITABLE FOR MAST DIAMETER	55-115 MM
ANTENNA - WAST DISTANCE F	128-132 MM
NUMBER OF PIECES	2 PIECES
MATERIAL - CLAMP	HOT-DIP GALVANIZED STEEL
-SCREWS	HOT-DIP GALVANIZED STEEL /STAINLESS STEEL
-NUTS	STAINLESS STEEL
TYPE NO.	4,3 KG

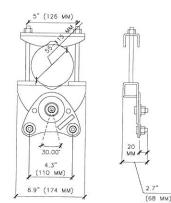

T - Mobile

15 INFRASTRUCTURE

2030 MAIN STREET, SUITE 200 IRVINE, CA 92614

SITE NUMBER: LA33958B

SITE NAME: EL DORADO MODEL AIRPLANE FIELD

N/O E. WARDLOW ROAD AND E/O STEVELY STREET

- 1				_
T	8	12/06/17		
_		5.00.000.55	100% ZD: MINOR REV PER SCE	JE
- 1	7	11/27/17	100% ZD: REVISION PER RF	JE
- 1	6	11/17/17	100% ZD: REVISION PER SCE	JD
- 1	5	11/02/17	100% ZD: REVISION PER RF	JD
	4	10/05/17	100% ZD: ISSUED FOR ZONING	JD
- 1	3	09/14/17	100% ZD: REVISION PER SCE	JD
ł	2	09/08/17	100% ZD: REVISION PER DRM	JD
	1	08/31/17	100% ZD: POWER & TECLO POC	JD
	0	08/28/17	100% ZD: FINAL SURVEY ADDED	JD
- [E	08/18/17	90% ZD REV PER DRM 7/17/17	PS
- 1	D	07/19/17	90% ZD REV PER DRM 7/17/17	JD
1	С	07/14/17	90% ZD REVISION PER DRM	JD
ı	В	07/06/17	90% ZD REVISION PER DRM	ВН
	A	06/28/17	90% ZD ISSUED FOR REVIEW	ВН
- 1	REV	DATE	DESCRIPTION	

24"x36" SCALE: NTS 11"x17" SCALE: NTS MECHANICAL DOWNTILT BRACKET ATTACHED LEAD TO PIPE USING 2-HOLE LUG BOTTOM VIEW FRONT SIDE PERSPECTIVE

2-PORT ANTENNA INFORMATION: MANUFACTURER: COMMSCOPE MODEL NO .: LNX-6514DS-A1M DIMENSIONS (H x W x D): 72.9" x 11.9" x 7.1" WEIGHT: 31.3 LBS

3

NOTES:

1. INSTALL ANTENNA TO EXISTING PIPE MAST USING MANUFACTURERS SUPPLIED BRACKETS AND MOUNTING HARDWARE

2. SET MECHANICAL DOWNTILT TO TO VALUE SPECIFIED IN LATEST RFDS

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DETAILS

SHEET NUMBER D01

LNX-6514DS-AIM ANTENNA SPECIFICATIONS

24"x36" SCALE: NTS 11"x17" SCALE: NTS

Product Specifications

COMMSOUPE"

T-MOBILE RF TO FINALIZE MW DISH MODEL# AND AZIMUTH



VHP2-13-2WH/B
0.6 m | 2 ft Valutine® High Performance Low Profile Antenna, single-polarized,
12-700-13-250 GHz, PBR120 flamps, white antenna, composite broadband gray
radone without flash, compact pack—one piece reflector.

Product Type

General Specifications

VHLP - Valutine (): High Performance Law Profile Antenna, single-polarized 0.5 m | 2 ft Antenna Type Diameter, nominal Compact pack
Gray
Composite B tradband Packing Padome Color Radome Material Reflector Construction One-piece reflector Antenna Inout

Antenna Color Antenna Type VHLP - ValuEinest High Performance Low Profile Antenna, single-pularized

Crameter, nominal Flash Included Single Polarization

Electrical Specifications

Operating Preguency Band Beamwidth, Horizontal Beamwidth, Vertical 13.700 - 13.250 GHz

Cross Polarization Discri 30 dB Drazil Anabel Class 2 | Canada SRSP 312.7 Part B | ETSI 302 217 Class 3 Electrical Compliance Front-to-Back Ratio

Gain, Low Band Gain, Mid Band Gain, Top Band 36.2.38 Operating Frequency Band 12,700 - 13,250 GH-17.7 d6 VSWR

Mechanical Specifications

Fine Azimuth Adjustment

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Product Specifications

COMMSCOPE"

Mounting Pipe Diamete 50 mm-120 mm | 2.0 in-4.7 in Net Weight Side Struts, Included Side Struts, Optional

Wind Velocity Cherational Wind Velocity Survival Pating 250 km/h | 155 mph

Wind Forces At Wind Velocity Survival Rating Axial Force (FA) 1290 N | 290 lbf 639 N | 144 lbf 295 N•m Side Force (FS) Twisting Moment (MT)
Weight with 1/2 in (12 mm) Radial Ice 21 kg | 46 lb 105 mm | 4 ln 74 mm | 3 in


Zog with 1/2 in (12 mm) Radial Ice

Packed Dimensions 354.0 mm | 13.9 ln 730.0 mm | 28.7 ln Length Volume Width 0.2 m³ 695.0 mm | 27.4 m


Product Specifications

Antenna Dimensions And Mounting Information

Deneration in factors (mm)					
Airenna size, it (m)	A	8	C	D	E
2 (0.6)	26 (600)	11.9 (307)	9.9 (252)	1.8 (45)	11.4 (289)

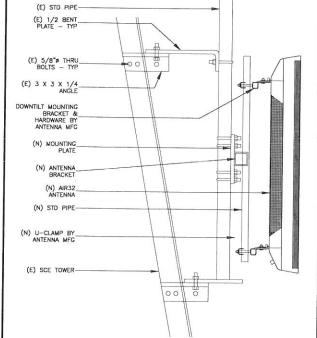

ANT

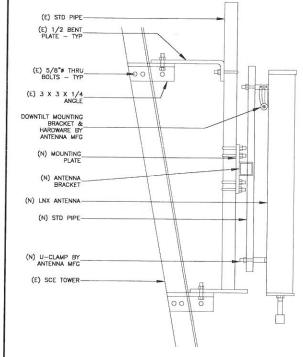





2030 MAIN STREET, SUITE 200 IRVINE, CA 92614


SITE NUMBER: LA33958B


SITE NAME: EL DORADO MODEL AIRPLANE FIELD

N/O E. WARDLOW ROAD AND E/O STEVELY STREET LONG BEACH, CA 90808

ENNA MOUNTING DETAIL (PROVIDED BY SCE)			24"x36" SCALE: NTS 11"x17" SCALE: NTS	1
MANUFACTURER: MODEL NO.: DIMENSIONS (HXWXD): WEIGHT (WITHOUT MOUNTING):	ERICSSON RRUS 11 B12 500mm (19.6") X 431mm (16.9") X 182 (7.16")		431	

Description

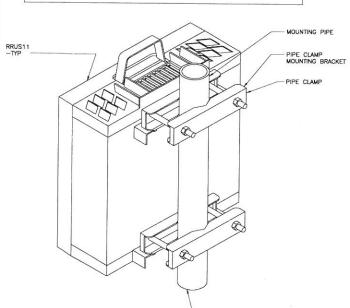

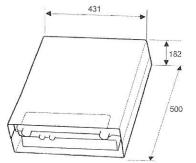

Value

24"x36" SCALE: NTS 11"x17" SCALE: NTS

Maximum nominal output power	2x10 W, 2x20 W, 2x30 W, 2x40 W ⁽¹⁾ (subject to license handling)
Number of carriers	One to four carriers (subject to license handling)
Description	Value
Dimensions with Solar Shield and	d Handle
Height	500 mm
Width	431 mm
Depth	182 mm
Weight	
RRUS 11	23 kg
Calor	
Gray	

- 1	REV	DATE	DESCRIPTION	
- 1	Α	06/28/17	90% ZD ISSUED FOR REVIEW	Bi
- 1	В	07/06/17	90% ZD REVISION PER DRM	Bł
- 1	С	07/14/17	90% ZD REVISION PER DRM	JE
- 1	D	07/19/17	90% ZD REV PER DRM 7/17/17	JE
- 1	E	08/18/17	90% ZD REV PER DRM 7/17/17	PS
- 1	0	08/28/17	100% ZD: FINAL SURVEY ADDED	JE
- 1	1	08/31/17	100% ZD: POWER & TECLO POC	J
ı	2	09/08/17	100% ZD: REVISION PER DRM	JE
- 1	3	09/14/17	100% ZD: REVISION PER SCE	JI
1	4	10/05/17	100% ZD: ISSUED FOR ZONING	JI
	5	11/02/17	100% ZD: REVISION PER RF	Ji
1	6	11/17/17	100% ZD: REVISION PER SCE	J
- 1	7	11/27/17	100% ZD: REVISION PER RF	JI
_	8	12/06/17	100% ZD: MINOR REV PER SCE	JI
√		(2)		+
				_

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DETAILS


D02

2' Ø MICROWAVE DISH

24"x36" SCALE: NTS 11"x17" SCALE: NTS

COMMSCOPE"

4 | RRUS 11 B12 SPECIFICATION AND DETAIL

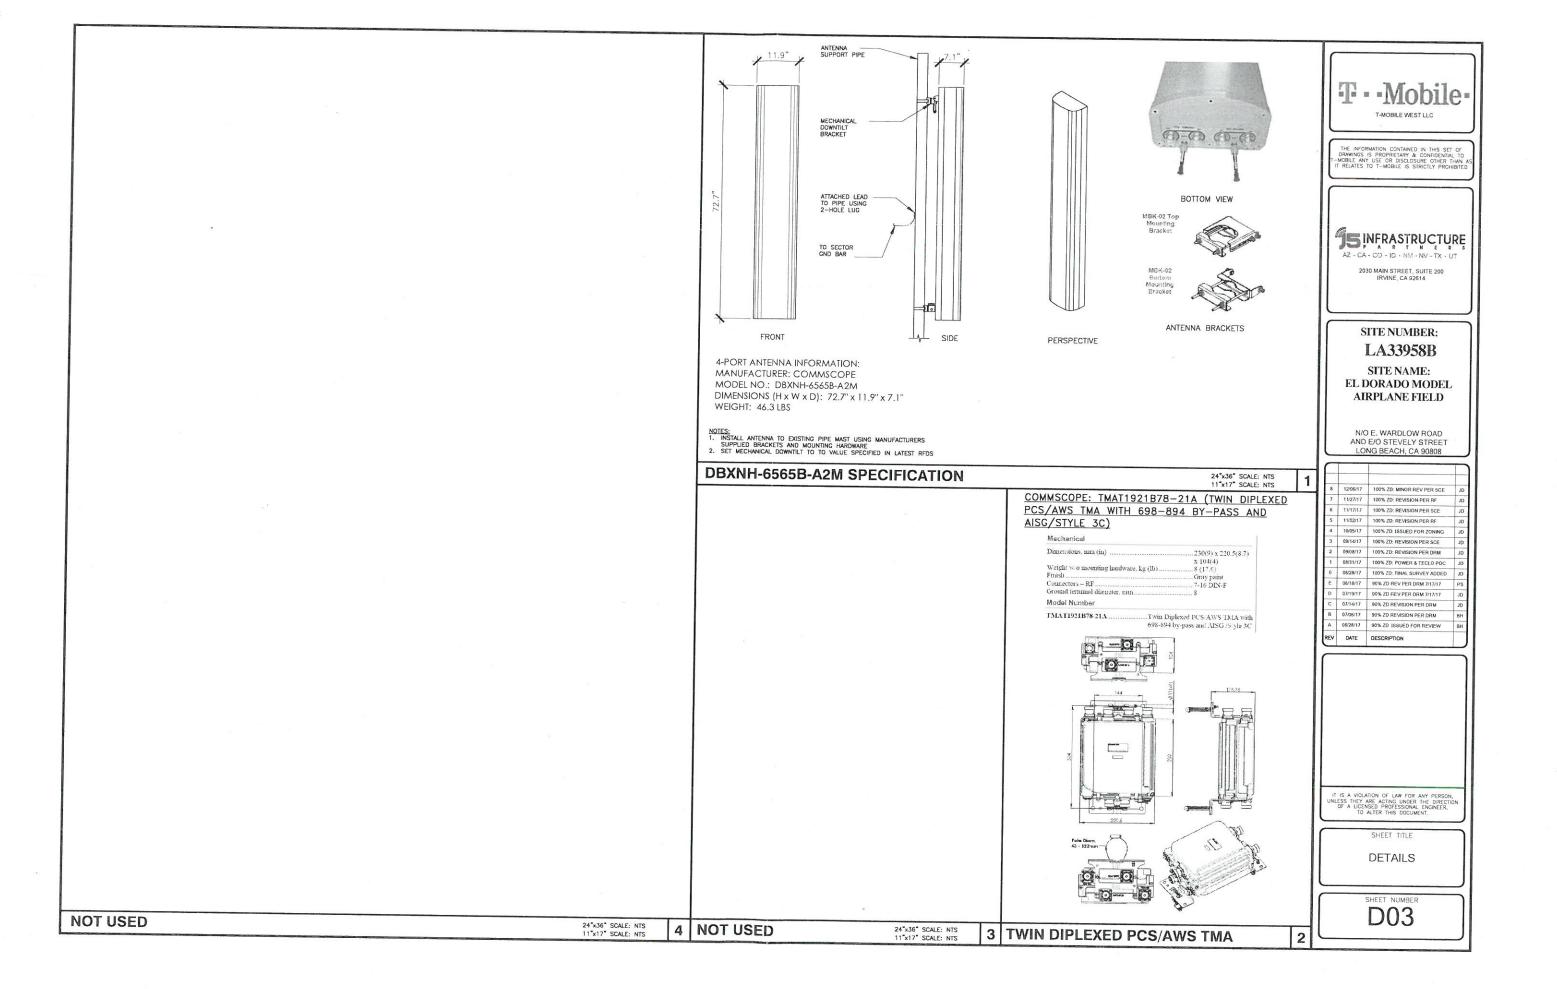


T - Mobile


LA33958B EL DORADO MODEL AIRPLANE

CA 90808 FIELD N/O WARDLOW ROAD & E/O STEVELY AVENUE LONG BEACH





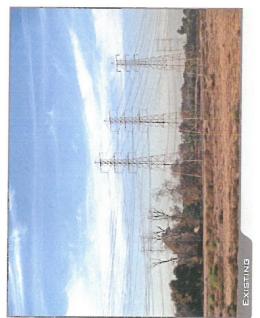

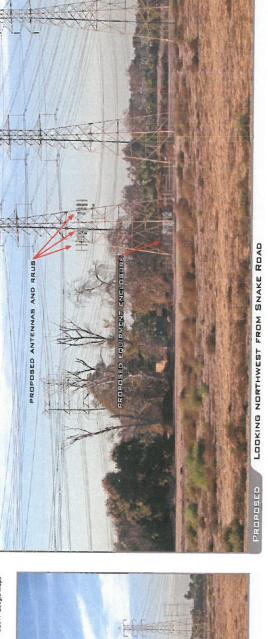





T - Mobile

LA33958B EL DORADO MOD

FIELD














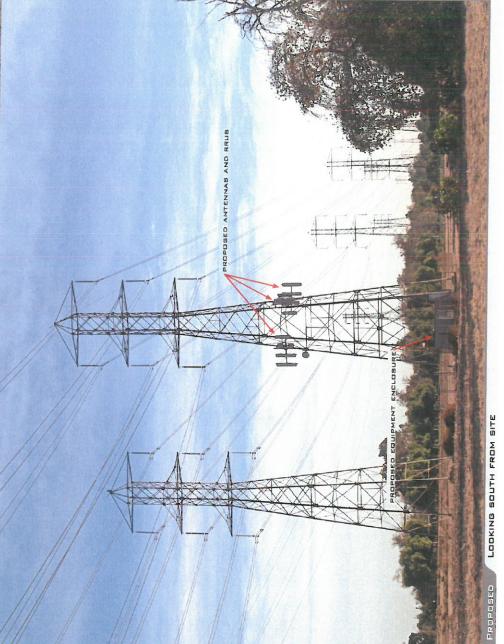



LA33958B EL DORADO MODEL AIRPLANE FIELD N/O WARDLOW ROAD & E/O STEVELY AVENUE LONG BEACH

CA 90808











