



6227-6245 DE FOREST AVENUE LONG BEACH CA 90805
















90808 LONG BEACH 6227-6245 DE FOREST AVENUE



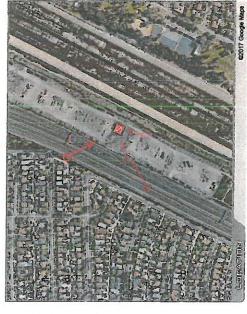













LA74664B HINSON-LIGHTHIPE ZZOKV


90805 6227-6245 DE FOREST AVENUE LONG BEACH CA





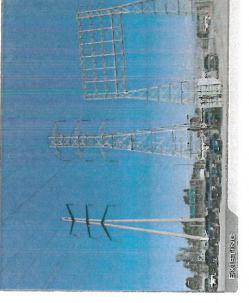

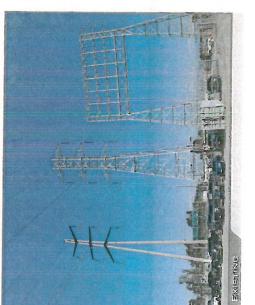

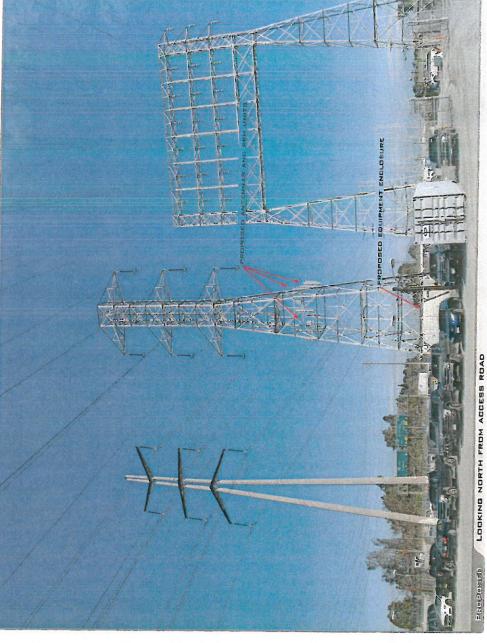

T. "Mobile"


ARTISTIC engineering AEsims.com 877.9AE.sims


90808 6227-6245 DE FOREST AVENUE LONG BEAGH







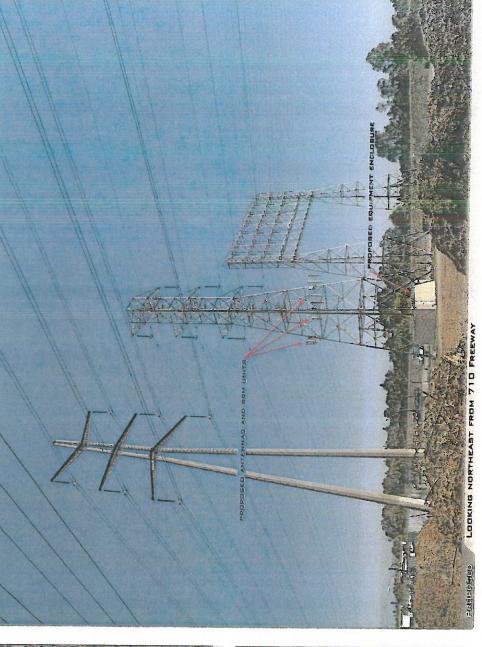

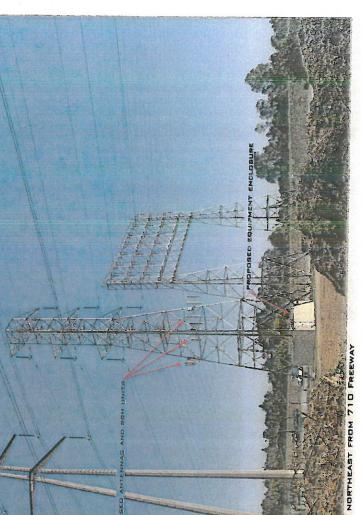

SITE NUMBER: LA74664B



UNDERGROUND SERVICE ALERT OF SOUTHERN CALIFORNIA 800-227-2600

48 HOURS BEFORE YOU DIG

T - Mobile



INFRASTRUCTURE AZ - CA - CO - ID - NM - NV - TX - UT

(SCE TOWER #:M7-T5 YEAR BUILT: 1975)

6290 1/2 WHITE AVENUE, LONG BEACH, CA 90805

SITE NAME: HINSON-LIGHTHIPE 220kV

NCI	B SCOPE OF WORK: (REDS VE	RSION 9/22/17)	VICINITY MAP SHT DRAWING INDEX	REV	SITE NUMBER:
				TO1 TITLE SHEET	7	LA74664B
 SCOPE OF WORK: INSTA INSTALL (1) 18'-0" x 18' 	LLATION OF NEW TELECOMMUNICATION F	ACILITY CONSISTIN	NG OF THE FOLLOWING:	TO2 GENERAL NOTES, ABBREVIATIONS & SYMBOLS	7	
 INSTALL (1) BBU CABIN 	IET ON (1) (P) CONCRETE PAD			ST Eloran St Elo	7	SITE NAME: HINSON-LIGHTHIPE 2201
 INSTALL(1) GPS ANTEN 	ABINETS ON (1) (P) CONCRETE PAD NNA			LS-1 TOPOGRAPHIC SURVEY (FINAL) LS-2 TOPOGRAPHIC SURVEY (FINAL)	7	HINSON-LIGHTHIPE 2201
 INSTALL (1) H-FRAME INSTALL (1) TELCO CAB 				1 Bot St FBot	7	11
 INSTALL (1) PPC w/GEN INSTALL (1) CABLE SHR 				A02 PROPOSED EQUIPMENT PLAN	7	
	TENNA, (3) PER SECTOR, (3) SECTORS TOTAL ER SECTOR, (3) PER SECTOR TOTAL			A03 PROPOSED ANTENNA PLAN	7	6290 1/2 WHITE AVENUE, LONG BEACH, CA 90805
•				A04 NORTH ELEVATION	7	
SITE ADDRESS:	6290 1/2 WHITE AVENUE, LONG BEACH, CA 90805	APPLICANT:	T-MOBILE WEST CORPORATION 3257 E. GUASTI RD, SUITE 200	A05 EAST ELEVATION	7	
PROPERTY OWNER/LES	SOR: SOUTHERN CALIFORNIA EDISON		ONTARIO, CA 91761	e scen fit A06 SOUTH ELEVATION	7	7 03/23/18 100% ZD : UPDATE SITE ADDRESS
	2 INNOVATION WAY, 1ST FLOOR POMONA, CA 91768	CONTACT:	AMIEE WEEKS T-MOBILE WEST, LLC	A07 WEST ELEVATION	7	6 02/20/18 100% ZD : SCE REDLINES 5 01/24/18 100% ZD : SCE REDLINES
			Amiee.Weeks3@t-mobile.com	D01 DETAILS	7	4 12/08/17 100% ZD : SCE REDLINES 3 11/17/17 100% ZD : MINOR REDLINES
CONTACT PHONE:	(626) 695-5888	SITE ACQ / ZONING	JILLIANNE NEWCOMER J5 INFRASTRUCTURE PARTNERS	15t D02 DETAILS	7	2 10/24/17 100% ZD REVISION PER SCE #2
ZONING:	PUBLIC RIGHT-OF-WAY	CONTACT:	jnewcomer@j5ip.com (951) 382-2523	Deforms Face DO3 DETAILS	7	1 09/27/17 100% ZD REVISION PER RFDS 0 09/08/17 100% ZD ISSUED FOR ZONING
JURISDICTION:	CITY OF LONG BEACH	PROJECT	ERIC LITTLE	NIE		E 08/31/17 90% ZD REVISION PER SCE
SOMODIO HOM.	on or condition	MANAGER	J5 INFRASTRUCTURE PARTNERS elittle@j5ip.com	the transfer of the transfer o		D 07/18/17 90% ZD PRELIM SURVEY ADDED C 07/14/17 90% ZD REVISION PER DRM
LATITUDE:	33.86840000 N		(949) 842-7002	APPROVALS:		B 07/06/17 90% ZD REVISION PER DRM A 07/03/17 90% ZD ISSUED FOR REVIEW
LONGITUDE:	-118.19482223 W	ENGINEER	FRANCIS DONG J5 INFRASTRUCTURE PARTNERS	N SIGNATURE	DATE	REV DATE DESCRIPTION
APN:	7125-037-801		fdong@j5ip.com (949) 247-7767 x112	LAND OWNER: PRINT NAME		
CURRENT USE:	WIRELESS COMM. FACILITY		A CONTRACTOR OF THE CONTRACTOR	DEVELOP: MANAGER:		11
PROPOSED USE:	WIRELESS COMM. FACILITY	A&E MANAGE	JOHNAR DE LA CRUZ J5 INFRASTRUCTURE PARTNERS	CONST. MANAGER		11
ACCESSIBILITY	THE FACILITY IS UNMANNED		jdelacruz@j5ip.com (714) 902-3051	PROJECT MANAGER:		
REQUIREMENTS:	AND NOT FOR CONTINUOUS HUMAN HABITATION.	RF ENGINEER:		ZONING MANAGER:		
	DISABLED/CHALLENGED ACCESS IS NOT REQUIRED PER	DISABLED/CHALLENGED T-MOBILE	T-MOBILE Christopher.Gamboa7@T-mobile.com	TMO RF ENGINEER:		
	CBC 2016, SECTION 11B-203.4 (LIMITED ACCESS SPACE)		N MATT TRIBBETT	SAC. REP:		
	(2257.002.00 01.1.02)	MANAGER:	VANTAGE COMPANY (951) 897-5601	E CONST. MANAGER		
	3.5		matthew.tribett@vantagecompany.com	NETWORK OPS:		IT IS A MOLATION OF LAW FOR AN OFFICE
	STATE	MENTS		GENERAL CONTRACTOR NOTES CODE COMPLIANCE		IT IS A VIOLATION OF LAW FOR ANY PERSON UNLESS THEY ARE ACTING UNDER THE DIRECT OF A LICENSED PROFESSIONAL ENGINEER, TO ALTER THIS DOCUMENT.
STRUCTURAL: STRUCTURAL ANALYSIS IS NOT WITHIN THE SCOPE OF WORK CONTAINED IN THIS DRAWINGS SET. FOR ANALYSIS OF EXISTING AND/OR PROPOSED COMPONENTS, REFER TO STRUCTURAL ANALYSIS PROVIDED UNDER SEPARATE COVER. ANTENNA MOUNT ANALYSIS IS NOT WITHIN THE SCOPE OF WORK CONTAINED IN THIS DRAWING SET. FOR ANALYSIS OF ANTENNA MOUNT TO SUPPORT EXISTING AND/OR PROPOSED COMPONENTS. REFER TO ANTENNA MOUNT STRUCTURAL ANALYSIS PROVIDED UNDER SEPARATE COVER. PROPRIETARY INFORMATION: THE INFORMATION CONTAINED WITHIN THIS SET OF DRAWINGS IS PROPRIETARY T-MOBILE. ANY USE OR DISCLOSURE OTHER THAN AS IT RELATES TO T-MOBILE IS STRICTLY PROHIBITED.			RUCTURAL ANALYSIS PROVIDED IN THIS DRAWING SET, FOR IMPONENTS, REFER TO ANTENNA TOF DRAWINGS IS PROPRIETARY	DO NOT SCALE DRAWINGS SUBCONTRACTOR SHALL VERIFY ALL PLANS & EXISTING DIMENSIONS & CONDITIONS ON THE JOB SITE & SHALL IMMEDIATELY NOTIFY THE ENGINEER IN WRITING OF ANY DISCREPANCIES BEFORE PROCEEDING WITH THE WORK OR BE RESPONSIBLE FOR SAME. PER CALIFORNIA BUILDING STANDARDS CODE, "TITLE 24 OF THE CALIFORNIA CO OF REGULATIONS" GOVERNS THE DESIGN AND CONSTRUCTION OF ALL BUILDING OCCUPANCIES AND ASSOCIATED FACILITIES AND EQUIPMENT THROUGHOUT SAILL WITH THE WORK OR BE RESPONSIBLE FOR SAME. 1. 2016 CALIFORNIA BUILDING CODE 2. 2016 CALIFORNIA ELECTRICAL CODE 3. 2016 CALIFORNIA HISTORICAL BUILDING CODE 4. 2016 CALIFORNIA FISTING BUILDING CODE 5. 2016 CALIFORNIA EXISTING BUILDING CODE 6. 2016 CALIFORNIA EXISTING BUILDING CODE 7. CITY/COUNTY ORDINANCES 8. ANS/ITIA-222-G-2009		SHEET TITLE TITLE SHEET SHEET NUMBER T01

- FOR THE PURPOSE OF THIS CONSTRUCTION DRAWING, THE FOLLOWING DEFINITIONS SHALL APPLY: CONTRACTOR — GENERAL CONTRACTOR (CONSTRUCTION) AND ANY LOWER TIER SUBCONTRACTORS. ENGINEER — J5 INFRASTRUCTURE PARTNERS OWNER — T—MOBILE WIRELESS
- 2. CONTRACTOR SHALL VISIT THE CELL SITE PRIOR TO THE SUBMISSION OF BIDS TO FAMILIARIZE WITH THE EXISTING CONDITIONS AND TO CONFIRM THAT THE WORK CAN BE ACCOMPLISHED AS SHOWN ON THE CONSTRUCTION DRAWINGS. ANY DISCREPANCY, CONFLICT, OR OMISSION FOUND SHALL BE BROUGHT TO THE ATTENTION OF THE ENGINEER FOR RESOLUTION, PRIOR TO BID SUBMISSION & PRIOR TO COMMENCEMENT OF ANY WORK. THE CONTRACTOR SHALL BE RESPONSIBLE FOR CORRECTION OF ANY ERRORS, OMISSIONS, OR DISCREPANCIES DISCOVERED AFTER THE COMMENCEMENT OF CONSTRUCTION WHICH HAVE NOT BEEN BROUGHT TO THE ATTENTION OF THE ENGINEER. ANY COSTS INCURRED TO REMEDY THE SITUATION SHALL BE AT THE EXPENSE OF THE CONTRACTOR. THE ENGINEER SHALL APPROVE ALL METHODS USED TO CORRECTION THE SITUATION.
- 3. ALL MATERIALS FURNISHED AND INSTALLED SHALL BE IN STRICT ACCORDANCE WITH ALL APPLICABLE CODES, REGULATIONS, AND ORDINANCES. CONTRACTOR SHALL ISSUE ALL APPROPRIATE NOTICES AND COMPLY WITH ALL LAWS, ORDINANCES, RULES, REGULATIONS, AND LAWFUL ORDERS OF ANY PUBLIC AUTHORITY REGARDING THE PERFORMANCE OF THE WORK.

ALL WORK CARRIED OUT SHALL COMPLY WITH ALL APPLICABLE MUNICIPAL AND UTILITY COMPANY SPECIFICATIONS AND LOCA JURISDICTIONAL CODES, ORDINANCES AND APPLICABLE REGULATIONS.

- THE CONTRACTOR SHALL INSTALL ALL EQUIPMENT AND MATERIALS IN ACCORDANCE WITH MANUFACTURER'S RECOMMENDATIONS UNLESS SPECIFICALLY STATED OTHERWISE.
- THE CONTRACTOR SHALL DETERMINE ACTUAL ROUTING OF CONDUITS AND OTHER CABLES. CONTRACTOR SHALL UTILIZE EXISTING TRAYS AND/OR SHALL ADD NEW TRAYS AS NECESSARY.
- THE CONTRACTOR SHALL PROTECT EXISTING IMPROVEMENTS, PAVEMENTS, CURBS, LANDSCAPING AND STRUCTURES. ANY DAMAGES SHALL BE REPAIRED AT CONTRACTOR'S EXPENSE TO THE SATISFACTION OF OWNER.
- CONTRACTOR SHALL LEGALLY AND PROPERLY DISPOSE OF ALL SCRAP MATERIALS SUCH AS COAXIAL CABLES AND OTHER
 ITEMS REMOVED FROM THE EXISTING FACILITY. ANTENNAS REMOVED SHALL BE RETURNED TO THE OWNER'S DESIGNATED
 LOCATION.
- 8. AT ANY TIME DURING THE DURATION OF CONSTRUCTION, THE CONTRACTOR SHALL BE RESPONSIBLE FOR THE SECURITY OF THE SITE. CONTRACTOR SHALL LEAVE PREMISES IN CLEAN CONDITION.
- AS MAY BE REQUIRED BY THE GOVERNING AGENCY OR PROPERTY OWNER, THE CONTRACTOR SHALL PROVIDE TEMPORARY POWER, WATER, OR TOILET FACILITIES.
- 10. THE EXISTING CELL SITE IS ASSUMED TO BE IN FULL COMMERCIAL OPERATION. ANY CONSTRUCTION WORK BY SUBCONTRACTOR SHALL NOT DISRUPT THE EXISTING NORMAL OPERATION. ANY WORK ON EXISTING EQUIPMENT MUST BE COORDINATED WITH THE OWNER. ALSO, WORK MAY NEED TO BE SCHEDULED FOR AN APPROPRIATE MAINTENANCE WINDOW USUALLY IN LOW TRAFFIC PERIODS AFTER MIDNIGHT.
- 11. THE CONTRACTOR SHALL COMPLY WITH ALL OSHA REGULATIONS DURING THE ENTIRE CONSTRUCTION PERIOD. SINCE THE CELL SITE MAY BE ACTIVE, ALL SAFETY PRECAUTIONS MUST BE TAKEN WHEN WORKING AROUND HIGH LEVELS OF ELECTROMAGNETIC RADIATION. EQUIPMENT SHOULD BE SHUTDOWN PRIOR TO PERFORMING ANY WORK THAT COULD EXPOSE THE WORKERS TO DANGER. PERSONAL RF EXPOSURE MONITORS ARE REQUIRED TO BE WORN TO ALERT OF ANY DANGEROUS EXPOSURE LEVELS.
- 12. THE CONTRACTOR SHALL NOT USE OR INSTALL ANY MATERIAL CONTAINING ASBESTOS OR LEAD PAINT CONTENT. THE USE OF SUCH MATERIAL IS STRICTLY PROHIBITED.
- 13. IT IS THE RESPONSIBILITY OF THE CONTRACTOR TO LOCATE ALL EXISTING UTILITIES, WHETHER OR NOT SHOWN ON PLANS, AND TO AVOID OR PROTECT THEM FROM ANY DAMAGE. ANY COSTS INCURRED TO REPAIR UTILITIES DAMAGED DURING CONSTRUCTION SHALL BE AT THE SOLE COST OF THE CONTRACTOR. TELEPHONE 811 FOR USA DIG ALERT.
- 14. THE GOVERNING AGENCY MAY REQUIRE A COPY OF THE APPROVED PLANS TO BE KEPT ON SITE AT ALL TIMES.

 THE CONTRACTOR SHALL MAKE SUCH A SET AVAILABLE FOR INSPECTION AT ALL TIMES. ANY DEVIATIONS FROM THE APPROVED SET SHALL BE DOCUMENTED AND PROVIDED TO THE ENGINEER FOR APPROVAL. THE CONTRACTOR SHALL BEAR THE SOLE COST TO CORRECT ANY INSTALLATION WHICH DEVIATES FROM APPROVED PLANS AND IS NOT ACCEPTED BY THE ENGINEER.
- 15. THE CONTRACTOR IS SOLELY RESPONSIBLE FOR ALL MEANS & METHODS, TECHNIQUES, SEQUENCING, AND PROCEDURES REQUIRED TO PERFORM THE WORK. ANY ANALYSIS OF THE STRUCTURE UNDER TEMPORARY CONSTRUCTION LOADING CONDITIONS IS OUTSIDE OF THE SCOPE OF THESE DRAWINGS. THE CONTRACTOR SHOULD EVENLY DISTRIBUTE ANY MATERIAL TO BE STORED ON SITE DURING CONSTRUCTION SO THAT THE LOAD DOES NOT EXCEED THE STRUCTURES DESIGNED LIVE LOAD; OR PROVIDE TEMPORARY SHORING OR BRACING IN THESE AREAS.
- 16. DRAWINGS ARE NOT TO BE SCALED. DIMENSIONS SHOWN TAKE PRECEDENCE OVER SCALE.
- 17. ALL NEW COMPONENTS ADD TO THE EXTERIOR OF THE STRUCTURE, WHICH ARE VISIBLE FROM PUBLIC VIEW, SHALL BE PAINTED TO MATCH THE EXISTING CONDITIONS.
- 18. ALL DETAILS AND NOTES INDICATED IN THESE PLANS ARE THE MINIMUM REQUIREMENTS.
- 19. IT MAY BE NECESSARY TO TEMPORARILY RELOCATE, REMOVE, REPLACE, OR WORK AROUND VARIOUS ARCHITECTURAL FEATURES, PIPES, FIXTURES, CABLING, OR OTHER NON-STRUCTURAL ITEMS IN ORDER TO COMPLETE THE PROPOSED WORK. CONTRACTOR SHALL RESTORE THESE ITEMS TO THEIR ORIGINAL CONDITION AT THEIR EXPENSE UNLESS OTHERWISE NOTED IN THESE PLANS.

		SYMBOLS				ABBREVIATIONS		
	S/G	SOLID GROUND BUS BAR		ND ROD WITH ACCESS	AGL	ABOVE GRADE LEVEL	(P)	PROPOSED
	S/N	SOLID NEUTRAL BUS BAR	(TEST	WELL)	(E)	EXISTING MINIMUM	EMT	ELECTRICAL METALLIC
ANY	θ.	SUPPLEMENTAL GROUND CONDUCTOR	—— G ——	GROUNDING WIRE, DASHED REPRESENTS UNDERGROUND	N.T.S.		01.10	TUBING
	Ğ.	2-POLE THERMAL-MAGNETIC CIRCUIT BREAKER	— т —	TELEPHONE LINE, DASHED	REF	REFERENCE	GND GPS	GROUND GLOBAL POSITIONING
S	0	SINGLE-POLE THERMAL-MAGNETIC	— с —	REPRESENTS UNDERGROUND	RF T.B.D.	RADIO FREQUENCY TO BE DETERMINED	GFS	SYSTEM
3	6	CIRCUIT BREAKER	C	COAXIAL CABLE, DASHED REPRESENTS UNDERGROUND	TYP	TYPICAL	GFCI	GROUND FAULT CIRCUIT
	Θ	XIT GROUND ROD (CHEMICAL)	—— A ——	ANTENNA COAX	EGR	EQUIPMENT GROUND RING	DTOW	
	\otimes	GROUND ROD	— OH/E —	OVERHEAD ELECTRICAL CABLES	AWG	AMERICAN WIRE GAUGE	BTCW	BARE TINNED COPPER WIRE
-		DISCONNECT SWITCH		CABLES				
CAL	M	UTILITY METER			MGB	MASTER GROUND BUS		
		EXOTHERMIC CONNECTION			EG	EQUIPMENT GROUND		į
	_	(CADWELD) TO GROUND RING AND COMPRESSION TO GROUND HALO			BCW GEN	BARE COPPER WIRE GENERATOR		
	•	COMPRESSION, CLAMP, OR DOUBLE HOLE LUG TYPE GROUND CONNECTION			IGR	INTERIOR GROUND RING (HALO)		
- 1								

T-Mobile

THE INFORMATION CONTAINED IN THIS SET OF DRAWINGS IS PROPRIETARY & CONFIDENTIAL TO IMMORE ANY USE OR DISCLOSURE OTHER THAN A IT RELATES TO T-MOBILE IS STRICTLY PROHIBITED

15 INFRASTRUCTURE

2030 MAIN STREET, SUITE 200 IRVINE, CA 92614

LEGEND

- 1. ALL GROUNDING WORK SHALL COMPLY WITH THE LATEST EDITION OF THE CALIFORNIA ELECTRICAL CODE, AS WELL AS WITH ALL LOCAL, STATE, AND NATIONAL CODES, LAWS, AND ORDINANCES APPLICABLE TO GROUNDING WORK.
- 2. EXOTHERMIC WELDS SHALL BE USED FOR ALL GROUNDING CONNECTIONS BELOW GRADE.
- 3. THE CONTRACTOR IS RESPONSIBLE FOR PROPERLY SEQUENCING GROUNDING AND UNDERGROUND CONDUIT INSTALLATION SO AS TO PREVENT ANY LOSS OF CONTINUITY IN THE GROUNDING SYSTEM OR DAMAGE TO THE CONDUIT.
- 4. ALL DETAILS ARE SHOWN IN GENERAL TERMS. ACTUAL GROUNDING INSTALLATION SHALL BE ACCORDING TO SPECIFIC SITE CONDITIONS.
- 5. GROUNDING CONDUCTORS SHALL BE #2 AWG SOLID BARE TINNED COPPER WIRE, UNLESS NOTED OTHERWISE.
- 6. APPROVED ANTIOXIDANT COATINGS (I.E., CONDUCTIVE GEL OR PASTE) SHALL BE USED ON ALL COMPRESSION AND BOLTED GROUND CONNECTIONS.
- 7. INSTALL GROUND CONDUCTORS AND GROUND ROD A MINIMUM OF 1'-0" FROM CONCRETE SLAB, FOOTING, OR FENCE.
- 8. ALL GROUNDING INSTALLATIONS AND CONNECTIONS SHALL BE MADE BY AN ELECTRICAL CONTRACTOR.
- 9. MISCELLANEOUS ELECTRICAL AND NON-ELECTRICAL METAL BOXES, FRAMES AND SUPPORTS SHALL BE BONDED TO THE GROUND RING, IN ACCORDANCE WITH THE NEC.
- 10. METAL CONDUIT AND TRAY SHALL BE GROUNDED AND MADE ELECTRICALLY CONTINUOUS WITH LISTED BONDING FITTINGS OR BY BONDING ACROSS THE DISCONTINUITY WITH 6 AWG COPPER WIRE AND UL APPROVED GROUNDING TYPE CONDUIT CLAMPS.
- 11. GROUND CONDUCTORS USED IN THE FACILITY GROUND AND LIGHTNING PROTECTION SYSTEMS SHALL NOT BE ROUTED THROUGH METALLIC OBJECTS THAT FORM A RING AROUND THE CONDUCTOR, SUCH AS METAL SUPPORT CLIPS OR SLEEVES THROUGH WALLS OR FLOORS. WHEN IT IS REQUIRED TO BE HOUSED IN CONDUIT TO MEET CODE REQUIREMENTS OR LOCAL CONDITIONS, NON-METALLIC MATERIAL SUCH AS PVC PLASTIC CONDUIT SHALL BE USED. WHERE USE OF METAL CONDUIT IS UNAVOIDABLE (E.G., NON-METALLIC CONDUIT PROHIBITED BY LOCAL CODE) THE GROUND CONDUCTOR SHALL BE BONDED TO EACH END OF THE
- 12. CHEMICAL GROUND SHALL BE XIT, CHEM-ROC, OR APPROVED EQUAL, WHEN REQUIRED.
- 13. CONNECTIONS TO THE GROUND BARS SHALL NOT BE DOUBLED UP OR STACKED. BACK-TO-BACK CONNECTIONS ON OPPOSITE SIDES OF THE GROUND BAR ARE PERMITTED.
- 14. NOTIFY PROJECT MANAGER IF THERE ARE DIFFICULTIES INSTALLING GROUNDING SYSTEM DUE TO SOIL CONDITIONS.
- 15. ANY EQUIPMENT, BOX, SKID TO BE GROUNDED AND DOES NOT HAVE A DESIGNATED GROUND CONNECTION SHALL BE DRILLED AS NECESSARY TO CONNECT A GROUND WIRE. REMOVE PAINT IN AREA UNDER LUG. APPLY ANTI-OXIDANT COMPOUND AND CONNECT WITH TWO-HOLE, COMPRESSION LUG.

GROUNDING NOTES

- 1. CONTRACTOR SHALL BE RESPONSIBLE FOR PROVIDING ALL MEANS AND METHODS TO COMPLETE ALL UPGRADES AS INDICATED IN THIS DOCUMENT.
- 2. ALL DIMENSIONS, SECTIONS AND DETAILS OF THE EXISTING STRUCTURE ARE INCLUDED FOR INFORMATION PURPOSES ONLY. THE CONTRACTOR SHALL VERIFY ALL RELEVANT INFORMATION PRIOR TO CONSTRUCTION OR FABRICATION. NOTIFY THE ENGINEER-OF-RECORD IMMEDIATELY OF ANY DISCREPANCIES. ALL NEW WORK SHALL ACCOMMODATE EXISTING CONDITIONS.
- 3. CONTRACTOR IS RESPONSIBLE FOR ERECTING TEMPORARY BARRICADES AND/OR FENCING TO PROTECT THE SAFETY OF THE PUBLIC DURING CONSTRUCTION. THE CONTRACTOR SHALL REMOVE ALL TEMPORARY BARRIERS AND REPAIR ALL DAMAGE TO PROPERTY ON THE SITE CAUSED BY THIS CONSTRUCTION. THE COST OF REPAIR IS THE CONTRACTOR'S RESPONSIBILITY.
- 4. ALL WORK SHALL BE IN ACCORDANCE WITH APPLICABLE LOCAL, STATE, AND FEDERAL REQUIREMENTS.
- 5. COORDINATE WORK INDICATED ON THESE DRAWINGS WITH THE NEW EQUIPMENT, EXISTING EQUIPMENT, WAVEGUIDE ETC.
- 6. THE CONTRACTOR SHALL BE RESPONSIBLE FOR VERIFICATION OF ALL MEASUREMENTS AT THE SITE PRIOR TO ORDERING ANY MATERIALS OR CONDUCTING ANY WORK.
- 7. ALL DETAILING, FABRICATION AND ERECTION OF STRUCTURAL STEEL SHALL CONFORM TO AISC SPECIFICATIONS AND CODES, LATEST EDITION.
- 8. CONTRACTOR SHALL COLD-GALVANIZE ALL RAW STEEL AS REQUIRED DURING CONSTRUCTION PROCESS.

GENERAL UPGRADE NOTES

SITE NUMBER:
LA74664B
SITE NAME:
HINSON-LIGHTHIPE 220kV

6227-6245 DE FOREST AVE LONG BEACH, CA 90805


REV	DATE	DESCRIPTION	
Α	07/03/17	90% ZD ISSUED FOR REVIEW	В
В	07/06/17	90% ZD REVISION PER DRM	В
С	07/14/17	90% ZD REVISION PER DRM	JI
D	07/18/17	90% ZD PRELIM SURVEY ADDED	J
Ε	08/31/17	90% ZD REVISION PER SCE	P
0	09/08/17	100% ZD ISSUED FOR ZONING	J
1	09/27/17	100% ZD REVISION PER RFDS	J
2	10/24/17	100% ZD REVISION PER SCE #2	J
3	11/17/17	100% ZD : MINOR REDLINES	J
4	12/08/17	100% ZD : SCE REDLINES	J
			+
			+

IT IS A VIOLATION OF LAW FOR ANY PERSON, NLESS THEY ARE ACTING UNDER THE DIRECTIO OF A LICENSED PROFESSIONAL ENGINEER, TO ALTER THIS DOCUMENT,

GENERAL NOTES, ABBREVIATIONS, AND SYMBOLS

TO2

GENERAL NOTES

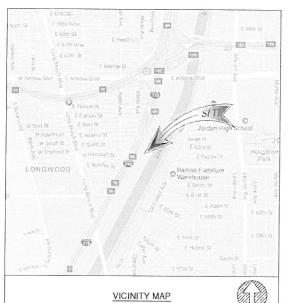

SITE ADDRESS

COOLIDGE TRIANGLE LONG BEACH, CA 90805 RECORD OWNER

SOUTHERN CALIFORNIA EDISON COMPANY, A CORPORATION TITLE REPORT

THE PRELIMINARY TITLE REPORT WAS PREPARED BY COMMONWEALTH LAND TITLE INSURANCE COMPANY WITH ORDER NUMBER 09204511-920-CMM-CMB DATED JULY 20, 2017.

BASIS OF BEARING

THE CENTERLINE OF FLOOD CONTROL CHANNEL BEARING N26'09'49"E WAS USED AS BASIS OF BEARING FOR THIS SURVEY.

BENCH MARK

SITE ELEVATIONS ARE ESTABLISHED FROM THE GPS DERIVED ORTHOMETRIC HEIGHTS BY APPLICATION OF NGS "GEOID 12A" MODELED SEPARATIONS TO ELLIPSOID HEIGHTS
DETERMINED BY OBSERVATIONS OF THE "LEICA SMARTNET" REAL TIME NETWORK. ALL
ELEVATIONS SHOWN HEREON ARE REFERENCED TO NAVD88

FLOOD ZONE

THE FLOOD MAP FOR THE SELECTED AREA IS NUMBER 06037C1955F EFFECTIVE ON 9/26/2008.

LEGAL DESCRIPTION

ALL THAT CERTAIN REAL PROPERTY SITUATED IN THE COUNTY OF LOS ANGELES, STATE OF CALIFORNIA, DESCRIBED AS FOLLOWS:
PARCEL 1, IN THE CITY OF LONG BEACH, COUNTY OF LOS ANGELES, STATE OF CALIFORNIA, AS SHOWN ON LICENSED SURVEYOR'S MAP FILED IN BOOK 30 PAGES 22 TO 25 INCLUSINE OF SECREPS.

SHOWN ON ELECTORED STREETING MAPE FEED IN BOOK SO FALLE 2 TO 2 INCESSIVE OF SERVEY, IN THE OFFICE OF THE COUNTY RECORDER OF SAID COUNTY.

EXCEPT THEREFROM THAT PORTION LYING SOUTH OF THE EASTERLY PROLONGATION OF THE SOUTHERLY LINE ON TRACT NO. 7717, AS PER MAP RECORDED IN BOOK 164 PAGES 27 TO 31 INCLUSIVE OF MAPS OF SAID COUNTY.

ALSO EXCEPT THEREFROM ALL OIL, GAS, AND OTHER HYDROCARBON SUBSTANCES OR MINERALS UNDER SAID LAND, AS PROVIDED IN THE DEED RECORDED IN BOOK 6677 PAGE 279, OFFICIAL PERCORDS.

UNDER SAID LAND, AS PROVIDED IN THE DEED RECORDED IN BOOK 6677 PAGE 279, OFFICIAL RECORDS.

NOTE: THIS COMPANY HAS PROVIDED SAID DESCRIPTION AS AN ACCOMMODATION FOR THE PURPOSE OF FACILITATING THIS REPORT.
SAID DESCRIPTION MAY NOT BE AN INSURABLE PARCEL PURSUANT TO THE SUBDIVISION MAP ACT OF THE STATE OF CALIFORNIA AND

SHOULD NOT BE RELIED UPON TO CONVEY OR ENCUMBER SAID LAND, UNTIL APPROVED BY THE APPROPRIATE GOVERNING AGENCY.

SCHEDULE B

ITEMS A-C.14 ARE TAX/LIENS RELATED. ITEMS 1,16 ARE RIGHTS RELATED. ITEMS 2,4,5,12,13,15 ARE DEED RELATED.

EASEMENT(S) FOR THE PURPOSE(S) SHOWN BELOW AND RIGHTS INCIDENTAL THERETO AS RESERVED IN A DOCUMENT;
RESERVED BY: CARSON ESTATE COMPANY
PURPOSE: FOR WATER PIPE LINES, OIL PIPE LINES, GAS PIPE LINES, OR FOR OTHER
UTILITIES, BUT NOT FOR
ELECTRIC POWER LINES OR WIRES FOR THE DISTRIBUTION OF ELECTRIC ENERGY
PERCONDURY NOT IN PORY STATE PAGE 22 DEFICIAL PERCORDS

RECORDING NO: IN BOOK 6191 PAGE 22 OFFICIAL RECORDS

8. EASEMENT(S) FOR THE PURPOSE(S) SHOWN BELOW AND RIGHTS INCIDENTAL THERETO, AS GRANTED IN A DOCUMENT:
GRANTED TO: SOUTHERN FUEL COMPANY, A CORPORATION

PURPOSE: CONDUITS AND PIPE LINE RECORDING DATE: JULY 19, 1938 RECORDING NO: IN BOOK 15957 PAGE 35 OFFICIAL RECORDS AFFECTS: AS DESCRIBED THEREIN.


AS CRANTED IN A DOCUMENT:
GRANTED IN A DOCUMENT:
GRANTED IN A DOCUMENT:
GRANTED TO: CITY OF LONG BEACH, A CALIFORNIA MUNICIPAL CORPORATION
PURPOSE: STORM DRAIN PURPOSES
RECORDING DATE: FEBRUARY 9, 1953
RECORDING NO: 3092 IN BOOK 40924 PAGE 262 OFFICIAL RECORDS
AFFECTS: AS DESCRIBED THEREIN.
AN AGREEMENT TO MODIFY THE TERMS AND PROVISIONS OF THE SAID DOCUMENT, AS
THEREIN PROVIDED
EXECUTED BY: SQUTHERN CALIFORNIA EDISON COMPANY, A CALIFORNIA CORPORATION AND
THE CITY OF LONG BEACH, A CALIFORNIA MUNICIPAL CORPORATION
RECORDING DATE: DECEMBER 1, 1959
RECORDING NO: 2823 OFFICIAL RECORDS

11. EASEMENT(S) FOR THE PURPOSE(S) SHOWN BELOW AND RIGHTS INCIDENTAL THERETO THE EASEMENI(S) FOR THE PURPUSE(S) SHOWN BELOW AND RIGHTS INCIDENTAL THE AS CONDENDED BY AN INSTRUMENT, ENTITED: FINAL ORDER OF CONDEMNATION COURT: SUPERIOR COURT, COUNTY OF LOS ANGELES CASE NO.: C 52628
IN FAVOR OF: STATE OF CALIFORNIA, ACTING BY AND THROUGH THE DEPARTMENT OF

TRANSPORTATION

TAANSPORTATION
PURPOSE: FREEWAY PURPOSES
RECORDING DATE: JANUARY 27, 1975
RECORDING NO: 2797 OFFICIAL RECORDS
AFFECTS: AS DESCRIBED THEREIN.



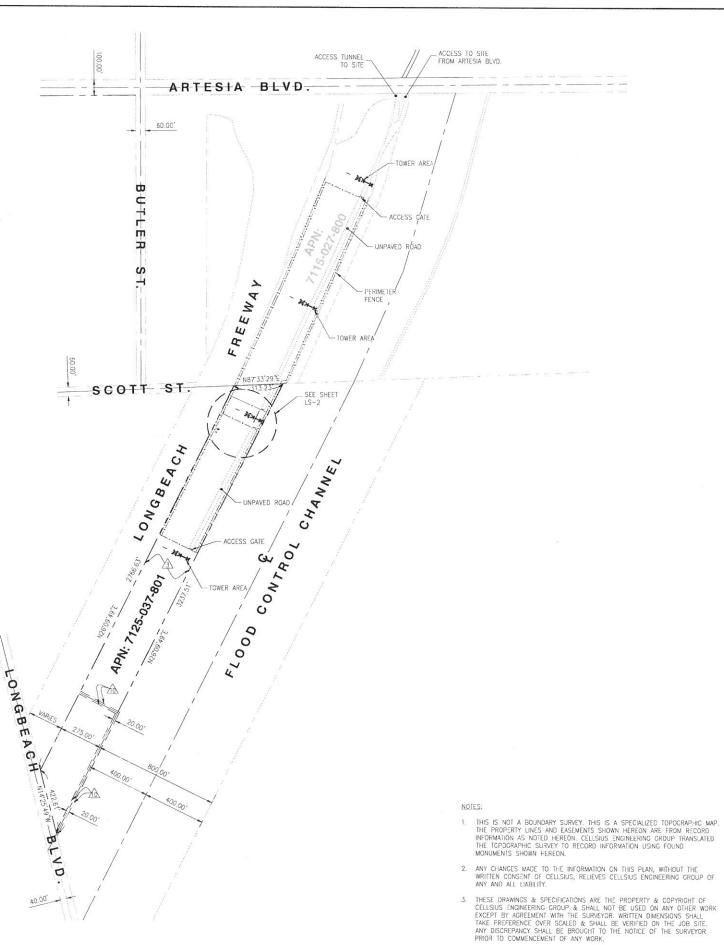

2008 McGAW AVENUE IRVINE, CA 92614

J5 ĮNĘRĄSŢRŲCĮTŲRĘ AZ - CA - CO - ID - NM - NV - TX - UT



1	09/7/2017	FINAL SURVEY
0	07/13/2017	PRELIMINARY SURVEY

ISSUED DATE:

SEPTEMBER 7, 2017

FINAL SURVEY

LICENSURE: -

PROJECT INFORMATION: -

LA74664

DR. FOREST PARK SCE TOWER COOLIDGE TRIANGLE LONG BEACH, CA 90805


DRAWN BY:	AA
CHECKED BY:	AJK

SHEET TITLE: -TOPOGRAPHIC SURVEY

SHEET NUMBER: -

4. FIELD SURVEY COMPLETED ON JULY 16, 2017.

LS-1

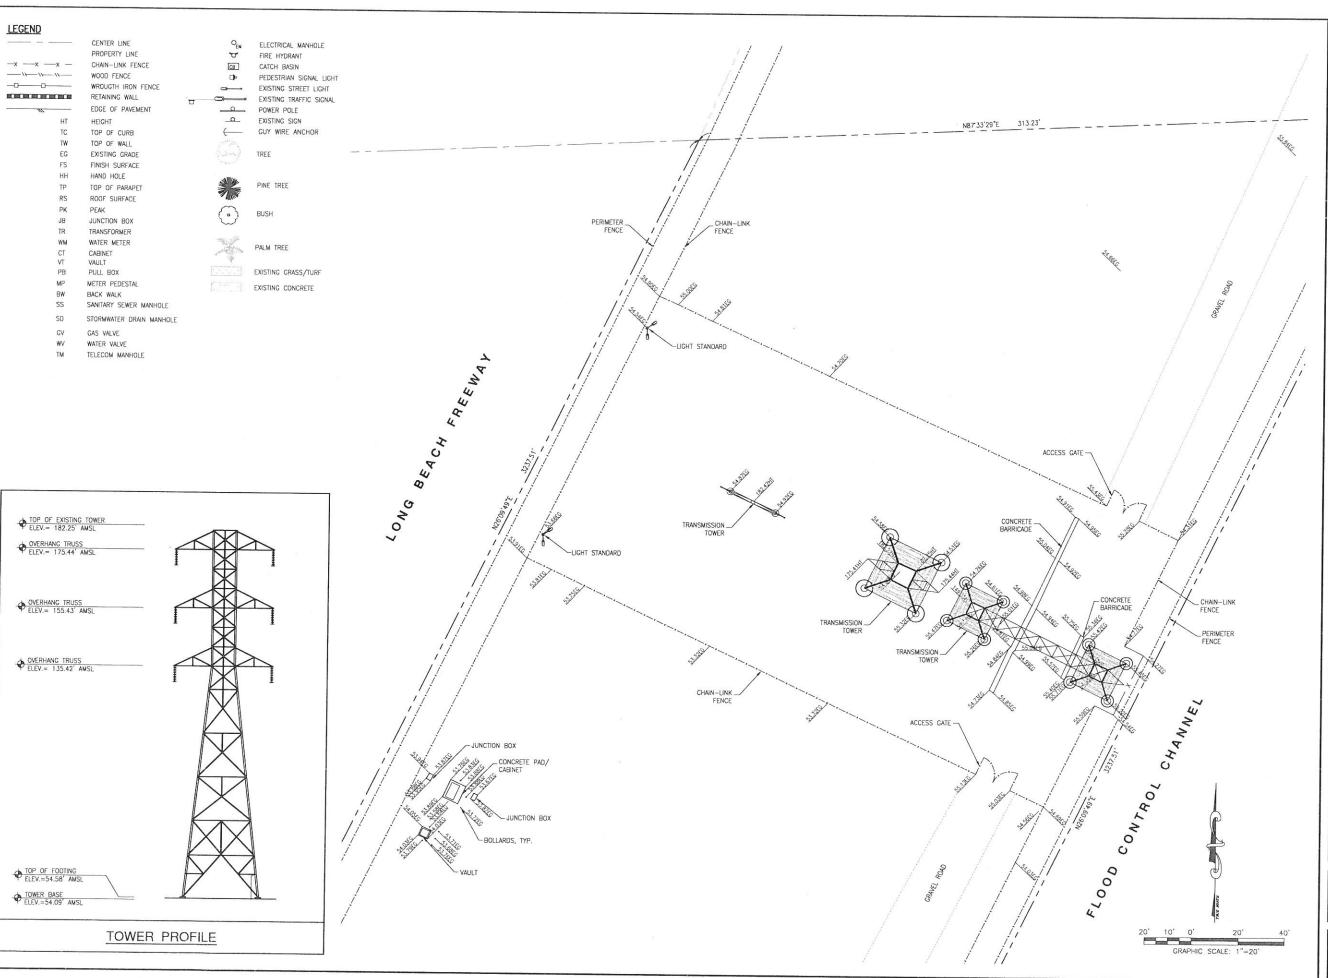

T - Mobile - 2008 McGAW AVENUE IRVNE, CA 92614





1	09/7/2017	FINAL SURVEY
0	07/18/2017	FINAL SURVEY
REV	DATE	DESCRIPTION

ISSUED DATE: -

SEPTEMBER 7, 2017

ISSUED FOR:

FINAL SURVEY

LICENSURE: -

PROJECT INFORMATION: -

LA74664


DR. FOREST PARK SCE TOWER COOLIDGE TRIANGLE LONG BEACH, CA 90805


DRAWN BY: AA
CHECKED BY: AJK
SHEET TITLE:

TOPOGRAPHIC SURVEY

SHEET NUMBER: -

LS-2

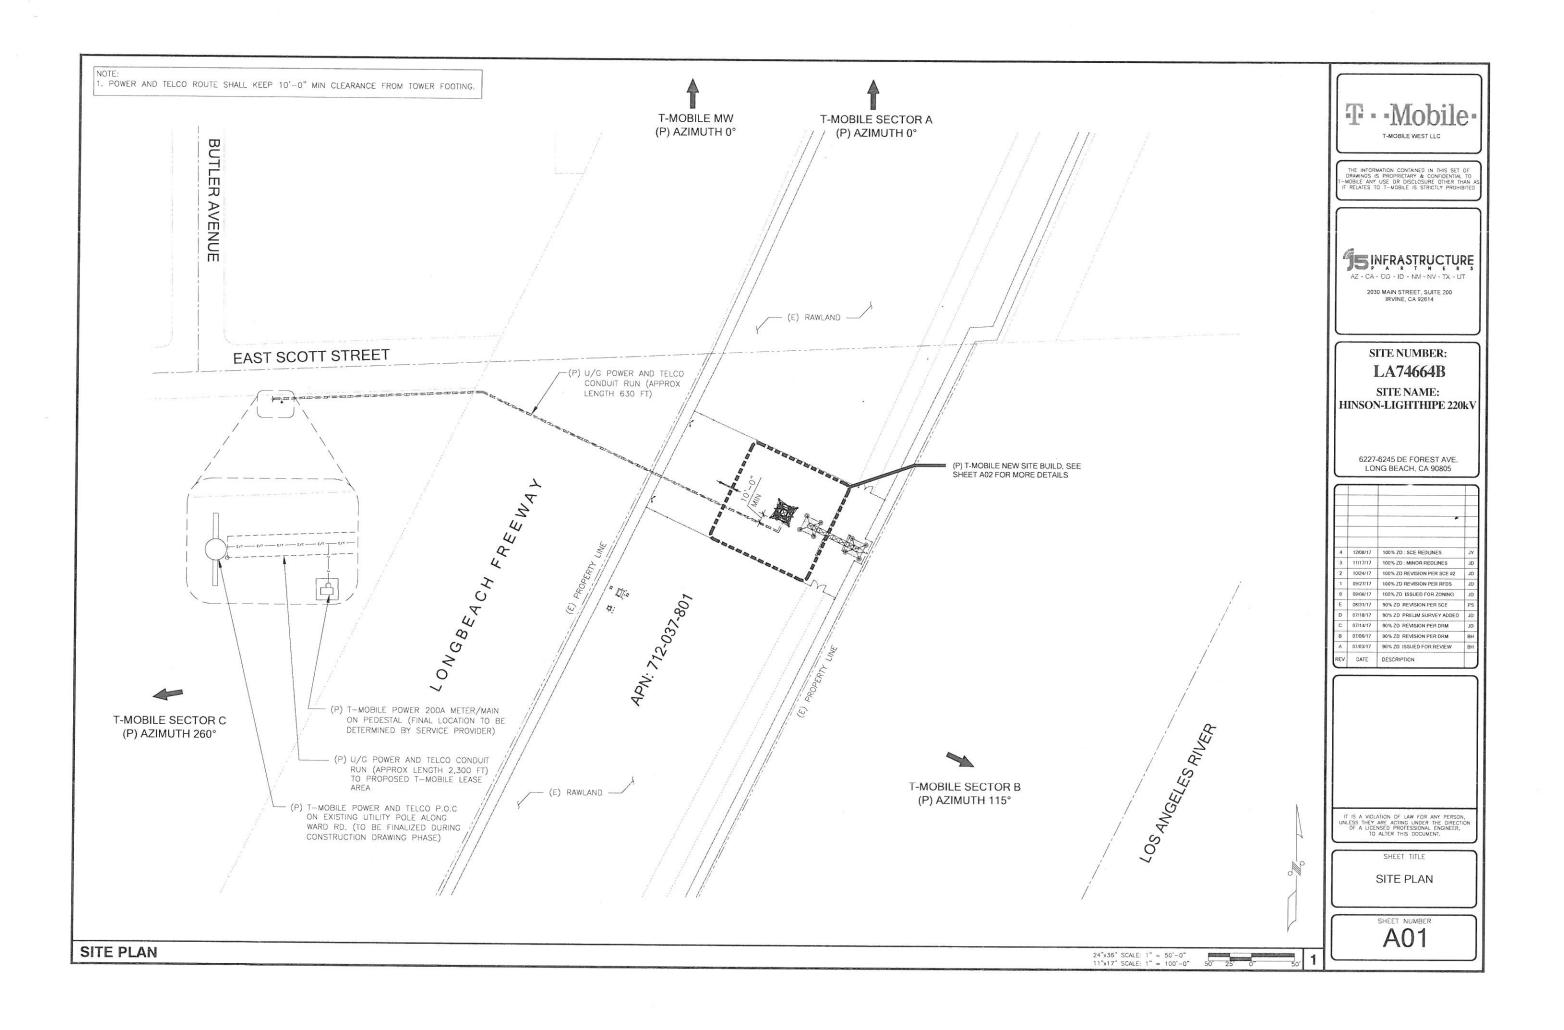

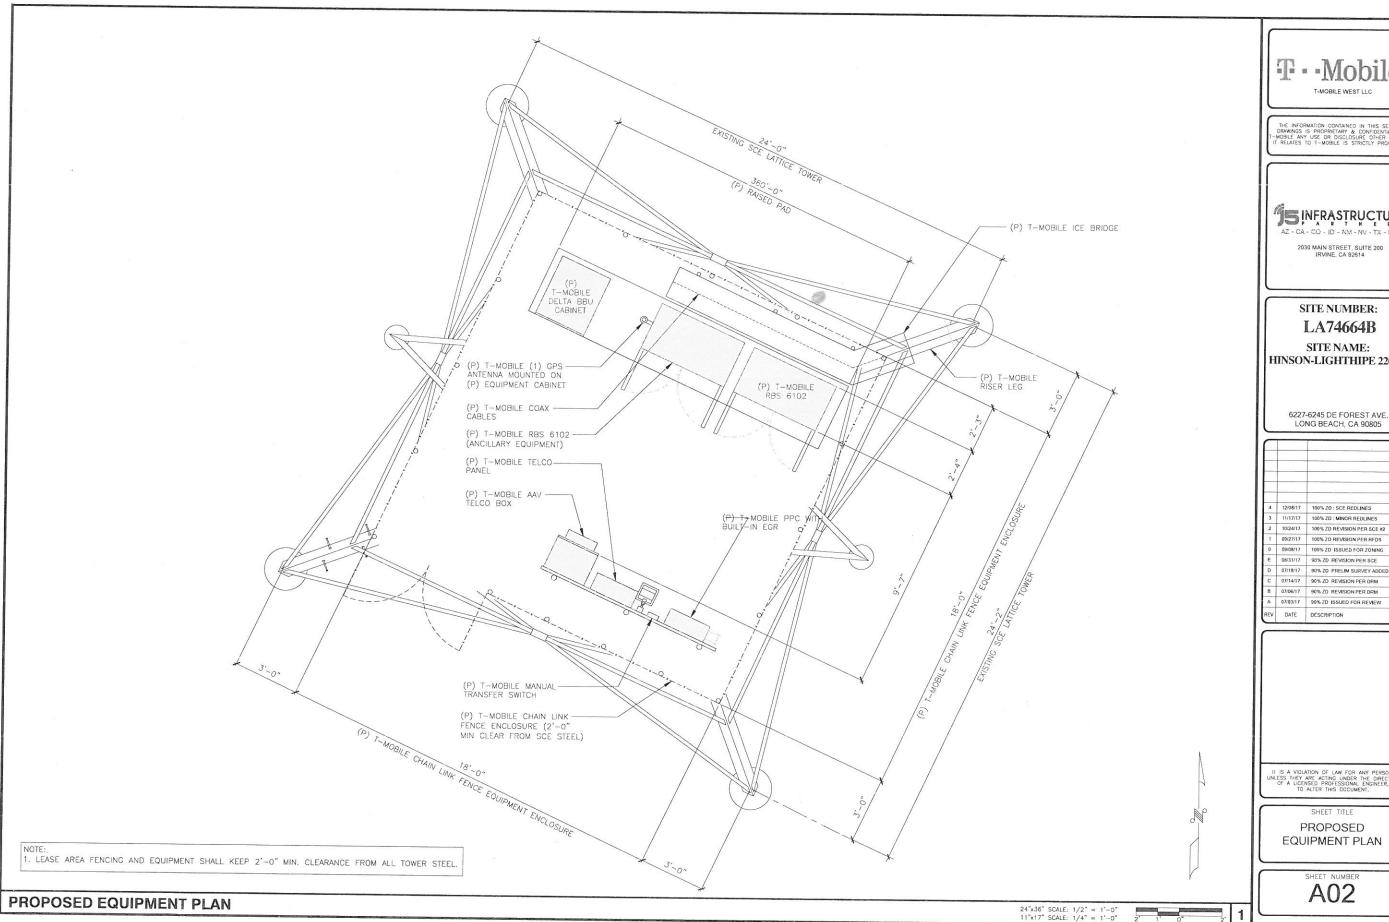

T - Mobile-T-MOBILE WEST LLC

15 INFRASTRUCTURE AZ - CA - CO - ID - NM - NV - TX - UT


LA74664B SITE NAME: HINSON-LIGHTHIPE 220kV


6227-6245 DE FOREST AVE. LONG BEACH, CA 90805


			Т
			T
			1
			+
4	12/08/17	100% ZD : SCE REDLINES	
3	11/17/17	100% ZD : MINOR REDLINES	1
2	10/24/17	100% ZD REVISION PER SCE #2	1
1	09/27/17	100% ZD REVISION PER RFDS	
0	09/08/17	100% ZD ISSUED FOR ZONING	١,
E	08/31/17	90% ZD REVISION PER SCE	F
D	07/18/17	90% ZD PRELIM SURVEY ADDED	
С	07/14/17	90% ZD REVISION PER DRM	1
В	07/06/17	90% ZD REVISION PER DRM	8
A	07/03/17	90% ZD ISSUED FOR REVIEW	8
REV	DATE	DESCRIPTION	


II IS A VIGLATION OF LAW FOR ANY PERSON, UNLESS THEY ARE ACTING UNDER THE DIRECTIO OF A LICENSED PROFESSIONAL ENGINEER, TO ALTER THIS DOCUMENT.


PROPOSED **EQUIPMENT PLAN**

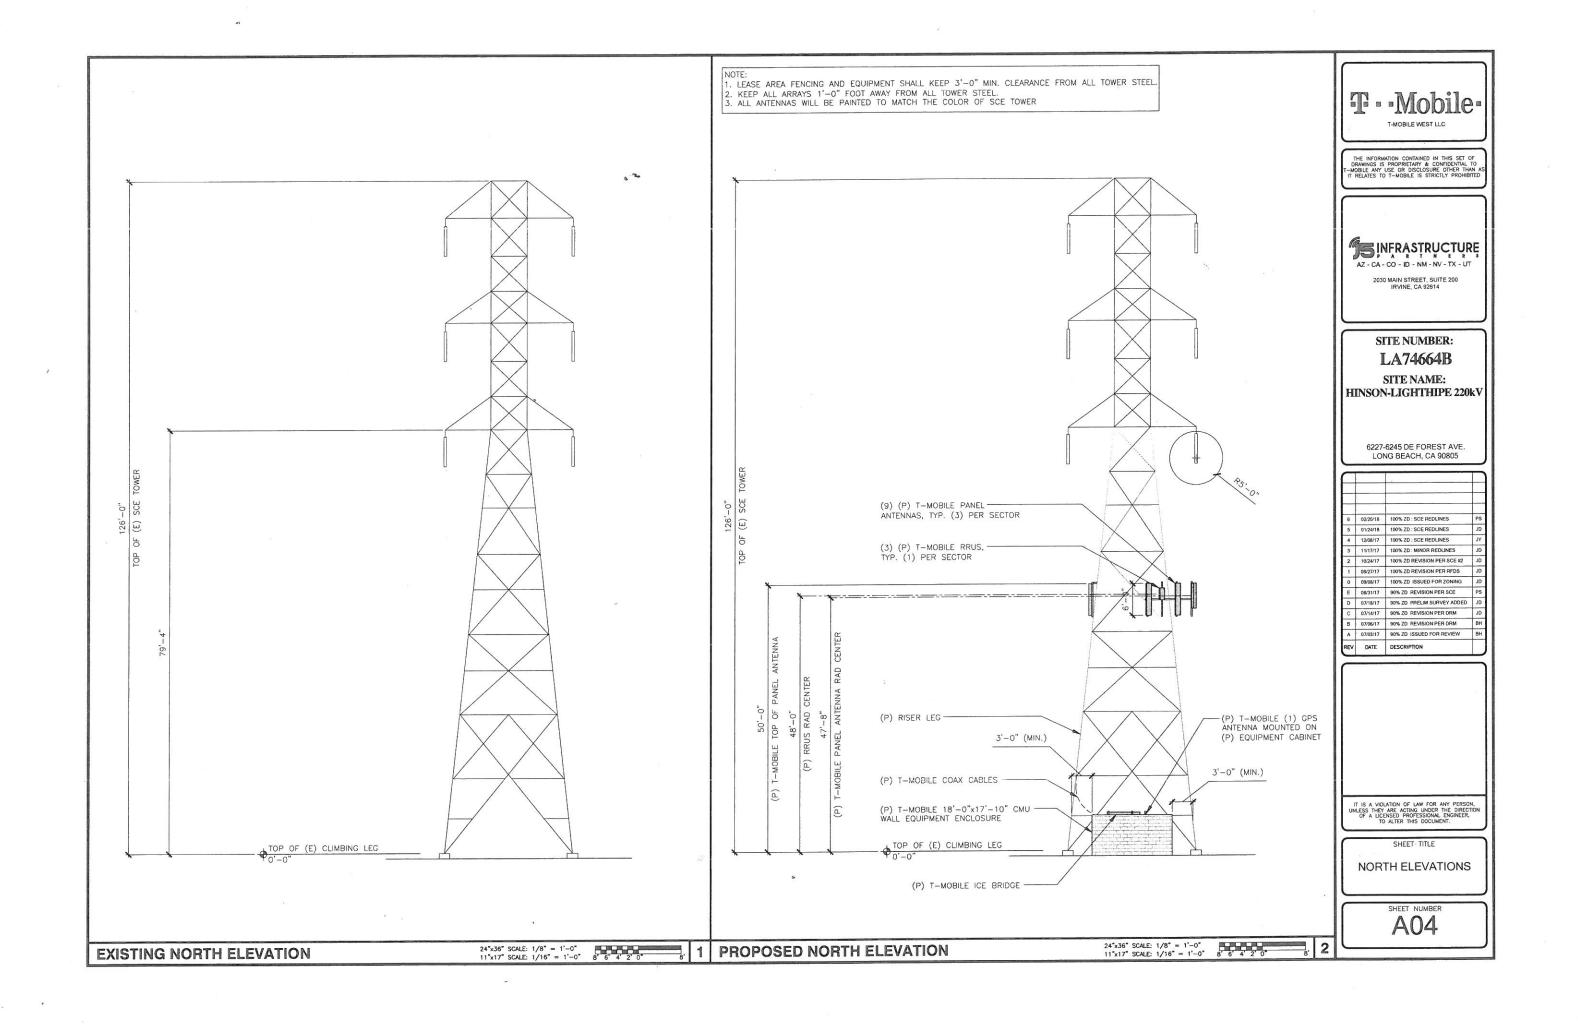

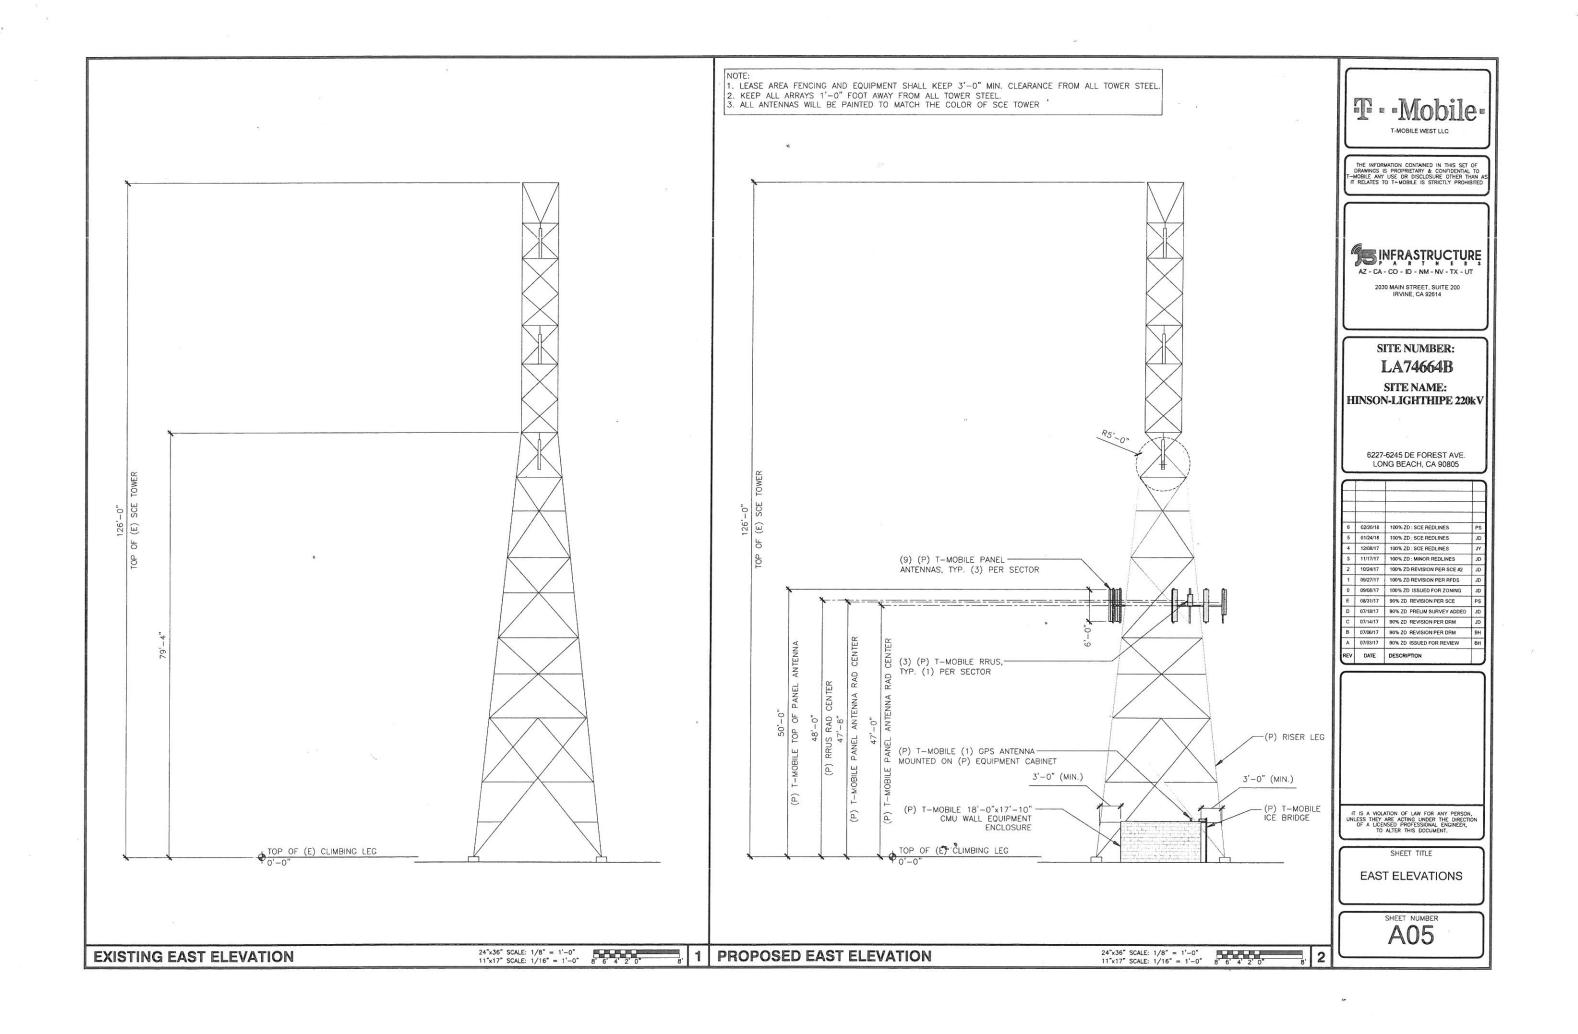

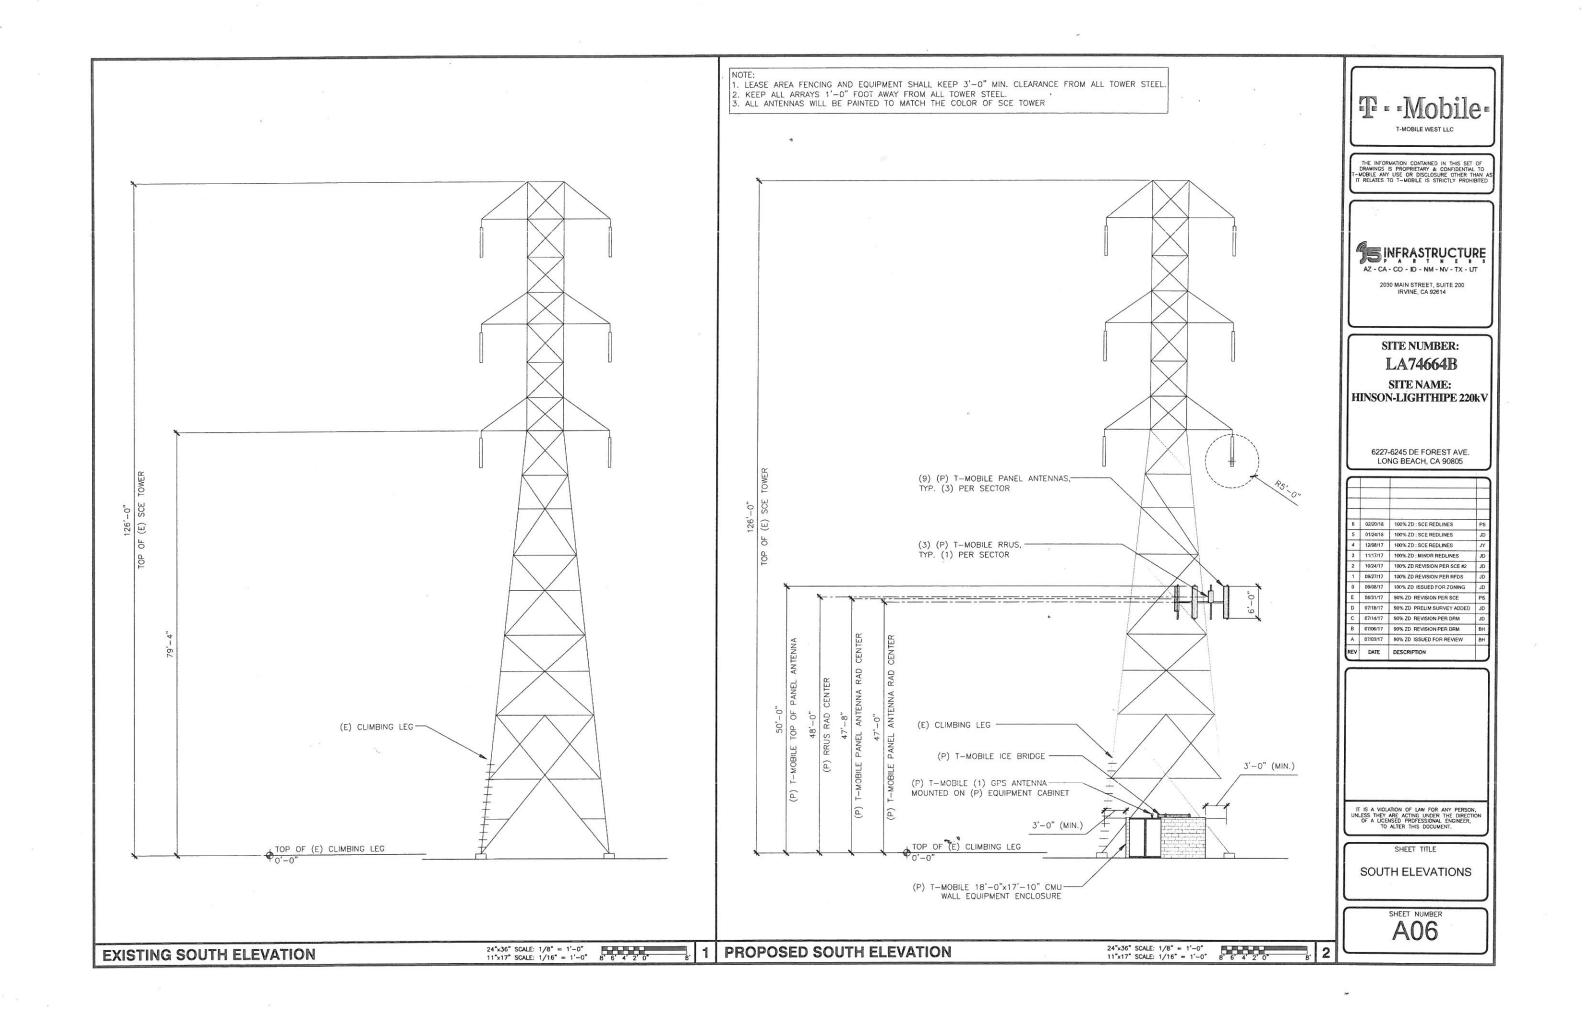

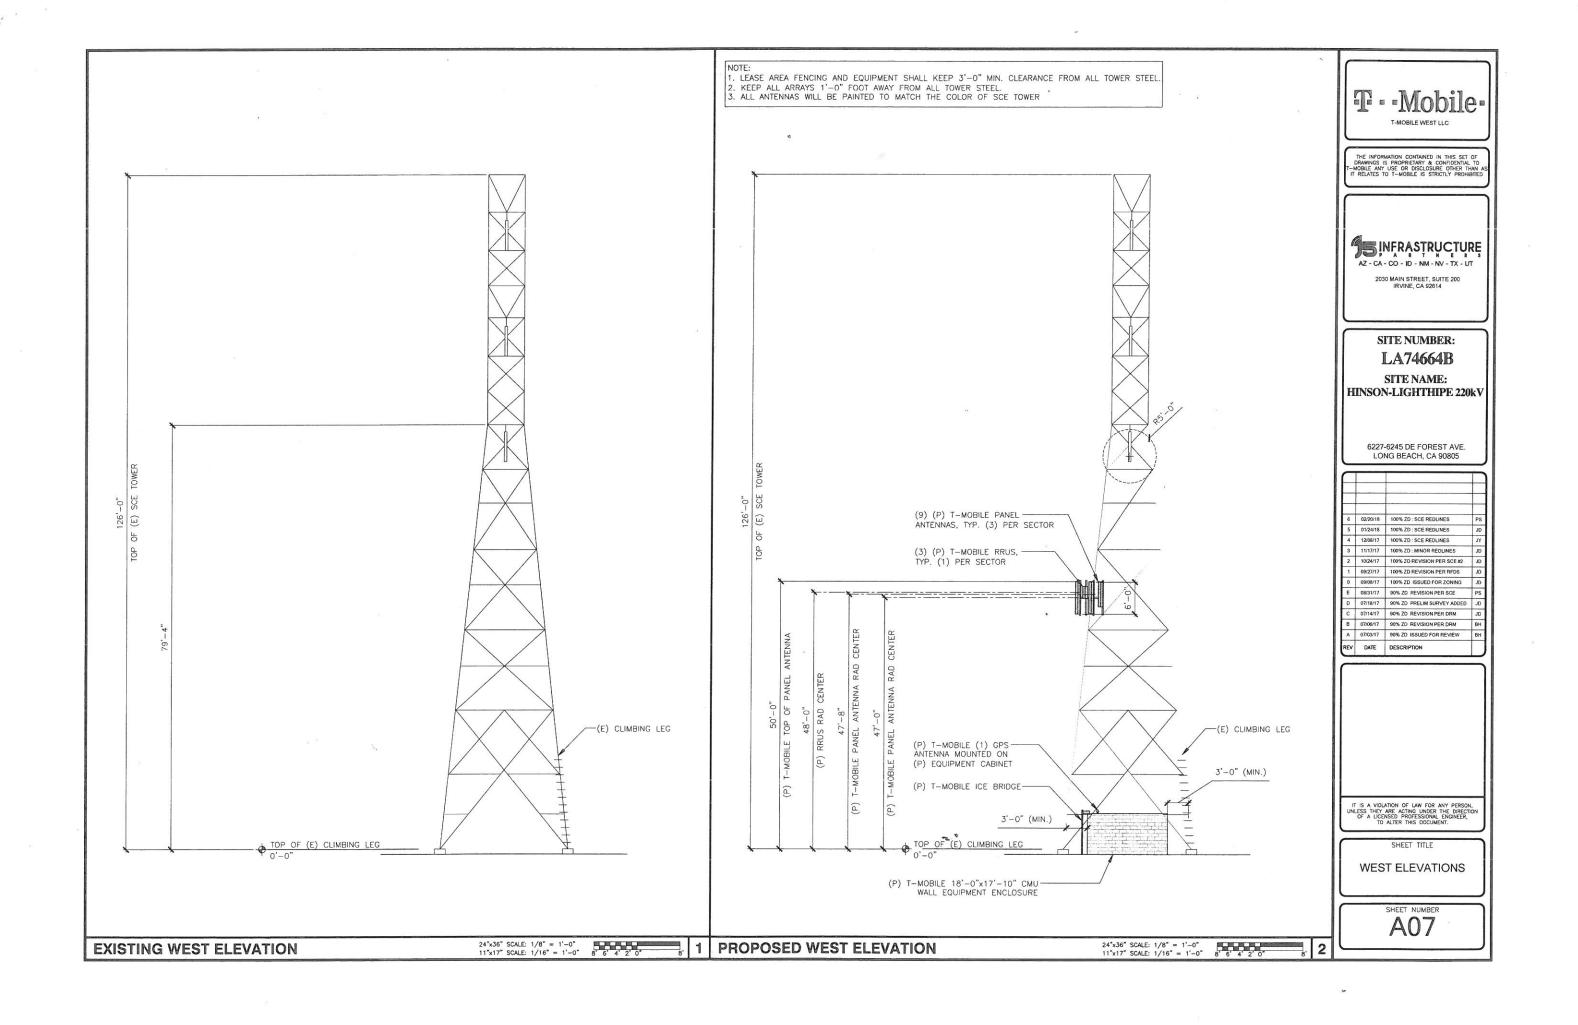

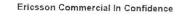




HCS 6 X 12

ERICSSON HYBRID CABLE, 6 DC PAIRS + 12 OPTICAL PAIRS


UL APPROVED

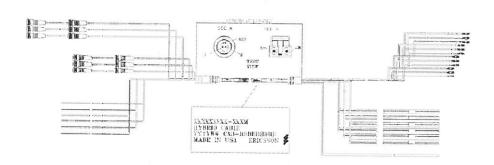


6 x 12 Weight and diameter	•
	6 AWG DC wires
Weight (kg/m)	2.5 (+/- 0.1)
Welght (lb/ft)	1.7 (+/- 0.1)
Diameter (mm)	35 (+/- 2.0 mm)
Diameter (in)	1.38 (+/~ 0.1")
Coax standard diameter equivalent	1 3/6"

24"x36" SCALE: NTS 11"x17" SCALE: NTS

ERICSSON 6AWG 6X12 HCS CABLE 24*x36* SCALE: NTS 11*x17* SCALE: NTS

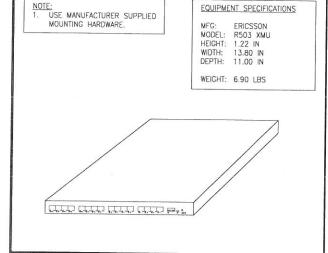


XMU SPECIFICATIONS

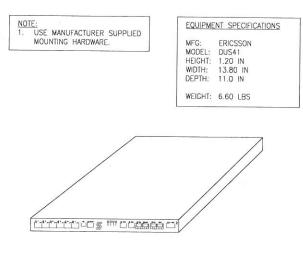

24"x36" SCALE: NTS 11"x17" SCALE: NTS

5 DUS41 SPECIFICATIONS

Mechanical	AIR21	AIR32 Single Band (SB)	AIR32 Dual Band (DB)
	B4a B2p	B4a B2p	B66Aa B2a
Weight (without mounting brackets)	41 Kg (=90.4 lbs)	48 Kg (=105.8 lbs)	60 Kg (=132.2 lbs)
Dimensions (HxWxD)	1427 x 307 x 200 mm	1439 x 327 x 220 mm	1439 x 327 x 220 mm
	(=56.2"x 12.1"x 7.9")	(=56.6'x 12.9" x 8.7")	(=56.6"x 12.9" x 8.7")
Frontal Wind load @ 150 km/h (=42 m/s) wind speed	580 N	650N	650 N

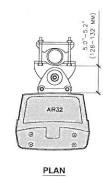

3


NOTES:


1. INSTALL ANTENNA TO EXISTING PIPE MAST USING MANUFACTURERS SUPPLIED BRACKETS AND MOUNTING HARDWARE

2. SET MECHANICAL DOWNTILT TO VALUE SPECIFIED IN LATEST RFDS

AIR32 SPECIFICATION AND MOUNTING DETAIL

TYPE NO.	85010070		
NAME	AIR CLAMP KIT 55-115 MM		
STATUS	BESTELLT		
VIEW			
SUITABLE FOR MAST DIAMETER	55-115 MM		
antenna – Mast distance f	128-132 MM		
NUMBER OF PIECES	2 PIECES		
MATERIAL - CLAMP	HOT-DIP CALVANIZED STEEL		
-SCREWS	HOT-DIP GALVANIZED STEEL /STAINLESS STEEL		
-NUTS	STAINLESS STEEL		
TYPE NO.	4,3 KG		

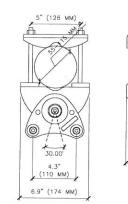

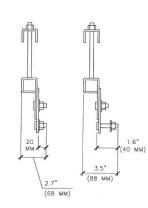

24"x36" SCALE: NTS 11"x17" SCALE: NTS T - Mobile -

THE INFORMATION CONTAINED IN THIS SET OF DRAWINGS IS PROPRIETARY & CONFIDENTIAL TO T-MOBILE ANY USE OR DISCLOSURE OTHER THAN A IT RELATES TO T-MOBILE IS STRICTLY PROHIBITED



2030 MAIN STREET, SUITE 200 IRVINE, CA 92614

SITE NUMBER:
LA74664B
SITE NAME:
HINSON-LIGHTHIPE 220kV

6227-6245 DE FOREST AVE. LONG BEACH, CA 90805

_						
		T	Τ			
F			F			
F			L			
			İ			
4	12/08/17	100% ZD : SCE REDLINES	J			
3	11/17/17	100% ZD : MINOR REDLINES	J			
2	10/24/17	100% ZD REVISION PER SCE #2	J			
1	09/27/17	100% ZD REVISION PER RFDS	J			
0	09/08/17	100% ZD ISSUED FOR ZONING	J			
Е	08/31/17	90% ZD REVISION PER SCE	Р			
D	07/18/17	90% ZD PRELIM SURVEY ADDED	J			
С	07/14/17	90% ZD REVISION PER DRM	J			
В	07/06/17	90% ZD REVISION PER DRM	В			
Α	07/03/17	90% ZD ISSUED FOR REVIEW	В			
REV	DATE	DESCRIPTION				

ATTACHED LEAD
TO PIPE USING 2-HOLE LUG

FRONT

ATTACHED LEAD
TO SECTOR
GND BAR

SIDE



किन किन

BOTTOM VIEW

op g

MBK-02 Bottom counting Bracket

ANTENNA BRACKETS

SHEET TITL

DETAILS

IT IS A VICLATION OF LAW FOR ANY PERSON, UNLESS THEY ARE ACTING UNDER THE DIRECTIO OF A LICENSED PROFESSIONAL ENGINEER, TO ALTER THIS DOCUMENT.

D01

4 DBXNH-6565B-A2M SPECIFICATION AND MOUNTING DETAIL

24"x36" SCALE: NTS 11"x17" SCALE: NTS



MI-554nn Diplexer 600/700

MASS™

Microdata Advanced Site Solutions

With our expertise in site system design we are able to provide a solution for any site sharing or upgrade scenario.

Our focus area is RF-filter based solutions including combiners, multi band TMAs, ci-, tri- and quadruplexers.

Our product portfolio supports all frequencies for mobile communication bands ranging from 450 MHz

Site and network sharing makes it cost efficient to reach sparsely populated areas where new subscribers can contribute to revenue.

MASS™ Advantage

Increases coverage more traffic & higher ARPU

Increases capacity more traffic & higher ARPU


Reduces the cost of network expansion

Minimizes site acquisition issues


Specifications

Specifications		
600		
Frequency Band	617 - 688 MHz	
Insertion Loss	<0.3 dB*, <0.55 dB max	
Return Loss	>20 d8 *, >10 d8 min	
Rejection 698 - 716 MHz	>20 dB	
Rejection 728 - 746 MHz	>50 dB	
Continuous Average Power	250 W	
Intermodulation, 2x43 dBm TX Carrier	-117 dBm	
700		
Frequency Band	598 - 746 MHz	
Insertion Loss	<0.3 dB*, <0.5 dB max	
Return Loss	>20 d8 *, >18 d8 min	
Rejection 663 - 688 MHz	>20 dB	
Rejection 617 - 642 MHz	>50 dB	
Continuous Average Power	250 W	
Intermodulation, 2x43 dBm TX Carrier	-117 dBm	
Environmental		
Operating Temperature Range	-40 to +65°C -40 to +1	49°F
Operation	ETS 300 019-1-4 Class 4.1E	
Storage	ETS 300 019-1-1 Class 1.2	
Ingress Protection	1967	
Electrical		With Auto-Sense
DC By Pass	3 A	2A, drop max 2.4V
AISG pass	Yes	
AISG RL		>12dB
AISG Loss		< 1 dB
Lightning Protection	5 kA 8/20 us	10 kA 8/20 us
Input Voltage Power		8-31 V max 0.3 W
Mechanical		With Auto-Sense
Dimensions (WxHxD) (8:4 version)	300x160x116 mm 11.81x6.30x4.57 in	301x161x145 mm 11.85x6.34x5.71 in
Dimensions (WxHxD) (4:2 version)	To be added	To be added
Connectors	4.3-10 f (x12 8:4 version)	
Mounting	Hose clamps or wall mount (Supporter Pole Diameter: 40-	-140mm)
Volume (8:4 version) (4:2 version)	5.6 l < 3.5 f	7.01
Weight (8:4 version) (4:2 version)	6.7 kg 14.77 lb	7.2 kg 15.87 lb
Celour	NCS 1502-R	
Bracket	Included	
/ersions		
3:4 Diplexer (8 band 4 common)	MI-5544n	
4:2 Diplexer (4 band 2 common)	MI-5543n	

Mechanical Drawing

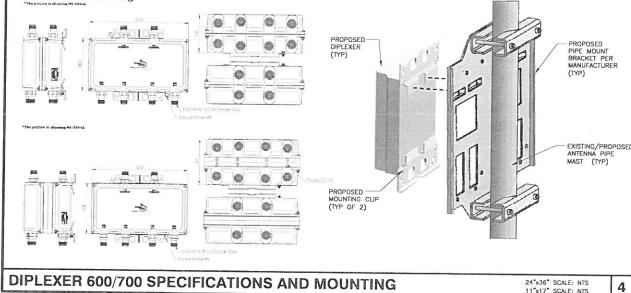


24"x36" SCALE: NTS 11"x17" SCALE: NTS

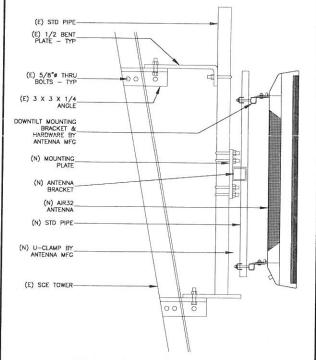

ANTENNA MOUNTING DETAIL (PROVIDED BY SCE)

RRUS 11 B12 SPECIFICATION AND DETAIL

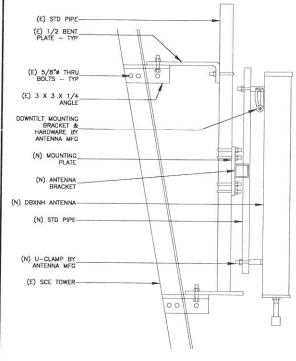

24"x36" SCALE: NTS 11"x17" SCALE: NTS

24"x36" SCALE: NTS 11"x17" SCALE: NTS





2030 MAIN STREET, SUITE 200 IRVINE, CA 92614

SITE NUMBER: LA74664B SITE NAME: HINSON-LIGHTHIPE 220kV

6227-6245 DE FOREST AVE. LONG BEACH, CA 90805

			-
4	12/08/17	100% ZD : SCE REDLINES	JY
3	11/17/17	100% ZD : MINOR REDLINES	JD
2	10/24/17	100% ZD REVISION PER SCE #2	JD
1	09/27/17	100% ZD REVISION PER RFDS	JD
0	09/08/17	100% ZD ISSUED FOR ZONING	JD
Ε	08/31/17	90% ZD REVISION PER SCE	PS
D	07/18/17	90% ZD PRELIM SURVEY ADDED	JD
С	07/14/17	90% ZO REVISION PER DRM	JD
В	07/06/17	90% ZD REVISION PER DRM	ВН
Α	07/03/17	90% ZD ISSUED FOR REVIEW	ВН
REV	DATE	DESCRIPTION	

MANUFACTURER: MODEL NO.: DIMENSIONS (HXWXD): WEIGHT (WITHOUT MOUNTING):	ERICSSON RRUS 11 B12 500mm (19.6") X 431mm (16.9") X 182 (7.16") 50.7 LBS (23 KG)	4	31 •	
RRUS11 —TYP	MOUNTING PIPE PIPE CLAMP MOUNTING BRACKE	ET Various	500	
		Description	Value	
		Maximum nominal output power	2x10 W, 2x20 W, 2x30 W, 2x40 W ⁽¹⁾ (subject to license handling)	
		Number of carriers	One to four carriers (subject to license handling)	
		Description	Value	
			Dimensions with Solar Shield and Handle	
		Height	500 mm	
		Width	431 mm	
		Depth	182 mm	
		Weight		
		RRUS 11	23 kg	
<u> </u>		Color		
		Gray		

IT IS A VIOLATION OF LAW FOR ANY PERSON, UNLESS THEY ARE ACTING UNDER THE DIRECTIO OF A LICENSED PROFESSIONAL ENGINEER, TO ALTER THIS DOCUMENT,

DETAILS

D02

