


10	QIY.		Wall	DESCRIPTION	MIERAL		UL FACTOR		REMARKS
	(E)	(%)	1000000	\$1000 (\$1000 E					
1		2	35 1 87	EXT. ENTRY DOOR	S0U0 W000 D00R			100	
2	2		120° x 84°	CARACE DOOR	WOOD DOOR, MANUAL OPEN				
3		1	30° ± 80°	GARAGE ENTRY DOOR *	PANEL WOOD DOOR			100	
4	3	6	30° ± 80°	INTR. SINGLE DOOR	PANEL WOOD DOOR				
5	1		24" x 80"	INTR. SINGLE DOOR	PANEL WOOD DOOR				
8	M W 11	2	2F x 80"	NTR. SINGLE DOOR	PANEL WOOD DOOR				
7	1		80" 1 95"	EXT. FRENCH DOOR	WOOD DOOR W/ TEMP. GLASS				
8		1	EUT + BUT	PATIO SLIDING DOOR	WOOD DOOR W/ DOUBLE PANE TEMP. CLASS		1 / 2	11/100	
9		1	192" x 84"	GARAGE FOLDING DOOR	ALUMINUM ROLLING DOOR, WOOD PATTERN		- 1		3
0				SCHEDULE					
$\stackrel{\smile}{\sim}$	EXIST		W WINDOW	SCHEDULE DESCRIPTION	MATERNAL	ID ENCTOR		esc T	PENANCS
$\stackrel{\smile}{\sim}$			WeH	DESCRIPTION	MATERIAL	UL FACTOR		HGC	PENARKS
0	יוס		WtH 40" x 54"	DESCRIPTION SINGLE HUNG WINDOW	WOOD FRAME W/ GLASS PANEL	9.3		0.21	PENANCS
$\stackrel{\smile}{\sim}$	OTY (E)		WeH	DESCRIPTION SINGLE HUNG WINDOW SINGLE HUNG WINDOW	WOOD FRAME W/ GLASS PANEL WOOD FRAME W/ GLASS PANEL	9.3 0.3		0.21	PENANCS
0	(E) 1		WtH 40" x 54"	DESCRIPTION SINGLE HUNG WINDOW	WOOD FRAME W/ GLASS PANEL	9.3 0.3 0.3		0.21 0.21 0.21	PENARS:
D 1 2	(E) 1	(%)	WxH 40" x 54" 42" x 54"	DESCRIPTION SINGLE HUNG WINDOW SINGLE HUNG WINDOW SINGLE HUNG WINDOW	WOOD FRAME W/ GLASS PANEL WOOD FRAME W/ GLASS PANEL WOOD FRAME W/ GLASS PANEL	9.3 0.3		0.21 0.21 0.21	PENARS
D 1 2 3	(E) 1	(%)	40° x 54° 42° x 54° 24° x 56°	DESCRIPTION SINGLE HUNG WINDOW SINGLE HUNG WINDOW SINGLE HUNG WINDOW	WOOD FRAME W/ GLASS PANEL WOOD FRAME W/ GLASS PANEL	9.3 0.3 0.3		0.21 0.21 0.21	PENARS
D 1 2 3 4	(E) 1 2	(%)	40° x 54° 42° x 54° 42° x 54° 24° x 36° 36° x 36°	DESCRIPTION SINGLE HUNG WINDOW SINGLE HUNG WINDOW SINGLE HUNG WINDOW	WOOD FRAME W/ GLASS PANEL WOOD FRAME W/ GLASS PANEL WOOD FRAME W/ GLASS PANEL	63 63 63		0.21 0.21 0.21	PENARUS
1 2 3 4 5	(E) 1 2	1 1	40" x 54" 42" x 54" 24" x 35" 36" x 36" 42" x 54"	DESCRIPTION SINGLE HUNG WINDOW	WOOD FRAME W/ GLASS PANEL WOOD FRAME W/ GLASS PANEL WOOD FRAME W/ GLASS PANEL WOOD FRAME/DOUBLE PANE GLASS PANEL WOOD FRAME/DOUBLE PANE GLASS PANEL	63 63 63 64 64 65 65 65 65 65 65 65 65 65 65 65 65 65		0.21 0.21 0.21 0.21 0.21 0.21 0.21	PENARUS
1 2 3 4 5 6	(E) 1 2	1 1	#VH 40" x 54" 42" x 54" 24" x 35" 36" x 35" 42" x 54"	DESCRIPTION SINGLE HUNG WINDOW SINGLE HUNG WINDOW	WOOD FRAME W/ QLASS PAMEL	63 63 63 63 63		0.21 0.21 0.21 0.21 0.21 0.21 0.21	PENANS
1 2 3 4 5 6 7	(E) 1 2	1 1	# WYH 40" x 54" 42" x 54" 24" x 35" 36" x 36" 42" x 54" 48" x 54" 36" x 36"	DESCRIPTION SINGLE HUNG WINDOW	WOOD FRAME W/ GLASS PANEL WOOD FRAME W/ GLASS PANEL WOOD FRAME W/ GLASS PANEL WOOD FRAME/DOUBLE PANE GLASS PANEL WOOD FRAME/DOUBLE PANE GLASS PANEL	63 63 63 64 64 65 65 65 65 65 65 65 65 65 65 65 65 65		0.21 0.21 0.21 0.21 0.21 0.21 0.21	PENARUS

- NOTE:

 * : SELF -CLOSING , TIGHT FITTING, SOLID WOOD , 1 * THICK DOOR NOT LESS THAN 20-MIN. RATED DOOR AT OPENING TO DIRELLING (CREC 715.4.3)

 * : MIN.27 ABOVE FIRMS FLOOR SOLIDING DOOR SHALL HAVE A LABEL ATTACHED CERTIFED BY THE NATIONALS FERESTRATION SATIO COLORIOL (MINEC) AND COMPULANCE WITH THE DIRECY CALDULATIONS.

 2. THE LOAD RESISTANCE OF CLASS UNDER UNIFORM LOAD SHALL BE DETERMINED IN ACCORDANCE WITH ASTIN E 1300

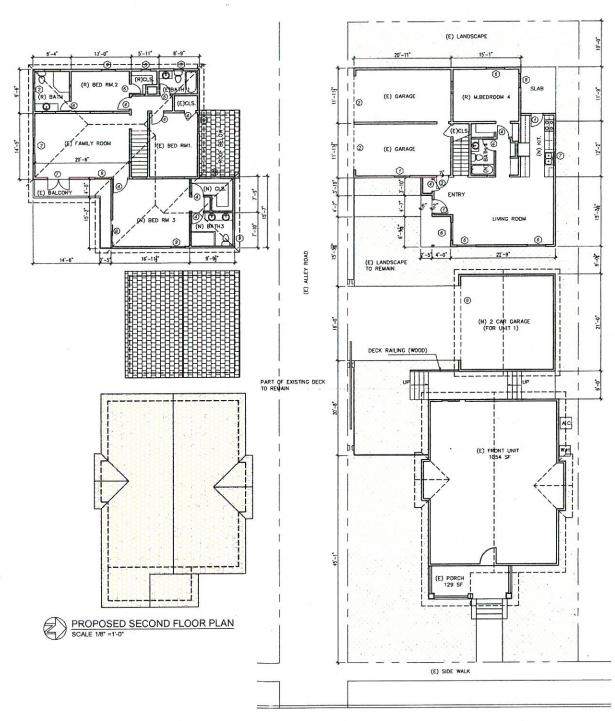

REMODEL-ADDITION OWNER: NANCY NGUYEN 627 TEMPLE ST LONG BEACH CA 90012

Drawing Title
PROPOSED PLANS
DOOR/WINDOW SCHEDULE

Project Number Date 06-22-2017


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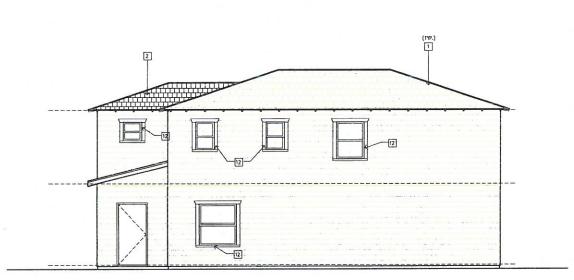
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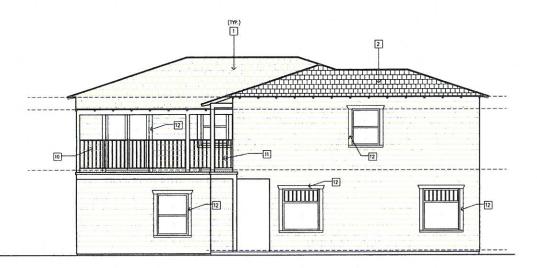
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EXISTING SITE PLAN SHOWING PROPOSED PLAN SCALE 1/8" =1'-0"






UNIT 2 - WEST ELEVATION (REAR VIEW) SCALE 1/4" = 1'-0"

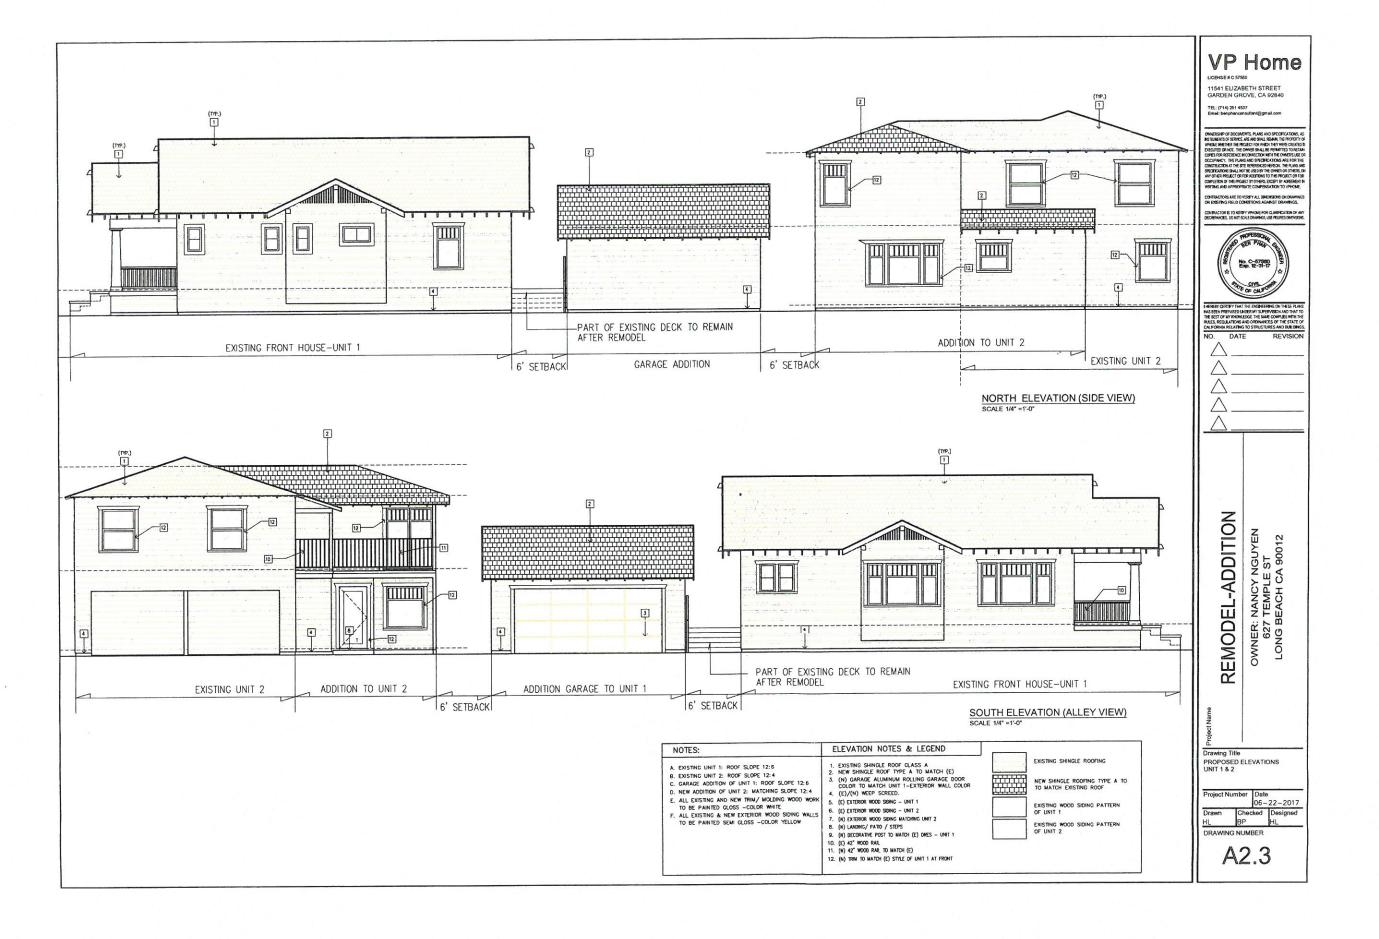

UNIT 2 - EAST ELEVATION (FRONT VIEW) SCALE 1/4" =1'-0"

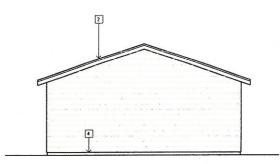

NEW GARAGE EAST- WEST ELEVATION FRONT/REAR VIEW) SCALE 1/4" = 1'-0"



UNIT 1 - EAST ELEVATION SHOWING UNIT 2 PROFILE OUTLINE SCALE 1/4" = 1'-0"

NOTES:	ELEVATION NOTES & LEGEND	
A. EXISTING UNIT 1: ROOF SLOPE 12:6 B. EXISTING UNIT 2: ROOF SLOPE 12:4 C. GARAGE ADDITION OF UNIT 1: ROOF SLOPE 12:6 D. NEW ADDITION OF UNIT 2: MATCHING SLOPE 12:4 E. ALL EXISTING AND NEW TRIAL/ MOLDING WOOD WORK TO BE PAINTED GLOSS -COLOR WHITE E. ALL EXISTING & NEW EXTERIOR WOOD SIDING WALLS TO BE PAINTED SEMI GLOSS -COLOR YELLOW	1. EXISTING SHINGLE ROOF CLASS A 2. NEW SHINGLE ROOF TYPE A TO MATCH (E) 3. (N) CARAGE ALUMINUM ROLLING GARAGE DOOR COLOR TO MATCH UNIT 1—EXTERIOR WALL COLOR 4. (E)/(N) WEEP SCREED. 5. (E) EXTERIOR WOOD SONIC — UNIT 1 6. (e) EXTERIOR WOOD SONIC — UNIT 2 7. (N) EXTERIOR WOOD SONIC — UNIT 2 8. (N) LANDING/ PATIO / STEPS 9. (N) DECORATIVE POST TO MATCH (E) ONES — UNIT 1 10. (e) 42" WOOD RAIL 11. (N) 42" WOOD RAIL TO MATCH (E) 12. (N) TRIM TO MATCH (E) STYLE OF UNIT 1 AT FRONT	EXISTING SHINGLE ROOFING NEW SHINGLE ROOFING TYPE A TO TO MATCH EXISTING ROOF EXISTING WOOD SIDING PATTERN OF UNIT 1 EXISTING WOOD SIDING PATTERN OF UNIT 2

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OWNER: NANCY NGUYEN 627 TEMPLE ST LONG BEACH CA 90012

roject Name

Drawing Title
PROPOSED ELEVATIONS
UNIT 1 & 2

A2.4