


EXHIBIT B GENERAL NOTES (CON'T.) GENERAL NOTES ALL WORK SHALL CONFORM TO THE CONTRACT DOCUMENTS INCLUDING THE DRAWINGS, SPECS, ALL ADDENDA, BULLETINS, CHANGE ORDERS AND THE LIKE. CARPET SEAMING DIAGRAM MEP LAYOUT SPRINKLER/LIFE SAFETY SPECS, ALL ADDENDA, BULLETINS, CHANGE ORDERS AND THE LIKE. THE GENERAL CONTRACTOR (CG. SHALL REVIEW ALL DOCUMENTS AND VERIFY ALL DIMENSIONS AND FIELD CONDITIONS AND SHALL CONFIRM THAT WORK IS BUILDABLE AS SHOWN, ANY CONFLICTS OR OMISSIONS, ETC., SHALL BE IMPROBABLELY REPORTED TO THE ARCHITECT & OWNER IN WRITING, FOR CLARFICATION PRIOR TO THE PERFORMANCE OF ANY WORK IN QUESTION. THE GC. SHALL BE RESPONSIBLE FOR CORRECTION OF ALL WORK, AS DIRECTED BY ARCHITECT, FOR WHICH THE ARCHITECT WAS NOT NOTIFIED IN 425 E ATH STREET UNIT C STRUCTURAL STEEL LONG BEACH, CA 90802 MISCELLANEOUS METALS **JUDGING STAND 3S** PHONE: (562) 733-3637 H. PAINTING 7 FREELON STREET I. GLAZING ALL WORK SHALL BE PERFORMED DURING REGULAR BUSINESS HOURS WHENEVER POSSIBLE, U.O.N. OR AGREED TO. J. LIGHTING 40. CONFIRM APPROXIMATE ON-SITE DELIVERY DATES FOR ALL CONSTRUCTION MATERIALS REQUIRED BY THE CONTRACT DOCUMENTS. NOTIFY ARCHITECT IN WRITING WITHIN 10 CALENDAR DAYS OF THE CONTRACT DATE OF ANY POSSBLE CONSTRUCTION DELAYS AFFECTION OCCUPANCY THAT MAY ARBE DUE TO THE AMALBELITY OF SECRETED PRODUCTS. REQUESTS FOR SUBSTITUTIONS DUE TO DELIVERY DATES OF SPECIFIED PRODUCTS WILL NOT BE ACCEPTED AFFEC CONSTRUCTION STARTS. 41. THE CONTRACTOR SHALL MAINTAIN A COMPLETE SET OF THE CONTRACT DRAWNINS, FOR RECORD MARK-UP PURPOSES, THROUGHOUT THE CONTRACT TIME MARK UP THESE DRAWNINGS DURING THE COURSE OF WORK TO SHOW BOTH CHANGES AND ACTUAL INSTALLATION IN SUPPRICIENT FORM TO COMPRESE A COMPLETE RECORD FOR THE OWNER'S PURPOSES, GIME PARTICULAR ATTENTION TO WORK WHICH WILL BE CONCEALED AND DIFFICLIT TO MEASURE AND RECORD AT A LATER ANDE, AND ROWS WHICH MAY REQUIRE SERVICING OR REPLACEMENT DURING THE LIFE OF THE PROJECT. BIND PRINTS INTO MAMAGRABLE STST WITH DURABLE PAPER COVERS LABELED "S—SENDET DRAWNING." J. LIGHTING PHONE: (415) 762-8388 POSSIBLE, U.O.N. OR AGREED TO. "AUJON" SHALL MEAN ACCURATELY LOCATE FINISH FACES IN THE SAME PLANE. "TYPICAL" OR "TYP" SHALL MEAN THAT THE CONDITION IS REPRESENTATIVE OF SIMILAR CONDITIONS THROUGHOUT, UNLESS OTHERWISE NOTED. DETAILS ARE USUALLY KEYED AND NOTED "TYP" ONLY ONCE, WHEN THEY FIRST OCCUR. "SIMILAR" OF "SILL" MEANS CONTRACTORS OF CONTRACTO Long Beach, CA 5255 E. Paoli Way "SMILAR" OR "SMI" MEANS COMPARABLE CHARACTERISTICS FOR CONDITIONS NOTED. VERIFY DIMENSIONS AND ORIENTATION ON PLANS AND ELEVATIONS. WORK AREAS ARE TO REMAIN SECURE AND LOCKBRIE DURING CONSTRUCTION. GC SHALL COORDINATE WITH OWNER TO ENSURE SECURITY. FINAL CLEANING INCLUDES, BUT IS NOT LIMITED TO, CLEANING OF ALL GLASS, GLOSSY SURFACES, FLOORS, DOORS, D each sheet of the contract documents are complementary. What is shown or referred to on each sheet, at a given location shall be provided as though shown on all sheets, u.o.n. MANAGEABLE SETS WITH DURABLE PAPER COVERS LABELED "AS-BUILT DRAWINGS, TRANSMIT TO OWNER. SUBSTITUTIONS, REVISIONS, OR CHANGES SHALL BE SUBMITTED TO ARCHITECT & OWNER (IN CONFORMANCE WITH SPECIFIED PROCEDURES) PRIOR TO PURCHASE, FABRICATION, PROJECT SCOPE VICINITY MAP **DRAFTING SYMBOLS** ON INSTALLATION. THE G.C. SHALL MAINTAIN FOR THE ENTIRE DURATION OF THE WORK ALL EXITS, EXIT LIGHTING, FIRE PROTECTIVE DEVICES AND ALARMS IN CONFORMANCE WITH ALL APPLICABLE CODES AND TO THE SATISFACTION OF LOCAL FIRE MARSHAL. **ACCESSIBILITY NOTES** NOTE: THE FOLLOWING ARE ACCESSIBILITY GUIDELINES AND ARE FOR GC INFORMATION INFORMATION ONLY LISTED ITEMS DO NOT REPLACE OR AMEND FEDERAL STATE. OR LOCAL ALL WORK SHALL BE COORDINATED WITH THE OWNER INCLUDING SCHEDULING TIME AND LOCATIONS FOR DELIVERIES. PROJECT CONSISTS OF REPAIR AND RENOVATION TO EXISTING JUDGING STAND STRUCTURE. LOCATIONS FOR DELIVERIES. 12. THE SCOPE OF WORK AND ADJACENT AREAS (INCLUDING "ACCESSIBLE PATH") SHALL BE PROTECTED FROM ANY DAMAGE THAT OCCURS STEAMS OF THIS WORK. ANY DAMAGE THAT OCCURS STALL BE THE FINANCIAL RESPONSIBILITY OF THE GC. 3. ALL MANUFACTURED ARTICLES, MATERIALS AND EQUIPMENT SHALL BE APPLIED, INSTALLED, CONNECTED, ERECTED, CLEANED, AND CONDITIONED PER MANUFACTURER'S INSTRUCTIONS. IN THE CASE OF DIFFERENCES BETWEEN THE MANUFACTURER'S INSTRUCTIONS. AND THE CONTRACT DOCUMENTS, THE GC SHALL NOTIFY THE ARCHITECT AND OWNER BEFORE PROCEEDING. 14. THE GC SHALL HAVE A FULL-TIME REPRESENTATIVE AT ALL TIMES WHILE CONSTRUCTION ACTIVITIES ARE UNDERWAY ON-SITE. 3. AT COMPLETION OF PROCECED CONTRACTOR, ARCHITECT AND OWNER SHALL MEET, PLAN IDENTIFICATION ES. GC SHALL ALLOW FOR APPLIED FINISH DIMENSIONS IN ADDITION TO STANDARD CONSTRUCTION TO GLERANCES IN ACHIEVING ALL ACCESSIBILITY CLEARANCES PER DRAWINGS AMD/OR TITLE 24 QUIDELINES. ABRUPT CHANGES IN LEVEL ALONG ANY ACCESSIBLE ROUTE SHALL NOT EXCEED 1/2". WHEN THESE CHANGES DO OCCUR, THEY SHALL BE BEVELLED WITH A SLOPE NO GREATER THAN 12, EXCEPT LEVEL CHANGES NOT EXCEEDING 1/4" VERTICAL. AXX SCOPE TO INCLUDE REPAIR / REPLACEMENT OF SELECT STRUCTURAL ELEMENTS. PROJECT ADDS NO NEW AREA TO EXISTING 270 S.F. STRUCTURE DETAIL IDENTIFICATION - SHEET WHERE DETAIL IS LOCATED PROJECT DATA INTERIOR ELEVATION FLEVATION IDENTIFICATION SHEET WHERE ELEVATION IS LOCATED PROJECT ADDRESS: 5255 E. PAOLI WAY, LONG BEACH, CA 90803 AT COMPLETION OF PROJECT, CONTRACTOR, ARCHITECT AND OWNER SHALL MEET, INSPECT RINISHED WORK, AND PREPARE IF NECESSARY A FINAL PUNCH-LIST OF ITEMS TO BE REMEDIED BY THE CONTRACTOR. NOTE: ARROW/CARROT INDICATES ELEVATION DRAWN NUMBER OR STORIES 1 STORY **DEMOLITION NOTES** CONTRICTOR SHALL FAMILIARIZE FIRMSELVES WITH ALL RULES, REGULATIONS AND SPECIFICATIONS, INCLUDING, BUT NOT LIMITED TO, ACCESS HOURS, NOSE RESTRICTIONS AND OTHER TEXES THAT MAY IMPACT SCHEDULE OR COST. ALL SUCH FACTORS SHALL BE INCLUDED IN ALL BIDS AND PRICING. ISSUE INFORMATION 270 S.F STRUCTURE AREA: **ELEVATION IDENTIFICATION** PROVIDE TRAINED, EXPERIENCED, FULL-TIME, ON-SITE SUPERVISION DURING THE PROGRESS OF DEMOLITION OPERATIONS. SHEET WHERE ELEVATION IS LOCATED NOTE: ARROW/CARROT INDICATES ELEVATION DRAWN Issue PROGRESS OF DEMOCITION OPERATIONS. COMPLY WITH APPLICABLE LOCAL, STATE, AND FEDERAL CODES AND REGULATIONS PERTANNING TO SAFETY OF PERSONS, PROPERTY AND ENVIRONMENTAL PROTECTION. REPAIR ALL DEMOLITION PERFORMED IN EXCESS OF THAT REQUIRED, AT NO COST TO THE CONTRACTOR SHALL BE RESPONSIBLE FOR DISTRIBUTION OF DRAWINGS TO ALL TRADES UNDER HIS/HER JURISDICTION. PLAN CHECK CLARIFICATIONS CLIENT REVISIONS TRADES UNDER HIS/HER JURISDICTION. HE CONTROCTOR SHALL NOT PROCEED WITH ANY WORK REQUIRING ADDITIONAL COMPENSATION BEYOND THE CONTRACT AMOUNT WITHOUT AUTHORIZATION IN WRITING FROM THE ARCHITECT OR CLIENT'S AGENT. FAILURE TO OBTAIN AUTHORIZATION SHALL INVALIDATE ANY CLIMI FOR ADDITIONAL COMPENSATION. UPON COMPLETION OF WORK, OR SHORTLY BEFORE, THE CONTRACTOR SHALL PERPARE A COMPREHENSIVE UST OF THEMS TO BE COMPLETED OR CORRECTED AND SUBMIT IT TO THE ARCHITECT PRIOR TO THE ARCHITECT'S OWN PUNCH LIST. SECTION IDENTIFICATION SHEET WHERE SECTION IS LOCATED OWNER. REMOVE TOOLS AND EQUIPMENT FROM SITE UPON COMPLETION OF WORK, LEAVE CONTRACT AREAS AND SITE BROOM CLEAN, ORDERLY, AND IN A CONDITION ACCEPTABLE FOR NEW OR OTHER CONSTRUCTION ON A DAULY BASIS. PRIOR TO COMMENCING WORK, CONTRACTORS SHALL VERIFY WITH ARCHITECT & OWNER ITEMS TO BE SALVAGED FROM DEMOLITION. - REVISION NUMBER REMOVE ALL CONSTRUCTION SHOWN TO BE DEMOLISHED OR NOT TO BE REUSED. THE CONTRACTOR AND SUBCONTRACTORS SHALL VERIFY THE LAYOUT WITH ARCHITECT IN THE FIELD BEFORE PROCEEDING WITH CONSTRUCTION. PATH OF TRAVEL PATCH AND REPAIR ALL SURFACES AFFECTED BY DEMOLITION AND CONSTRUCTION. TO ROOM IDENTIFICATION NUMBER INE NELD BEFORE PROCEEDING WITH CONSTRUCTION. CONTRACTOR SHALL VERIEY THAT NO CONFLICTS EXIST IN LOCATIONS OF ANY AND ALL BECTROAL, LIGHTING, PLUMBING, AND SPRINKLER EQUIPMENT AND THAT ALL REQUIRED CLEARANCES FOR INSTALLATION AND MAINTENANCE ARE PROVIDED. CONTRACTOR TO NOTIFY ARCHITECT AND OWNER IN WRITING IF CONFLICTS DUST. ROOM NAME GENERAL CONTRACTOR TO FOLLOW ALL REQUIREMENTS OF THE APPLICABLE LOCAL CITY DEMOLITION AND CONSTRUCTION RECYCLING PLAN. SITE -SEE SHEET A O1 FOR EXISTING PATH OF TRAVEL. - ROOM NUMBER 101 (5255 E. Paoli Way) CONTRACTOR SHALL PROVIDE PROTECTION TO ALL EXISTING FINISHES. THE CONTRACTOR SHALL BE RESPONSIBLE FOR REPAIRING ANY DAMAGE CAUSED THEREIN DURING CONSTRUCTION. -(1)CONSTRUCTION. 22. CONTRACTOR SHALL COMPLY WITH ALL APPLICABLE LAWS, REGULATIONS, ORDINANCES AND SHALL TAKE ALL APPROPRIATE SAFETY PRECAUTIONS IN PERFORMING THE WORK. 23. CALFORNIA ADMINISTRATIVE CODE TITLE 24, SECTION T—20, LATEST EDITION, HAS BEEN REVEWED. THE DESIGN SUBMITTED FOR THE BUILDING PERMIT SUBSTANTIALLY CONFORUS TO THESE REGULATIONS. (101) A DOOR TAG SHEET INDEX **ABBREVIATIONS CONSTRUCTION NOTES** REVEWED. THE DESIGN SUBJITTED FOR THE BUILDING PERMIT SUBSTANTIALLY CONFORMS TO THESE REGULATIONS. 24. EJECUTE WORK IN ACCORDANCE WITH ANY AND ALL APPLICABLE CODES, MANAGEACUTERES' RECOLUMENDATIONS, AND TRADE AND REFERENCE STANDARDS, HICLUBING BUT NOT LIMITED TO CALIFORNIA DURFORM BUILDING, MECHANICAL, ELECTRICAL, PLUMENIA RADO FREE CODES AND LOCAL ARROMANTIA SHERE APPLICABLE, NEC. NPC, NFPA, ASME, ANSI, MARRICAMS WITH DESABILITIES ACT, AND OTHER APPLICABLE REGULATORY AJMINORITIES LATEST ENFORCED EDITIONS. 25. MECHANICAL AND ELECTRICAL SCOPE OF WORK SHALL BE DONE IN COMPLIANCE WITH 2013 TITLE 24, SECTION 6, CALIFORNIA HERBOY EFFICIENCY STANDARDS FOR RESIDENTIAL AND MONRESDIENTIAL BUILDINGS. 26. WHEN REQUIRED, PLUMENCE DENDERS TO PREPARE MECESSARY PLUMENC PRAWNINGS, INCLUDING BUT NOT LIMITED TO WATER, CAS, WASTE AND VEHT, WATER SUPPLY CALCULATIONS, INVOLUMENTAL BUILDINGS. SHOULDING, LIVED AND ADDRESS TO ATTEMPT AND ADDRESS AND ATTEMPT AND ADDRESS TO ATTEMPT AND ADDRESS AND ATTEMPT AND ADDRESS TO ATTEMPT AND ADDRESS AND ATTEMPT AND ADDRESS THE CHRISTIAN AND ADDRESS AND ATTEMPT AND ADDRESS AND ADDRESS THE COURTE WIRKS AND ADDRESS AND ATTEMPT AND ADDRESS AND ATTEMPT AND ADDRESS AND ATTEMPT AND ADDRESS AND ATTEMPT AND ADDRESS THE ADDRESS AND ATTEMPT AND ADDRESS AND ATT ALL WORK SHALL BE INSTALLED PLUMB, LEVEL, SQUARE AND TRUE, AND IN PROPER ALIGNMENT. THE CONTRACTOR SHALL PROVIDE LINE AND GRADE MARKINGS ON THE FINISH FLOOR FOR RECTIFIEND UNIEVEL FLOOR CONDITIONS. ANY FLOOR OUT OF LEVEL WORE THAN \$\frac{1}{2}"\$ IN 10'-0" SHALL BE MADE TO BE LEVEL OVER THE ENTIRE DISTANCE. ARCHITECTURAL DRAWINGS PROJECT INFORMATION / GENERAL NOTES ADA DETAILS SITE PLAN DEMOLITION PLAN & NEW FLOOR PLAN EXTERNION PLAN & NEW FLOOR PLAN DIMENSIONS NOTED "CLEAR" OR "CLR" ARE MINIMUM REQUIRED DIMENSIONS AND CLEARANCE MUST BE ACCURATELY MAINTAINED TO WITHIN $+-\frac{1}{8}$ ". EXTERIOR ELEVATIONS ENLARGED PLAN AND ELEVATION, DETAILS Hose Bibb Hollow Core Hardwood Hardware Hollow Meta Horizontal Hour Height DETAILS COLOR ELEVATIONS East Each Expansion Joi Elevation Elevation Elevator Emergency Enclosure Electrical Pan Equipment Exposed Expansion Exterior CLIENT STRUCTURAL DRAWINGS PRCST PL P.LAM PLAS PLYWD PR PT PTD P.T.D./R S 1.0 GENERAL STRUCTURAL NOTES, PLAN, DETAILS CITY OF LONG BEACH ELEC ELEV EMER ENCL E.P. EQ EQPT EXPO EXP EXP Tread Towel Bar Top of Curb Telephone Terrazzo Tongue and Groove Thick Top of Pavement Toilet Paper Dispen Television Top of Woll Typical ELECTRICAL DRAWINGS 333 W. OCEAN BOULEVARD LONG BEACH, CA 90802 Janitor Dispenser & Receptacle Partition Paper Towel Receptacle CIVIL DRAWINGS 1 RIP RAP PLAN PTN P.T.R. Extendor Fire Alarm Flot Bor Floor Droin Foundation Fire Extinguishe Fire Extinguishe Fire Extinguishe Flinish Floor Flinish Floor Flinish Floor Flinish Floor Fluorescent Face of Concre Face of Flinish Face of Studs Flinish Surce Foot or Feet Footing Furring Future Q.T. Quarry Tile PROJECT DIRECTORY PROJECT TITLE R RAD R.D. REF REFR REINF REQ RESIL RM R.O. RWD R.W.L. DO NOT SCALE DRAWINGS; DIMENSIONS SHALL GOVERN. DETAILS SHALL GOVERN OVER PLANS AND ELEVATIONS. Cabinet Catch Basin Cernent Ceramic Cast Iron Corner Guar Ceiling Caulking Closet Clear Counter Cosed Open Concrete Connection Construction Continuous Corridor Carpet Center 3S JUDGING STAND PLANS AND ELEVATIONS. THE CONTRACTOR SHALL NOT BE RELEVED OF ANY CONTRACT RESPONSIBILITY RESULTING FROM ARCHITECT'S FAILURE TO DETECT SHOP DRAWING ERRORS AND OMISSIONS IN CONTRACTOR AT THE CONTRACT DOCUMENTS. CONTRACTOR SHALL PROMDE, AT THE END OF THE PROJECT, TWO BOUND SETS OF PRODUCT INFORMATION FOR ALL MATERIALS, FINISHES, COUPMENT, AND FIXTURES INCLUDING ALL WARRANTY INFORMATION, AND THE PROJECT, AS WELL AS PRODUCT DATA AND MANUALS PROVIDED BY EQUIPMENT MANUFACTURER. Maximum Mechanical Membrane Metal Manufacturer Manhole Minimum Mirror Miscellaneous Masonry Openin Metal Threshold Mounted Mullion CITY OF LONG BEACH TIDELANDS CAPITAL IMPROVEMENT DIVISION 333 W. OCEAN BLVD. RENOVATION Vinyl Composition Tile Vertical Vestibule Verify In Field 5255 F. PAOLI WAY LONG BEACH, CA 90802 ARCHITECT 31. REPORT ANY HAZARDOUS MATERIALS ENCOUNTERED TO THE OWNER/ARCHITECT. LONG BEACH, CA 90802 PH: 562.733.3637 / 415.762.8388 X16 CONTACT: W. GARY LAMB, AIA ALL WORK SHALL BE PLUMB, SQUARE, LEVEL, IN PROPER ALIGNMENT, AND SECURELY FASTFMED. SHEET TITLE THE GENERAL CONTRACTOR SHALL COORDINATE THE WORK OF ALL SUBCONTRACTORS. 33. THE GENERAL CONTRACTOR SHALL COORDINATE THE WORK OF ALL SUBCONTRACTORS. 34. ALL WORK SHALL BE DONE IN CONFORMANCE WITH ALL APPLICABLE FEDERAL, STATE, COUNTY AND CITY ORDINANCES AND BUILDING CODES, AND REQUIREMENTS ESTABLISHED BY STATE AND LOCAL FIRE MARSHALS. IN CASE OF CONFLICT, MOST STRINGENT REQUIREMENTS SHALL INCLIDE THE COST OF PROPER INSURANCE AS REQUIRED BY STATE AND LOCAL LAWS. NATIONAL BUILDING REGULATIONS OR CODES TO ADEQUIATELY PROTECT PERSONS AND PROPERTY. A COPY OF SUCH INSURANCE COMERGE SHALL BE FURNISHED TO THE OWNER AND LANGLORD PRIOR TO COMMENCEMENT OF ANY WORK. 35. THE CONTRACTOR SHALL BE RESPONSIBLE FOR DESIGN, COORDINATION AND EXECUTION OF CONSTRUCTION METHODS AND PROCEDURES AND PROVIDE PEDESTRIAN PROTECTION AS REQUIRED FOR SHETY OF TENANTS, PEDESTRIANS AND JOSSITE PERSONNEL. 37. THE GENERAL CONTRACTOR SHALL PREPARE AND SUBMIT, BEFORE STARTING WORK, A SCHEDULE INDICATING REQUIRED CONSTRUCTION TIME FOR EACH TRADE'S WORK. **PROJECT INFO** NS STRUCTURAL ENGINEERING 4642 ROCKLAND PLACE LA CANADA FLINTRIDGE, CA 91011 PH: 626.840.2338 CONTACT: NEAL SHAH, PE, SE STRUCTURAL FI FCTRICAL P2S ENGINEERING F25 ENGINCERING 5000 E. SPRING STREET, 8TH FLOOR LONG BEACH, CA 90815 PH: 562.497.2999 CONTACT: RUDY BORJA JMC2 CML ENGINEERING 411 NORTH HARBOR BOVD. SUITE 201 SAN PEDRO, CA 90731 PH: 310,241.6550 X241 CONTACT: FELIX SIN, PE CIVIL: VERIFY ACCESS TO JOB SITE. VEMBY ACCESS TO QUIESTIE. SHOP DRAWINGS, AND PRODUCT DATA TO ARCHITECT FOR REVIEW PRIOR TO PURCHASE OR FABRICATION. ALLOW ARCHITECT ONE WEEK TO REVIEW AND COMMENT. ARCHITECTS REVIEW WILL BE IN COMPORTANCE WITH DESIGN CONCEPT ONLY. CONTRACTOR SHALL REVIEW ALL SUMITIALS FOR CONFORMANCE WITH CONTRACT DOCUMENTS PRIOR TO SUBMITING THEM FOR ARCHITECTS REVIEW. PROJECT NO. GEOCON WEST, INC. 3303 N. SAN FERNANDO BLYD. SUITE 100 BURBANK, CA 91504 SOILS: AFT-13-082 G 01 PH: 818.841.8388 CONTACT: NEAL BERLINER, GE SCALE

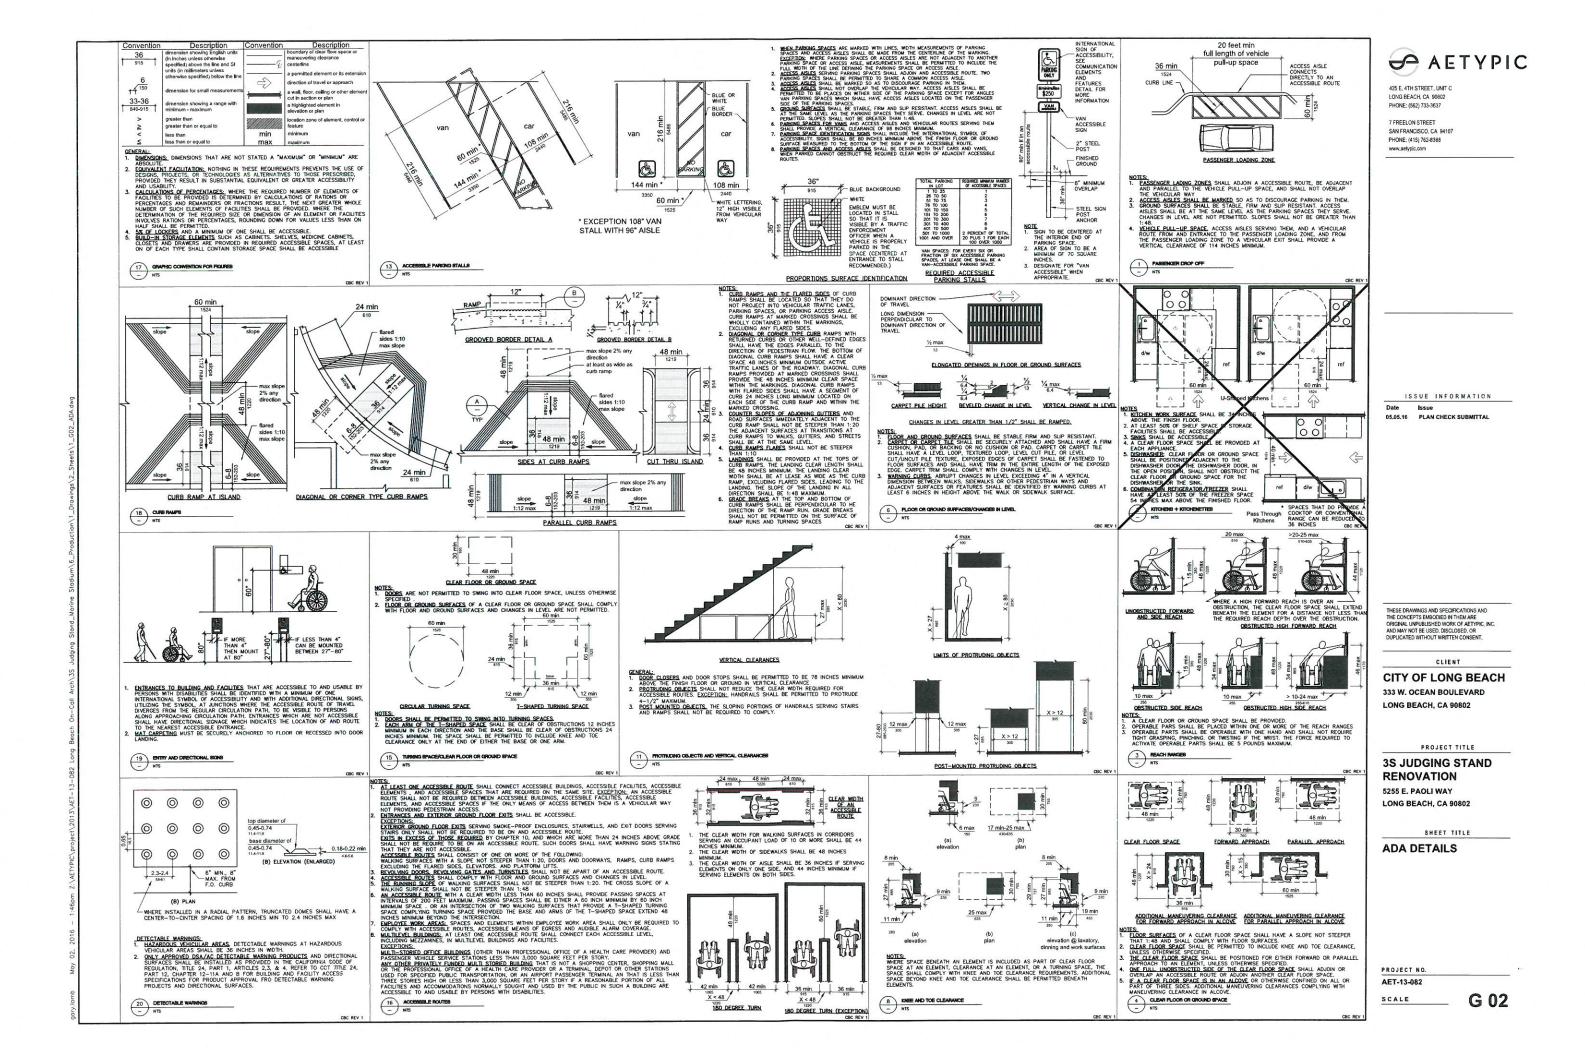

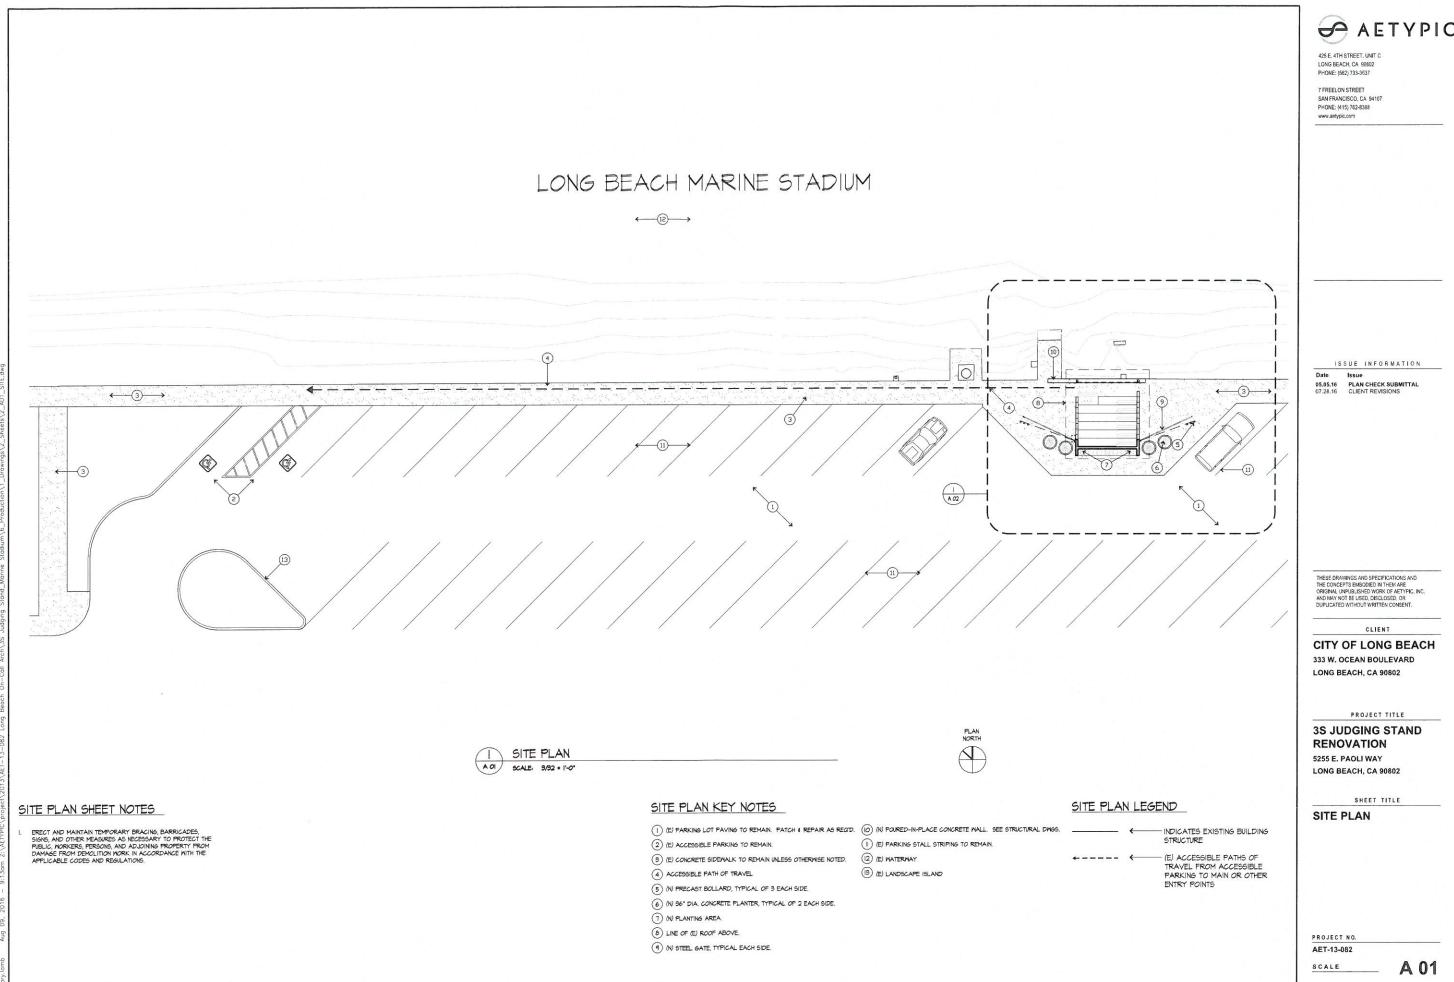

AETYPIC

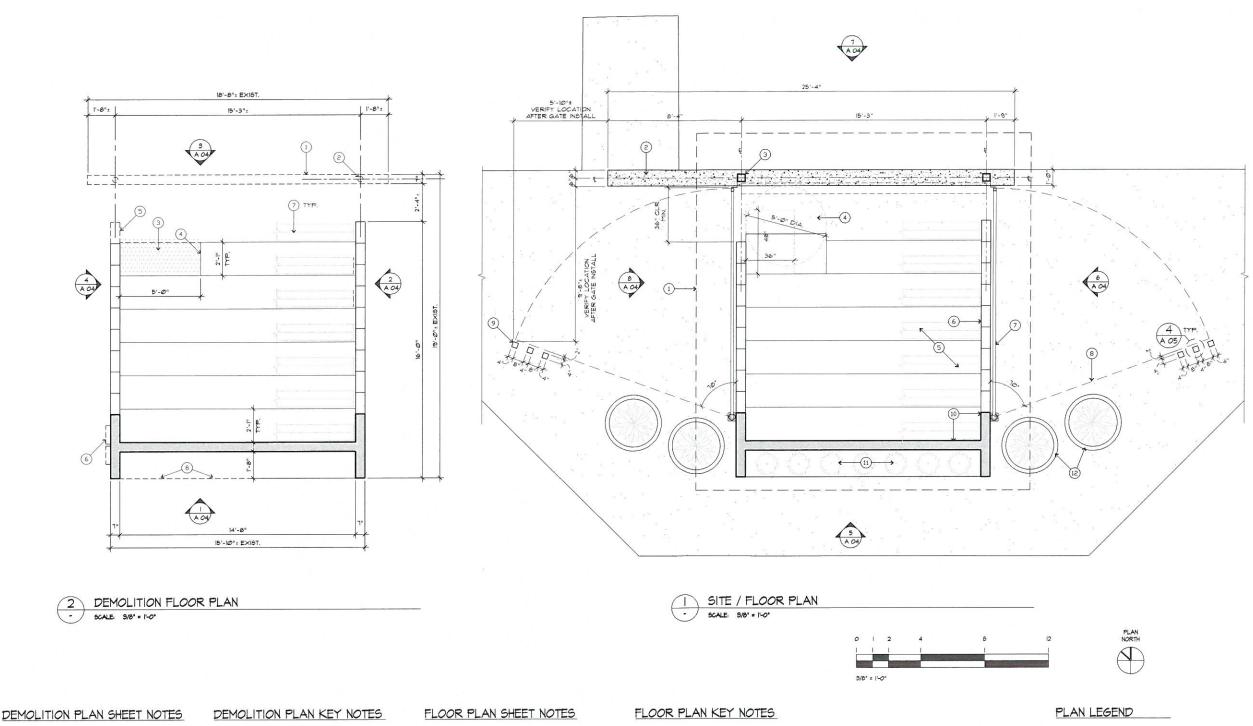

€ AETYPIC

425 E. 4TH STREET, UNIT C LONG BEACH, CA 90802 PHONE: (562) 733-3637

7 FREELON STREET SAN FRANCISCO, CA 94107 PHONE: (415) 762-8388

ISSUE INFORMATION Date Issue

05.05.16 PLAN CHECK SUBMITTAL 05.09.16 PLAN CHECK CLARIFICATIONS 07.28.16 CLIENT REVISIONS

CLIENT

CITY OF LONG BEACH 333 W. OCEAN BOULEVARD LONG BEACH, CA 90802

PROJECT TITLE

3S JUDGING STAND RENOVATION 5255 F PAOLI WAY LONG BEACH, CA 90802

SHEET TITLE

FLOOR PLAN

= = EXISTING TO BE REMOVED

EXISTING TO REMAIN

PROJECT NO. AET-13-082

SCALE

3/8" = 1'-0"

A 02

ERECT AND MAINTAIN TEMPORARY BRACING, BARRICADES, SIGNS, AND OTHER MEASURES AS NECESSARY TO PROTECT THE FUBLIC, WORKERS, PERSONS, AND ADJOINING PROPERTY FROM DAMAGE FROM DEMOLITON WORK IN ACCORDANCE WITH THE APPLICABLE CODES AND REGULATIONS.

(1) (E) CONCRETE MASONRY WALL TO BE REMOVED.
(2) PORTION OF (E) STEEL COLUMN TO BE REMOVED, SEE STRUCTURAL PRAYINGS.

1. CONTRACTOR SHALL REMOVE ALL DEBRIS RELATED TO CONSTRUCTION.
(2) PORTION OF (E) STEEL COLUMN TO BE REMOVED, SEE STRUCTURAL PRAYINGS.

1. CONTRACTOR SHALL REMOVE ALL DEBRIS RELATED TO CONSTRUCTION.
(3) PORTION OF (E) STEEL COLUMN TO BE REMOVED, SEE STRUCTURAL PARKET OF RECOMMENDATIONS.

3 PORTION OF (E) CONCRETE STEP TO BE REMOVED TO PROVIDE WHEELCHAIR ACCESSIBLE VIEWING AREA.

4 SHORE (E) CONCRETE BENCH/STEP AS REQUIRED WHEN REMOVING PORTION OF ADJACENT CONCRETE.

5 PORTION OF (E) CONCRETE MASONRY WALL TO BE REMOVED. SEE EXTERIOR ELEVATIONS, SHEET A 04.

(6) (E) ELECTRICAL PULL BOXES TO BE REMOVED. SEE ELECTRICAL DRAWINGS.

(E) WOOD BENCHES TO BE REMOVED. BENCH BRACKETS TO BE PROTECTED FOR REUSE.

(6) REMOVE PORTION OF (E) SIDEMALK FOR (N) PLANTING AREA.

2) NEW POURED-IN-PLACE CONCRETE WALL, SEE STRUCTURAL DRAWINGS.

(3) NEW STEEL SUPPORT COLUMN, SEE STRUCTURAL DRAWINGS.

LINE OF (E) ROOF ABOVE

DASHED LINE INDICATES REQUIRED CLEARANCES AT WHEELCHAIR ACCESSIBLE VIEWING AREA, SEE 4/6 02.

 $\stackrel{\textstyle (5)}{}$ NEW 2 \times 6 CUMARU BENCH ANCHORED TO EXISTING STEEL SUPPORTS, EXISTING SUPPORTS TO BE PAINTED.

6 EXISTING STEPPED CONCRETE MASONRY WALL TO REMAIN. EXISTING WALLS TO BE PAINTED, SEE FINISH PLAN A 03.

7) NEW STEEL SECURITY GATE, SEE | \$ 2/A 05.


8 DASHED LINE INDICATES LOCATION OF GATE IN OPEN POSITION.

(1) NEW STEEL BOLLARD (HUNTCO 5" SQUARE, 45" TOP, IN-GROUND, NOT DIPPED GALVANIZED FINISH) TYPICAL OF 6. BOLLARD INSTALL ARTION START POINT, TYPICAL EACH SIDE. COORDINATE SIDEWALK CLEARANCES WITH SITE PLAN, I/A OI.

(IO) EXISTING FULL HEIGHT CONCRETE MASONRY WALL TO REMAIN.

(I) NEW PLANTING AREA WITH 7 - 5 GAL. ECHIUM FASTUOSUM. PROVIDE IRRIGATION AS REQUIRED.

(2) NEW 36* DIA. CONCRETE PLANTERS. (QUIK CRETE PRODUCTS CORPORATION MODEL *OR-CAL3622P) TYPICAL OF 4.
I - IO GAL. EUPHORBIA TIRUCALLI PER PLANTER, PROVIDE IRRIGATIONI AS REQUIRED.

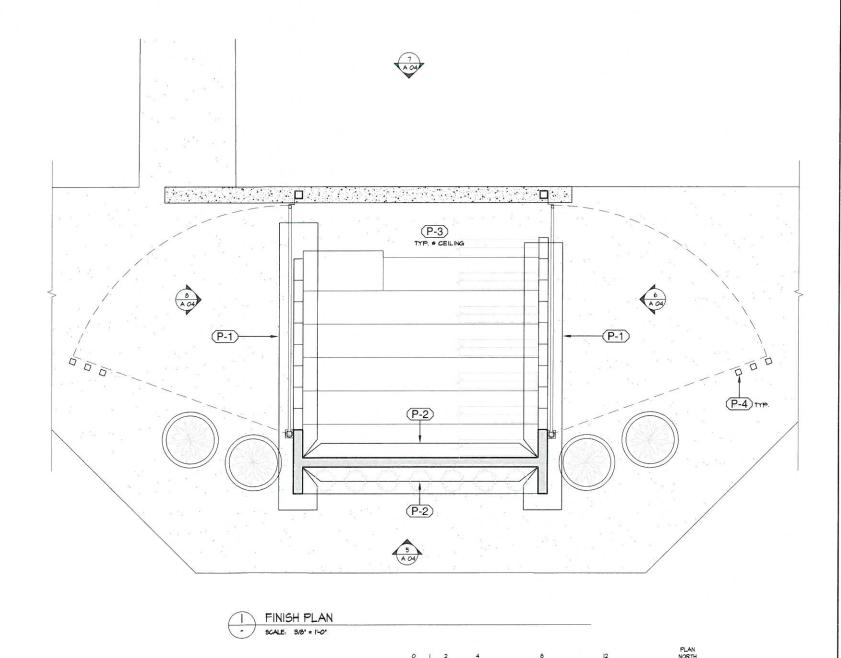

3/8" = 1'-0"

FINISH PLAN SHEET NOTES

- I. ALL EXISTING CONCRETE MASONRY WALLS TO RECEIVE EXTERIOR ESGSHELL FINISH.
 2. ALL EXISTING SURFACES TO BE POWER WASHED AND PREFARED FOR APPLICATION OF NEW FINISHES.
 3. CONTRACTOR TO PROVIDE ARCHITECT WITH A MINIMAM OF THREE SAMPLES OF EACH FINISHMATERIAL FOR APPROVAL PRIOR TO ORDERING AND INSTALLATION.
 4. ALL DARK PAINT COLORS TO RECEIVE UNDERCOAT.
 5. CONTRACTOR TO PROVIDE MANIFACTURERS USE AND CARE MANIALS FOR ALL FINISH PRODUCTS.

FINISH PLAN KEY NOTES

- EXISTING BENCH BRACKETS TO BE CLEANED AND PAINTED WITH SEMI-GLOSS PAINT.
- (2) FINISHES AT EXISTING CONCRETE WALKWAY TO BE CLEANED AS REQUIRED.
- 3) CONCRETE FINISH AT (N) WHEELCHAIR ACCESSIBLE AREA TO MATCH EXISTING.
- 4) ALL (N) EXPOSED STEEL TO BE GALVANIZED, UN.O.

MATERIAL	ITEM	MANUFACTURER	STYLE / COLOR	NOTES	
PAINT	(P-1)	SHERMIN MILLIAMS	SM 7046 - ANONYMOUS	MASONRY WALLS	
PAINT	(P-2)	SHERWIN WILLIAMS	SM 7042 - MORLDLY GRAY	MASONRY WALLS	
PAINT	(P-3)	SHERWIN WILLIAMS	SM 7042 - SHOJI WHITE	CEILING, CONCRETE BEAM	
PAINT (GALVANIZING COMPOUND)	(P-4)	ZRC WORLDWIDE mmn.zrcmorldmide.com	ZRC 22I COLD GALVANIZING COMPOUND	MISCELLANEOUS STEEL	
	+				



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ISSUE INFORMATION

05.05.16 PLAN CHECK SUBMITTAL 07.28.16 CLIENT REVISIONS

THESE DRAWINGS AND SPECIFICATIONS AND THE CONCEPTS EMBODIED IN THEM ARE ORIGINAL UNPUBLISHED WORK OF AETYPIC, INC. AND MAY NOT BE USED, DISCLOSED, OR DUPLICATED WITHOUT WRITTEN CONSENT,

CLIENT

CITY OF LONG BEACH 333 W. OCEAN BOULEVARD LONG BEACH, CA 90802

PROJECT TITLE

3S JUDGING STAND RENOVATION 5255 E. PAOLI WAY LONG BEACH, CA 90802

SHEET TITLE


FINISH PLAN

AET-13-082 SCALE


3/8" = 1'-0"


A 03


PROJECT NO.

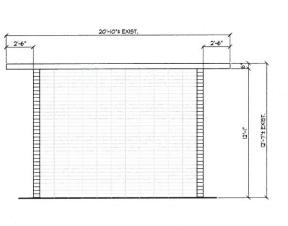



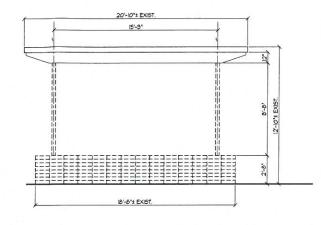

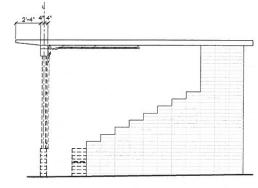

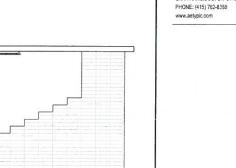



SOUTH ELEVATION (DEMOLITION) A 04 SCALE: 1/4" = 1'-0"


2 A 04 EAST ELEVATION (DEMOLITION) SCALE: 1/4" = 1'-0"

3 NORTH ELEVATION (DEMOLITION) SCALE: 1/4" = 1'-0"

4 WEST ELEVATION (DEMOLITION) A 04 SCALE: 1/4" = 1'-0"

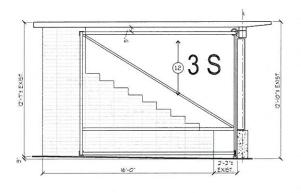

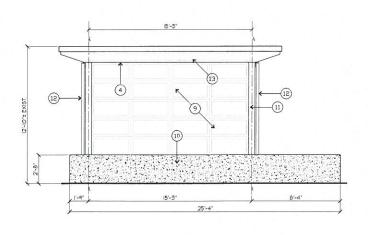

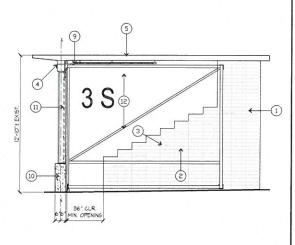

5 SOUTH ELEVATION (NEW)
A 04 SCALE: 1/4" = 1'-0"

EAST ELEVATION (NEW) A 04 SCALE: 1/4" = 1-0"

NORTH ELEVATION (NEW) SCALE: 1/4" = 1'-0"

WEST ELEVATION (NEW) SCALE: 1/4" = 1'-0"

1/4" = 1'-0"

ELEVATION SHEET NOTES

ERECT AND MAINTAIN TEMPORARY BRACING, BARRICADES, SIGNS, AND OTHER MEASURES AS NECESSARY TO PROTECT THE PUBLIC, WORKERS, ERESONS, AND ADJOINNS PROPERTY FROM DAMAGE FROM DEMOLITION WORK IN ACCORDANCE WITH THE APPLICABLE CODES AND REGULATIONS.

ELEVATION KEY NOTES

(I) (E) CONCRETE MASONRY WALL TO REMAIN.

2 LINE OF (E) CONCRETE STEP BEYOND.

3 LINE OF (E) BENCH SEAT BEYOND. (E) CONCRETE BEAM TO REMAIN.

(5) (E) CONCRETE ROOF TO REMAIN.

6 PORTION OF (E) STEPPED CONCRETE MASONRY WALL TO BE REMOVED AT GROUT LINE.

(1) (E) CONCRETE MASONRY WALL TO BE REMOVED COMPLETELY.

(b) PORTION OF (E) STEEL COLUMN TO BE REMOVED. SEE STRUCTURAL DRAWINGS FOR EXTENT.

(N) ROLL-UP GARAGE DOOR, SEE I/A 06.

(IO) (N) POURED-IN-PLACE CONCRETE WALL, SEE STRUCTURAL DRAWINGS.

(II) (N) STEEL COLUMN AND GATE CLOSURE ANGLES, SEE | & 2/A 02 AND STRUCTURAL DRAWINGS.

(12) (N) STEEL SECURITY GATE, TYPICAL. SEE I & 2/A 02.

(B) DASHED LINE INDICATES LINE OF (N) ROLL-UP GARAGE DOOR BEYOND.

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ISSUE INFORMATION

05.05.16 PLAN CHECK SUBMITTAL 07.28.16 CLIENT REVISIONS

AETYPIC

425 E. 4TH STREET, UNIT C LONG BEACH, CA 90802 PHONE: (562) 733-3637 7 FREELON STREET SAN FRANCISCO, CA 94107

CLIENT

CITY OF LONG BEACH 333 W. OCEAN BOULEVARD LONG BEACH, CA 90802

PROJECT TITLE

3S JUDGING STAND RENOVATION 5255 E. PAOLI WAY

LONG BEACH, CA 90802

SHEET TITLE


ELEVATIONS


PROJECT NO.

AET-13-082 SCALE

1/4" = 1'-0"

A 04

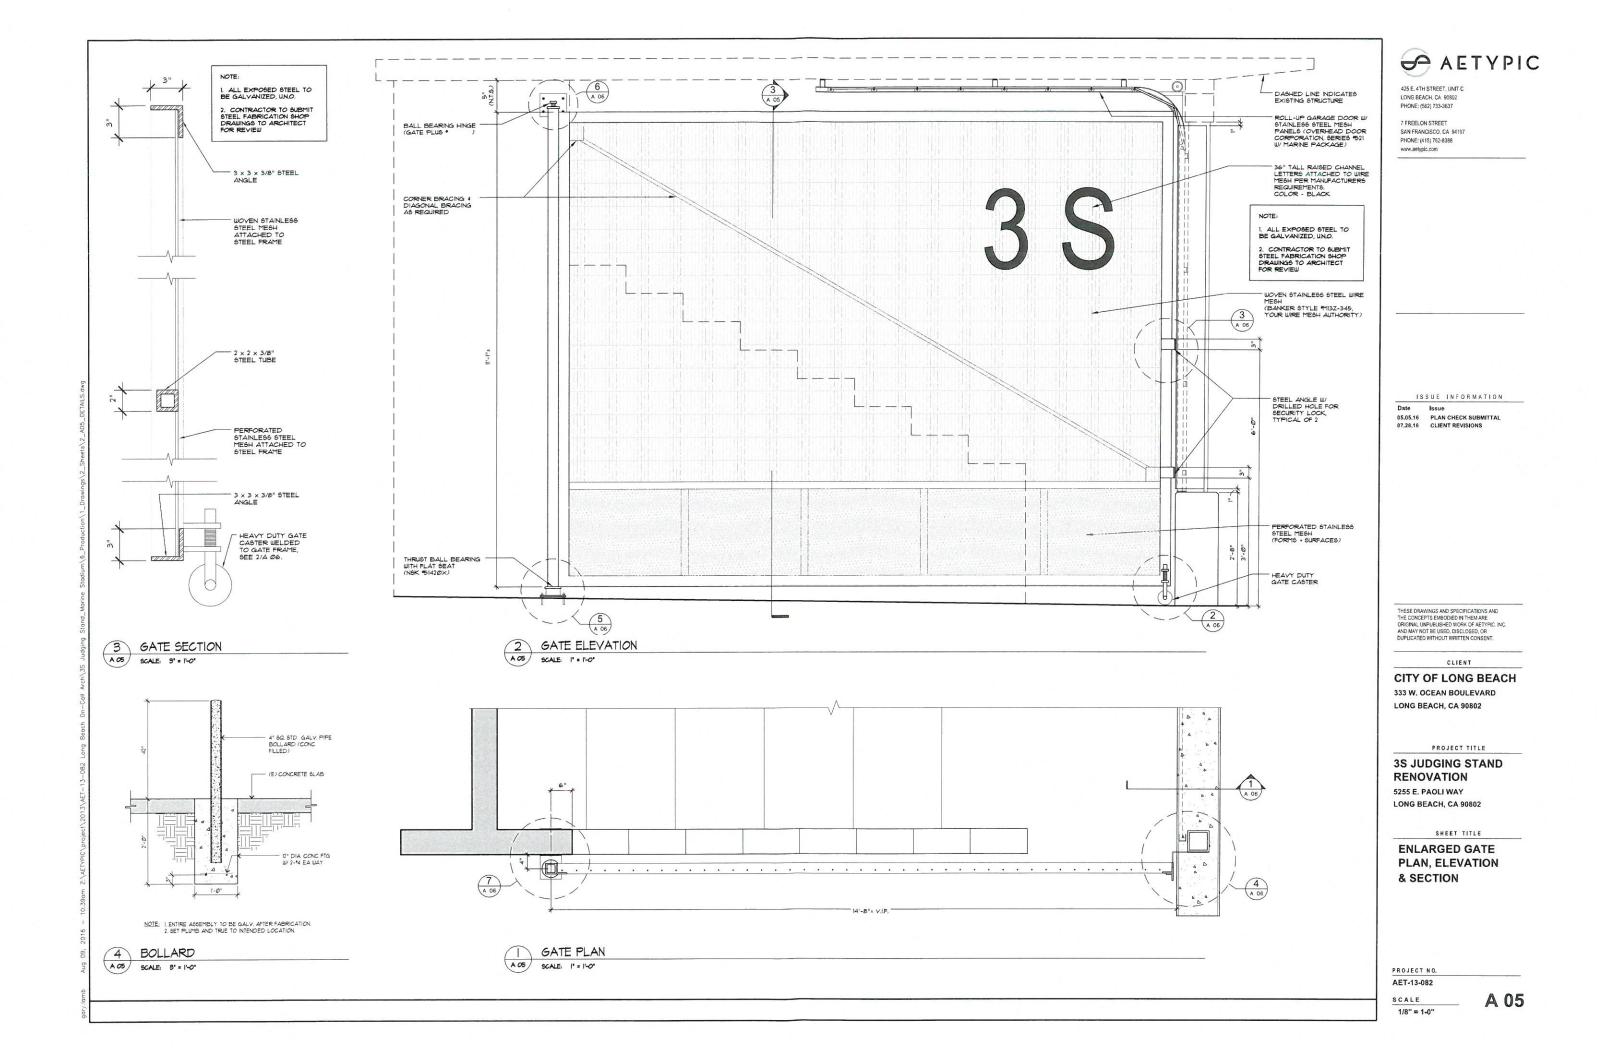

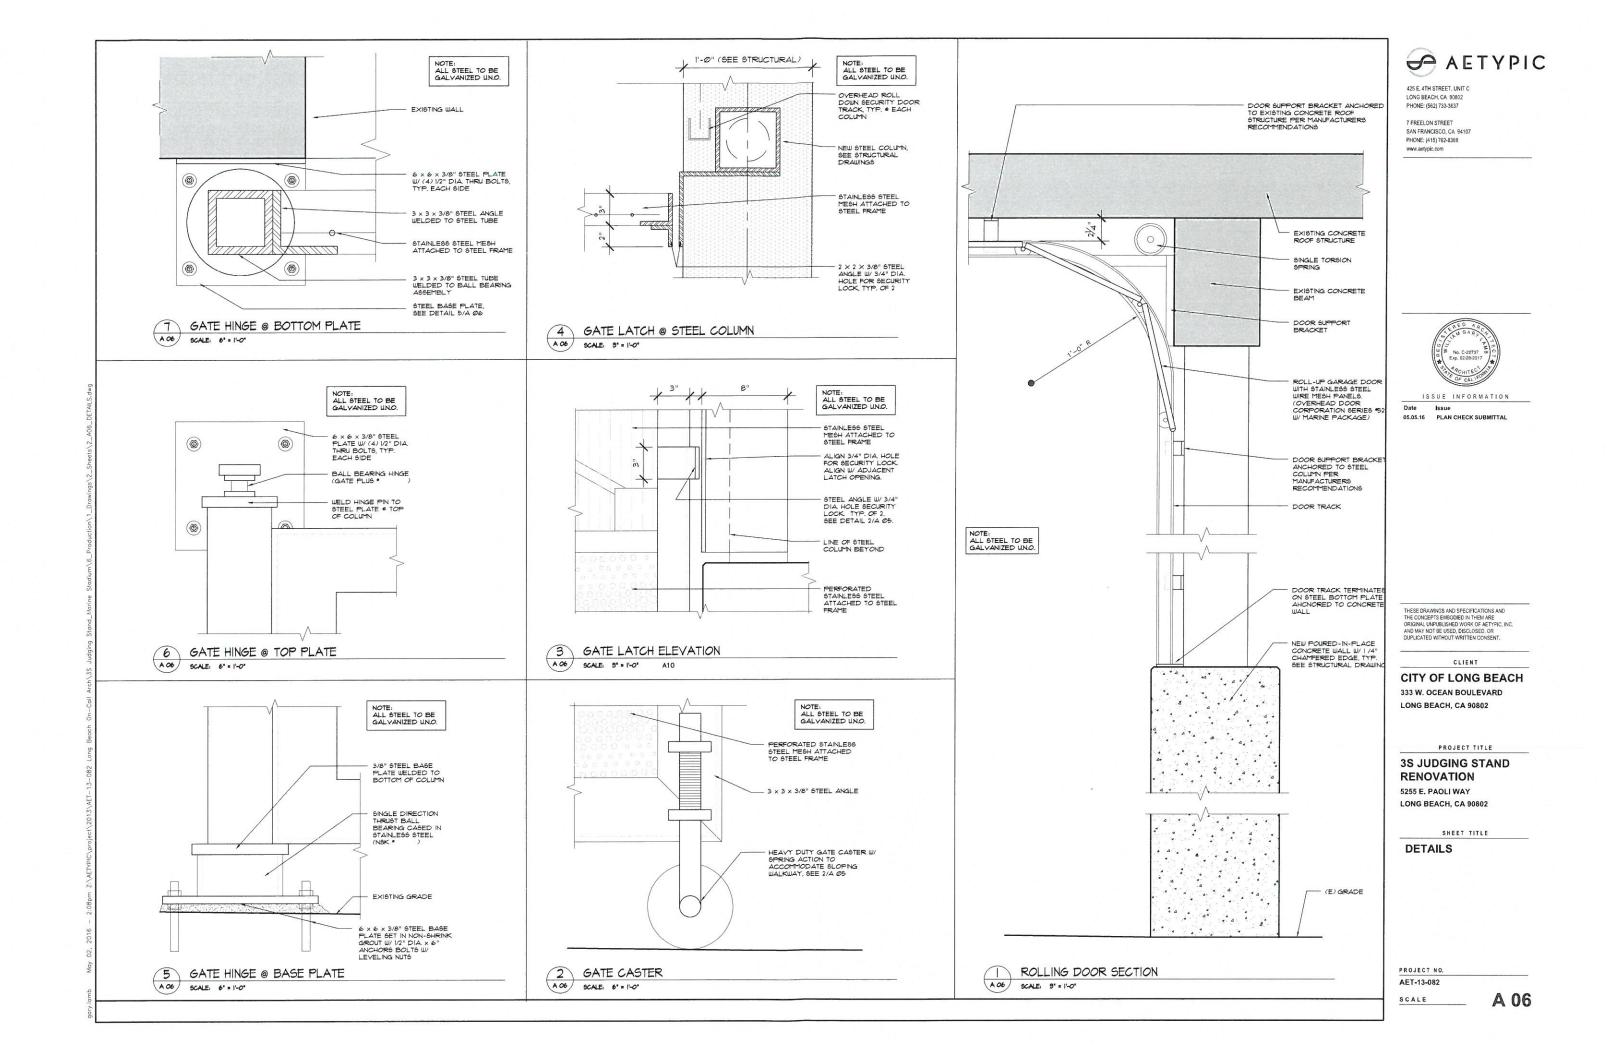




(IO) (N) POURED-IN-PLACE CONCRETE WALL, SEE STRUCTURAL DRAWINGS.

(II) (N) STEEL COLUMN AND GATE CLOSURE ANGLES, SEE I & 2/A 02 AND STRUCTURAL DRAWINGS.


(2) (N) STEEL SECURITY GATE, TYPICAL. SEE | \$ 2/A 02.

(B) DASHED LINE INDICATES LINE OF (N) ROLL-UP GARAGE DOOR BEYOND.

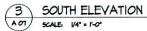

ELEVATION KEY NOTES

- (E) CONCRETE MASONRY WALL TO REMAIN.
- (2) LINE OF (E) CONCRETE STEP BEYOND.
- 3 LINE OF (E) BENCH SEAT BEYOND.
- (E) CONCRETE BEAM TO REMAIN.
- (5) (E) CONCRETE ROOF TO REMAIN.
- 6 PORTION OF (E) STEPPED CONCRETE MASONRY WALL TO BE REMOVED AT GROUT LINE.
- (E) CONCRETE MASONRY WALL TO BE REMOVED COMPLETELY.
- (8) PORTION OF (E) STEEL COLUMN TO BE REMOVED. SEE STRUCTURAL DRAWINGS FOR EXTENT.
- (1) (N) ROLL-UP GARAGE DOOR, SEE I/A 06.

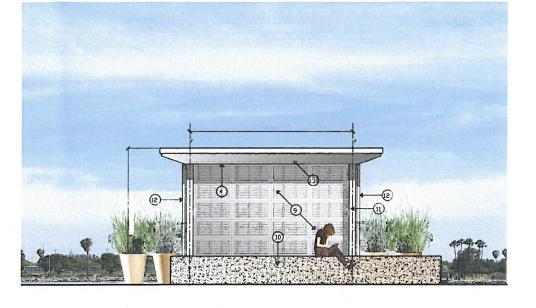



NORTH ELEVATION

SCALE: 1/4" = 1'-0"



EAST ELEVATION EAST ELEV

AETYPIC

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7 FREELON STREET SAN FRANCISCO, CA 94107 PHONE: (415) 762-8388 www.aetypic.com

ISSUE INFORMATION

Date Issue
05.05.16 PLAN CHECK SUBMITTAL
05.09.16 PLAN CHECK CLARIFICATIONS
07.28.16 CLIENT REVISIONS

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CLIENT

CITY OF LONG BEACH 333 W. OCEAN BOULEVARD LONG BEACH, CA 90802

PROJECT TITLE

3S JUDGING STAND RENOVATION 5255 E. PAOLI WAY

LONG BEACH, CA 90802

SHEET TITLE

COLOR **ELEVATIONS**

PROJECT NO. AET-13-082 SCALE

1/4" = 1'-0"

A 07

FRAMING OVER FOUNDATION PLAN SCALE: 1/4"=1"-0"

CONCRETE AND REINFORCING STEEL NOTES:

- MINIMUM CONCRETE COMPRESSIVE STRENGTH AT 28 DAYS (IF USED IN PROJECT):
 1.1 CONCRETE GRADE BEAMS:
 4.500 PSI, MIN.
- 1.1 CONCRETE GRADE BEAMS: 4,500 F 1.2 SLAB ON GRADE: 4,500 F 1.3 CONCRETE PILES: 4,500 F
- 2. CEMENT PER ASTM C150, TYPE V (U.N.O)
- 3. MAXIMUM SLUMPS FOR:
- 3.1 SLAB ON GRADE: 4" MAX. 3.2 ALL OTHER CONCRETE: 5" MAX.
- DIMENSIONS LOCATING REBARS ARE TO THE CENTER OF REBARS (U.N.O.) CONCRETE COVER OF ALL REBARS SHALL BE AS FOLLOWS: (U.N.O.)
- 4.1 CONCRETE CAST AGAINST SOIL: 3"
 4.2 CONCRETE EXPOSED TO SOIL OR WEATHER: 2"
- REINFORCING STEEL PER ASTM A615/A615M, GRADE 40 FOR #4 AND SMALLER BARS. GRADE 60 FOR #5 AND LARGER BARS.
- 6. ANCHOR BOLTS, DOWELS AND OTHER EMBEDED ITEMS SHALL BE SECURED IN THEIR DESIGN LOCATIONS BEFORE PLACING CONCRETE
- 7. REFER TO ARCHITECTURAL DRAWINGS FOR ANY DIMENSIONS NOT SHOWN IN THIS DRAWING

STRUCTURAL STEEL NOTES:

- 1. STRUCTURAL STEEL SHALL CONFORM TO ASTM STANDARDS AS FOLLOWS:
 STEEL SHAPES, MISCELLANEOUS IRON, PLATES AND BARS: ASTM A-36
 W-SHAPE, ASTM A-992, GRADE 50.
 STEEL PIPE: ASTM A-50, GRADE B.
 STEEL TUBE: ASTM A-50, GRADE B.
 HSS-TOUND: ASTM A-500, GRADE B.
 HSS-TOUSE: ASTM A-500, GRADE B.
 ANCHOR BOLTS: ASTM A-307
 ASTM A-55, GRADE B.
- 2. ERECTION AND FABRICATION SHALL BE PER LATEST AISC STEEL CONSTRUCTION MANUAL
- 3. WELDING SHALL BE DONE BY ELECTRIC ARC PROCESS PER AWS STANDARD CODE FOR ARC AND GAS WELDING IN BUILDING CONSTRUCTION. WELDERS SHALL BE CERTIFIED BY THE GOVERNING JURISDICTIONS
- PROVIDE SHOP DRAWINGS FOR REVIEW BY ARCHITECT AND/OR STRUCTURAL ENGINEER PRIOR TO FABRICATING STEEL
- SHOP WELDING SHALL BE PERFORMED IN A SHOP APPROVED BY THE GOVERNING JURISDICTIONS. USE SHIELDED ELECTRIC ARC PROCESS AND E-70 SERIES ELECTRODES. ALL FIELD WELDING SHALL BE PERFORMED BY A CERTIFED WELDER. ALL WELDING SHALL CONFORM TO LATEST AWS SPECIFICATIONS (U.N.O.)
- 6. SPECIAL INSPECTION BY A CERTIFIED INSPECTOR IS REQUIRED FOR ALL FIELD WELDING 7. GALVANIZATION OF STEEL SHALL BE PROVIDED PER PROJECT SPECIFICATIONS

FOUNDATION NOTES:

- FOUNDATION HAS BEEN DESIGNED BASED ON SOIL REPORT NUMBER A9383-06-01 PREPARED BY GEOCON WEST., INC DATED 04/05/2016. REFER TO THIS REPORT FOR ANY PERTINENT INFORMATION.
- FILL SHALL BE PLACED IN 6" TO 8" LOOSE LIFTS AND COMPACTED BY MECHANICAL METHODS
- 3. ALL FILL SHALL BE COMPACTED TO 90% OF THE MAXIMUM DENSITY AT OPTIMUM MOISTURE CONTENT AS DETERMINED BY ASTM 1557
- ASIM 1537

 1. GRADING, SHORING AND FOUNDATION PLANS SHOULD BE REVIEWED BY A REPRESENTATIVE OF GEOCON WEST, INC. PRIOR TO FINALIZATION TO VERIFY THAT THE PLANS HAVE BEEN PREPARED IN SUBSTANTIAL CONFORMANCE WITH THE RECOMMENDATIONS OF THIS REPORT AND TO PROVIDE ADDITIONAL ANALYSES OR RECOMMENDATIONS
- DEEPENED FOUNDATION INSTALLATION HAS BEEN PREPARED BY SOILS ENGINEER AND CONTRACTOR SHALL BE RESPONSIBLE TO FOLLOW THE RECOMMENDATIONS OF THE REPORT

THE CONTRACT DOCUMENT REPRESENT THE FINISHED STRUCTURE. THEY DO NOT INDICATE THE MEANS AND METHOD OF CONSTRUCTION. THE CONTRACTOR SHALL PROVIDE ALL MEANS NECESSARY TO PROTECT THE STRUCTURE DURING CONSTRUCTION. SUCH MEASURES SHALL INCLUDE, BUT NOT LIMITED TO, BRACING, SHORING AND LOADS DUE TO CONSTRUCTION EQUIPMENT, ETC.


SCHEDULE OF SPECIAL INSPECTION


	TASK	FREQUENCY OF INSPECTION	APPROVED AGENCY			
	PILES & GRADE BEAMS	PERIODIC	N.S.	STRUCTURAL	ENGINEERING,	INC.
Ī					1000	


NOTES: THE SPECIAL INSPECTOR SHALL BE APPROVED BY THE CITY AND THE OWNER AND SHALL FURNISH INSPECTION REPORTS TO THE CITY AND THE E.O.R.

DESIGN INFORMATION

RDL	FDL	RLL	FLL	V	Cs	R	Sm	Sps	SITE	Sı	Ss	O.C.	I	SDC
83 psf		20 psf		24 psf	0.16	3	0.584g	1.044g	D	0.584g	1.566g	11	1.0	D

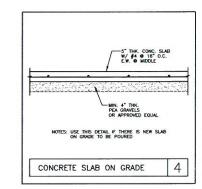

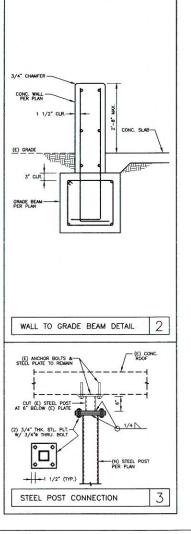

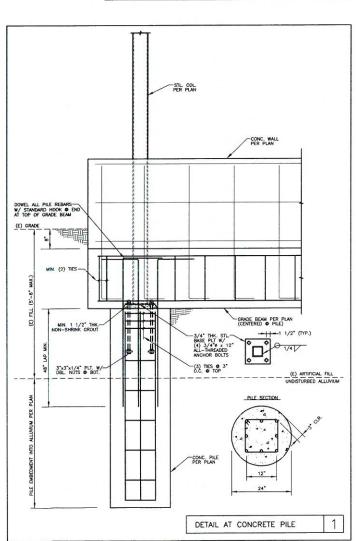

IT IS THE CONTRACTOR'S RESPONSIBILITY TO VERIFY ALL GRADES, DIMENSIONS, (E) FRAMING, (E) FOUNDATION AND SITE CONDITIONS AND TO PROVIDE SHORING IF NECESSARY BEFORE REMOVAL OF ANY PART OF THE (E) STRUCTURE. THE CONTRACTOR SHALL READ THE SOILS REPORT PREPARED BY GEOCON WEST, INC. PRIOR TO ANY WORK.

THE E.O.R. SHALL BE INFORMED OF ANY CHANGES

ANY WUNK.
THE E.O.R. SHALL BE INFORMED OF ANY CHANGES
AND/OR DISPOREPANCIES THAT MAY RESULT IN
ALTERING THE APPROVED CONDITIONS PRIOR TO
COMMENCING OR CONTINUING CONSTRUCTION WORK.

STRUCTURAL OBSERVATION PROGRAM AND DESIGNATION OF THE STRUCTURAL OBSERVER

PROJECT ADDRESS: 5265 EAST PAOLI WAY, LONG BEACH, CA

Description of Work: 3S JUDGING STAND RENOVATION

Owner: CITY OF LONG BEACH. Architect: AETYPIC Engineer: Mr. Neal Shah, S.E.

		L OBSERVATION Items are required)	
Firm or Individual to be respons Name: NS Structural Engineerin			Registration: \$510
FOUNDATION	WALL	FRAME	DIAPHRAG
☐ Footing, Stem Walls, Piers		☐ Steel Moment Frame	Concrete
☐ Mat Foundation	☐ Masonry	☐ Steel Braced Frame	☐ Steel Deck
☑ Caisson, Piles, Grade Beams	□ Wood	☐ Concrete Moment Frame	□ Wood
☐ Stepp'g/Retain'g Foundation, Hillside Special Anchors	☐ Others:	☐ Masonry Wall Frame	□ Others:
Others:		□ Others:	

DECLARATION BY OWNE

I, the Owner of the project, declare that the above listed firm or individual is hired by me to be the Structural Observer.

ire

DECLARATION BY ARCHITECT OR ENGINEER OF RECORD (required if the Structural Observer is different from the Architect or Engineer of Record)


I, the Architect or Engineer of record for the project, declare that the above listed firm or individual is designated by me to be responsible for the Structural Observation.

nature

4642

SHEET

Sí

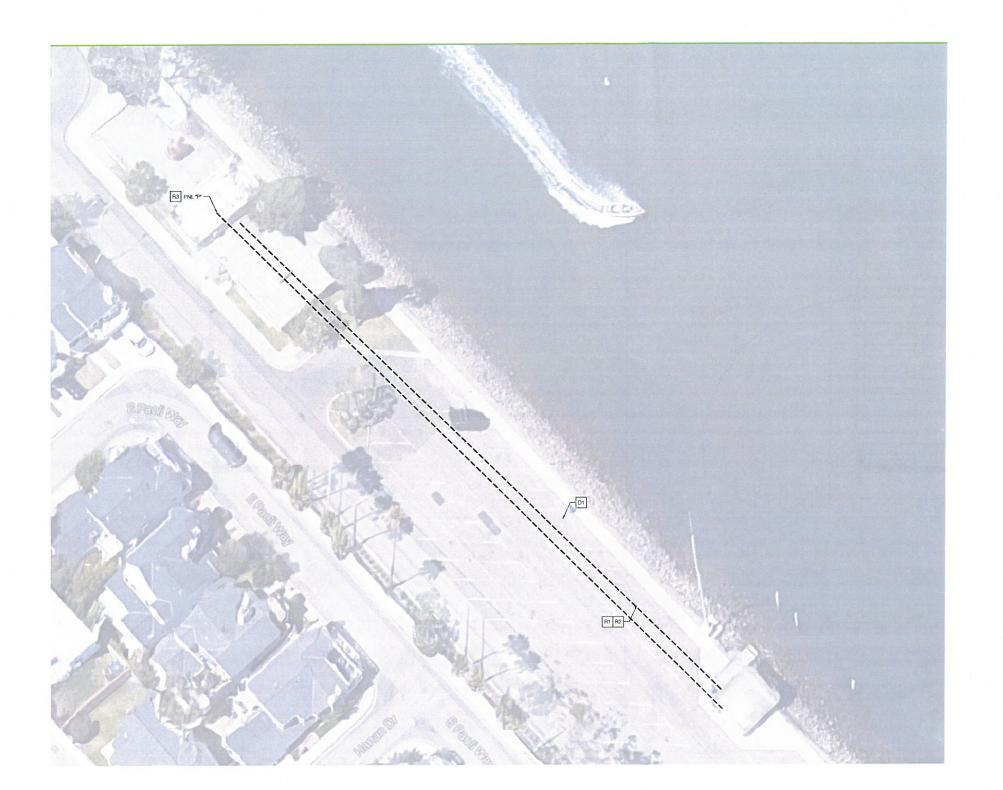

DEMOLITION NOTES

DISCONNECT AND REMOVE EXISTING UNDERGROUND CONDUIT, INICLUDING ALL ASSOCIATED HARDWARE, AND WIRING BACK TO SOURCE, VERIFY EXACT LOCATION IN THE FIELD.

RENOVATION NOTES

- R11 PROVIDE NEW 1*PVC SCHEDULE 40 UNDERGROUND CONDUIT FROM JUDGING STAND TO EXISTING PANEL "XX* INSIDE MANTENANCE SHOP. TRANSITION STUB-UP SHALL BE PVC COATED RGS.
- BE PYC COATED HGS.

 R2 USE SAME CONDUIT ROUTE OF DEMOUSHED UNDERGROUND CONDUIT TO MINIMIZE TRENCHING.

 PROVIDE NEW 20A, 1P BRANCH CIRCUIT BREAKER IN EXISTING PAREL PY SPACE INSIDE MAINTENANCE SHOP. CONTRACTOR SHALL MATCH EXISTING MAKE, TYPE AND AIC RATING, CONTRACTOR SHALL VERIFY EXACT PANEL LOCATION IN THE FIELD.

GENERAL NOTES

- CONTRACTOR SHALL VERIFY FIELD CONDITION PRIOR TO DEMOLITION AND RENOVATION.
- 2. ALL UNDERGROUND COMDUIT SHALL BE MINIMUM 1° PVC, SCHEDULE 40, UNLESS OTHERWISE NOTED WITH COATING.

 3. ALL 90 DEGREE ELBOWS AND BELOW GRADE TO ABOVE GRADE TRANSITIONS SHALL BE PVC.
- GRADE HARBITIONS SHALL BE PVC.

 A #8 GREEN GROUND WIRE SHALL BE INSTALLED
 THROUGHOUT THE CONDUIT SYSTEM IN ORDER TO
 MAINTAIN GROUNDING CONTINUITY.

 5. ALL WRITING SHOWN ON THIS PLAN SHALL BE #8 MINIMUM
 UNLESS OTHERWISE NOTED.



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P2S Engineering, Inc.

5000 East Spring Street, 8th Floor Long Beach, CA 90815-5218 T 562.497.2999 F 562.497.2990

www.p2seng.com

ISSUE INFORMATION

Date Issue 05-05-16 PLAN CHECK SUBMITTAL

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FACILITY

CITY OF LONG BEACH 333 W. OCEAN BOULEVARD LONG BEACH, CA 90802

PROJECT TITLE

3S JUDGING STAND RENOVATION

5255 E. PAOLI WAY LONG BEACH, CA 90802

SHEET TITLE


SITE PLAN **DEMOLITION AND RENOVATION PLAN**


PROJECT NO.

AET-13-082

1" = 20'

E-2

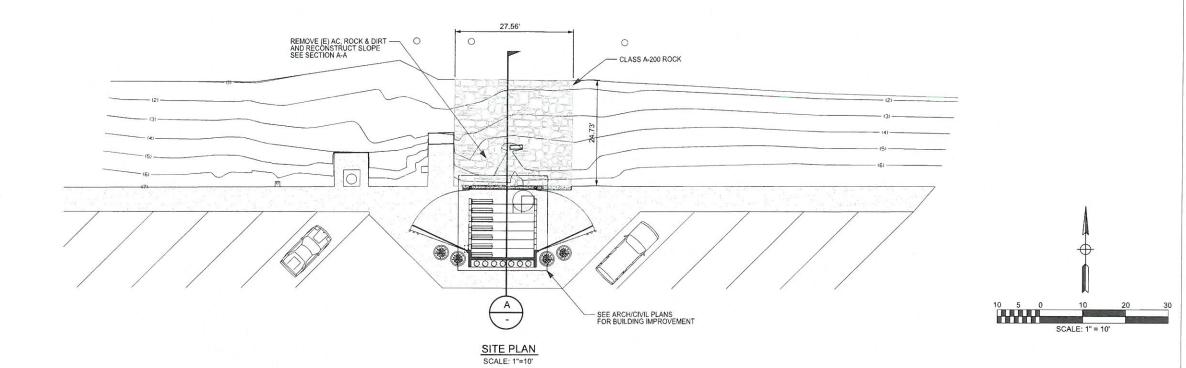

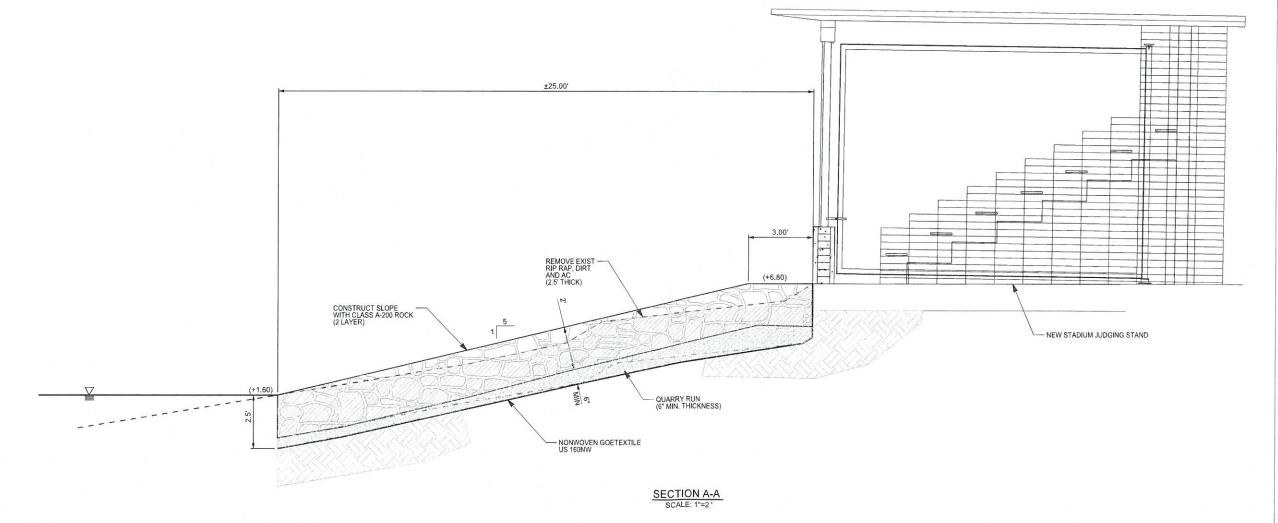



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PROJECT TITLE

3S JUDGING STAND RENOVATION 5255 E. PAOLI WAY

LONG BEACH, CA 90802

SHEET TITLE

RIP RAP PLAN

PROJECT NO.

AET-13-082

SCALE

AS NOTED