EXHIBIT B



H) HOWARDICDM



04 / 12 / 16

PROJECT NUMBER 15.550

SHEET TITLE TITLE SHEET & PROJECT INFO


MICHAEL'S ON NAPLES

SECOND FLOOR ROOF DECK REMODEL and ADDITION 5620 EAST SECOND STREET LONG BEACH, CA 90803


FIRE NOTES		ABBREVIATIONS	PROJECT SUMMARY	SHEET INDEX
PARTITIONS / CEILINGS 1. ANY DECORATIONS USED SHALL BE NON-COMBUSTIBLE OR FLAME-PROOFED IN AN APPROVED MANNER. 2. INTERIOR WALL AND CEILING FINISHES FOR EXIT CORRIDORS SHALL NOT EXCEED A FLAME SPREAD RATING OF 75 (CLASS II). 3. INTERIOR WALL AND CEILING FINISHES SHALL BE TESTED AS SPECIFIED IN SECTION 803. 4. CEILING TILES, IF USED, SHALL BE MINERAL TILES WITH LISTED LABEL AND FLAME SPREAD RATING OF 25 OR LESS. 5. AISLES LEADING TO REQUIRED EXITS SHALL HAVE A MINIMUM WIDTH OF 3'-8" CLEAR. 6. EVERY EXIT DOOR SHALL BE OPERABLE FROM THE INSIDE WITHOUT THE USE OF A KEY OR ANY SPECIAL KNOWLEDGE OR EFFORT. SPECIAL LOCKING DEVICES SHALL BE OF AN APPROVED TYPE. 7. EXIT DOORS SHALL SWING IN THE DIRECTION OF EXIT TRAVEL WHEN SERVING 50 OR MORE OCCUPANTS. 8. EXIT PATH LIGHTING SHALL BE PROVIDED FOR STAIRWAYS, HALLWAYS, EXIT PASSAGEWAYS AND EGRESS TO A PUBLIC WAY WHENEVER THE BUILDING IS OCCUPIED. EMERGENCY LIGHTING SHALL BE PROVIDED GIVING A LIGHT VALUE OF ONE FOOT-CANDLE AT THE FLOOR LEVEL. 9. PROVIDE EXIT SIGNS AND DIRECTIONAL EXIT SIGNS WITH A MINIMUM OF 6" HIGH BY 3/4" STROKE BLOCK LETTERS ON A CONTRASTING BACKGROUND. 10. WHENEVER BUILDING IS OCCUPIED. EXIT SIGNS SHALL BE LIGHTED SO THEY ARE CLEARLY VISIBLE. 11. EXIT SIGNS SHALL BE ELECTRICALLY ILLUMINATION.	ACOUS, ACOUSTICAL ADJ. ADJUSTABLE ALUM. ALUMINUM ALT. ALTERNATE APPROX. APPROXIMATE APPROXIMATE APPROXIMATE APPROXIMATE APPROXIMATE ARCHITECTURAL A.F.F. ABOVE FINISH FLOOR B BLDG. BUILDING C CAB. CABINET CLOS. CLOSET CLING CLOS. CLOSET CLR. CLEAR COL. COLUMN CONC. CONCRETE D DEPT. DEPARTMENT DIA. DIAMETER DIM. DIM. DIAMETER DIM. DIAMETER DIM. DIM. DIAMETER DIM. DIM. DIAMETER DI	H HDWR. HARDWARE HDWD. HARDWOOD H.M. HOLLOW METAL HVAC HEATING, AND VART CONDITIONING H.W. HOT WATER I INCL. INCLUDE(D)(ING) INFO. INFORMATION J JAN. JANITOR L ANGLE LB. (OR #) POUND M MAX. MAXIMUM MECH. MECHANICAL MFR. MANUFACTURER MIN. MINIMUM MISC. MISCELLANEOUS N	BUILDING NUMBER OF STORIES: TWO CONSTRUCTION TYPE: V-B OCCUPANCY GROUP: A-2/B MIXED OCCUPANCY: NO FIRE SPRINKLERS: NO FIRE SPRINKLERS: NO EXITS REQUIRED: 2 EXITS PROVIDED: 2 OWNER MICHAEL'S RESTAURANT GROUP, INC. 5618 EAST SECOND STREET LONG BEACH, CA 90803 (562) 439-7080 ATTN: MASSIMO ARONNE ENGINEER CASTILLO ENGINEERING 1205 PINE AVENUE LONG BEACH, CA 90813 (714) 725-8320 ATTN: MARGRITO CASTILLO DESIGNER TURPIN DESIGN GROUP, INC. 3745 LONG BEACH BOULEVARD SUITE 220	ARCHITECTURAL A1 TITLE SHEET, NOTES, VICINITY MAP N1 GENERAL NOTES N2 DISABLED ACCESS NOTES N3 DISABLED ACCESS NOTES N4 DISABLED ACCESS NOTES N4 DISABLED ACCESS NOTES SP1 SITE PLAN A2 SECOND FLOOR PLAN A3 SECOND FLOOR EQUIPMENT PLAN A4 REFLECTED CEILING PLAN A5 EXTERIOR ELEVATIONS & SECTION A6 GREASE HOOD DRAWING A7 GREASE HOOD DRAWING A8 GREASE HOOD EXHAUST DRAWING A8 GREASE HOOD EXHAUST DRAWING K02.1 FIRST FLOOR KITCHEN EQUIPMENT SCHED. K04.0 FIRST FLOOR KITCHEN PLAN STRUCTURAL S1.0 STRUCTURAL NOTES S1.1 TYPICAL DETAILS S2.0 FOUNDATION PLAN
11. EXIT SIGNS SHALL BE ELECTRICALLY ILLUMINATED. TWO LAMPS SHALL BE ENERGIZED FROM SEPARATE CIRCUITS. ILLUMINATION SHALL NORMALLY BE PROVIDED BY THE PREMISES WIRING SYSTEM. IN THE EVENT OF FAILURE OF THIS SYSTEM, ILLUMINATION SHALL BE AUTOMATICALLY PROVIDED FROM AN INTEGRAL BATTERY BACKUP SYSTEM. EMERGENCY LIGHTING SHALL GIVE A VALUE OF ONE FOOT-CANDLE AT FLOOR LEVEL. FIRE EXTINGUISHERS 12. PROVIDE PORTABLE FIRE EXTINGUISHERS IN RECESSED CABINETS, WITH A RATING OF NOT LESS THAN 2-A 10-B.C. LOCATE EXTINGUISHERS SO THAT THERE IS LESS THAN (75) FOOT TRAVEL DISTANCE TO ALL PORTIONS OF THE BUILDING SPACES, OR AS REQUIRED BY FIRE DEPARTMENT FIELD INSPECTOR. FIRE NOTES FIRE NOTES	ELEC. ELECTRIC EQ. EQUAL EQUIP. EQUIPMENT EXIST. EXISTING F. FIRE EXTINGUISHER FIN. FINISH(ED) FT. FOOT OR FEET	N.I.C. NOT IN CONTRACT NO.(CR #) NUMBER N.T.S. NOTTO SCALE O O.C. ON CENTER OPPOSITE P PART. BD. PARTICLE BOARD PLAM. PLASTIC LAMINATE	LONG BEACH, CA 90807 ATTN: MARK TURPIN (562) 427-3901 ARCHITECT RICARDO S, GUINA 2915 RED HILL AVENUE SUITE G102 COSTA MESA, CA 92626 ATTN: RICK GUINA (949) 338-6420	S2.1 FLOOR / LOW ROOF FRAMING PLAN S2.2 ROOF FRAMING PLAN S3.0 SHADE STRUCTURE & FLOOR DETAILS S3.1 SHADE STRUCTURE DETAILS
 IN BUILDINGS OF GROUP 'A' OCCUPANCY HAVING AN OCCUPANT LOAD OF 300 OR LESS, THE MAIN EXTERIOR DOORS ARE PERMITTED TO BE EQUIPPED WITH KEY-OPERATED LOCKING DEVICES FROM THE EGRESS SIDE PROVIDED: 13.1. THE LOCKING DEVICE IS READILY DISTINGUISHABLE AS LOCKED. 13.2. A READILY VISIBLE AND DURABLE SIGN IS POSTED ON THE EGRESS SIDE ON OR ADJACENT TO THE DOOR STATING, "THIS DOOR TO REMAIN UNLOCKED WHEN BUILDING IS OCCUPIED", THE SIGN SHALL BE IN LETTERS 1" HIGH ON A CONTRASTING BACKGROUND. 13.3. THE USE OF A KEY-OPERATED LOCKING DEVICE IS REVOCABLE BY THE BUILDING OFFICIAL DUE TO CAUSE. 14. DOORS OPENING INTO THE PATH OF EGRESS TRAVEL SHALL NOT REDUCE THE REQUIRED WIDTH TO LESS THAN ONE HALF DURING THE COURSE OF SWING. WHEN FULLY OPEN. THE DOOR SHALL NOT PROJECT MORE THAN 7" INTO THE REQUIRED WIDTH. 15. PLANS FOR DEFERRED SUBMITTAL ITEMS SHALL BE SUBMITTED TO LBDS FOR APPROVALAT LEAST 60 DAYS PRIOR TO INSTALLATION. DEFERRED SUBMITTALS: PLANS SHALL BE SUBMITTED UNDER SEPARATE PERMIT TO FIRE PLAN CHECK FOR THE FOLLOWING: FIRE HOOD SUPPRESSION SYSTEM. 	GD GARBAGE DISPOSAL GA GAUGE G.F.I. GROUND FAULT ISOLATED GL GLASS OR GLAZED GYP. BD. GYPSUM BOARD	T TEL. TELEPHONE TEMP. TEMPERED TYP. TYPICAL U U.O.N. UNLESS OTHERWISE NOTED V VERT. VERTICAL VEST. VESTIBULE VERIFY IN FIELD R RECEP. RECEPTACLE REF. REFERENCE REO D. REQUIRED REV. F. SUSION S S.C. SOLID CORE SIM. SIMILAR SQL AR SQL	CODE COMPLIANCE THIS PROJECT SHALL COMPLY WITH ALL RELEVANT PARTS OF THE 2013 EDITION OF CALIFORNIA BUILDING STANDARDS CODES (a.k.a. TITLE-24 AND THE CALIFORNIA CODES OF REGULATIONS) PART 1 ADMINISTRATIVE CODE PART 2 CALIFORNIA BUILDING CODE (CBC) PART 3 CALIFORNIA BUILDING CODE (CBC) PART 4 CALIFORNIA BUECHANICAL CODE (CBC) PART 5 CALIFORNIA PLUMBING CODE (CPC) PART 6 CALIFORNIA PLUMBING CODE (CPC) PART 7 (CURRENTLY VACANT) PART 9 CALIFORNIA ENERGY CODE PART 10 CALIFORNIA EXISTING BUILDING CODE PART 11 CALIFORNIA SETSING BUILDING STANDARDS CODE (CALIGREN) PART 12 CALIFORNIA GREEN BUILDING STANDARDS CODE (CALIGREN) PART 12 CALIFORNIA CREEN BUILDING STANDARDS CODE (CALIGREN) PART 15 CALIFORNIA GREEN BUILDING STANDARDS CODE (CALIGREN) PART 10 CALIFORNIA GREEN BUILDING STANDARDS CODE (CALIGREN) PROJECT DESCRIPTION! REMODEL TO EXISTING SECOND FLOOR ROOF DECK.	MECHANICAL UNDER SEPARATE PLAN CHECK & PERMIT ELECTRICAL UNDER SEPARATE PLAN CHECK & PERMIT PLUMBING UNDER SEPARATE PLAN CHECK & PERMIT GREASE HOOD ANSUL FIRE PROTECTION UNDER SEPARATE PLAN CHECK & PERMIT REGISTERED INSPECTOR REQUIRED FOR THE FOLLOWING WORK: 1. WELDING 2. STRUCTURAL STEEL
		STD. STANDARD STL. STEEL W (V) WEST W WITH W.C. WALL COVERING WD WOOD W.H. WATER HEATER	INSTALLATION OF A NEW POWER-RETRACTABLE FABRIC ROOF SHADE STRUCTURE. NEW SECOND FLOOR KITCHEN IN EXISTING WINE STORAGE ROOM, ADDITION OF AN OPEN-AIR CUSTOMER WAITING SOOD DECK. ELECTRICAL, MECHANICAL, PLUMBING, FIRE SPRINKLERS & FIRE/LIFE SAFETY WORK SHALL BE PERFORMED UNDER SEPARATE PLAN CHECK & PERMITS. DESCRIPTION OF USE: FOOD & LIQUOR AREA OF WORK THIS PERMIT: EXISTING 1ST FLOOR: 2.243 S.F. (NO WORK) EXISTING 2ND FLOOR ROOF DECK: 1.767 S.F. NEW ROOF DECK WAITING AREA: 518 S.F. TOTAL THIS PERMIT: 2.285 S.F. LEGAL DESCRIPTION:	PROJECT

SITE PLAN GENERAL NOTES


- GENERAL CONTRACTOR SHALL CONTACT UNDERGROUND SERVICE
 ALERT (USA) 800-422-4133 (48) HOURS PRIOR TO ANY SITE
 CONSTRUCTION TO DETERMINE THE LOCATIONS OF EXISTING
 UNDERGROUND UTILITIES.
- ALL EXISTING IMPROVEMENTS THAT ARE NOT BEING REMOVED OR REMODELED SHALL BE PROTECTED THROUGHOUT THE COURSE OF CONSTRUCTION. ANY DAMAGE CAUSED BY CONSTRUCTION ACTIVITIES SHALL BE REPAIRED TO PRE-CONSTRUCTION CONDITION WITHOUT ADDITIONAL COST TO THE OWNER.

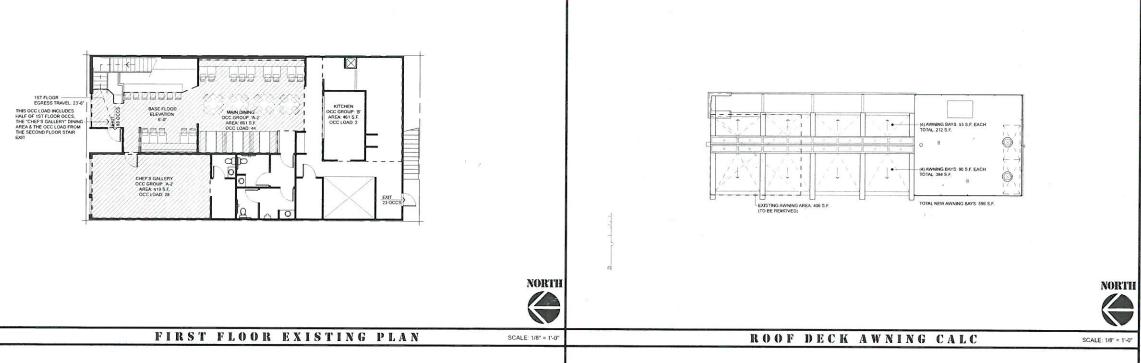

NORTH

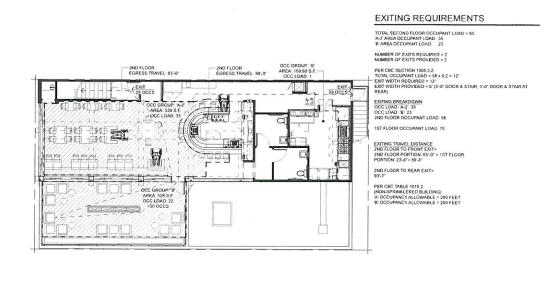

SECOND FLOOR EXITING PLAN

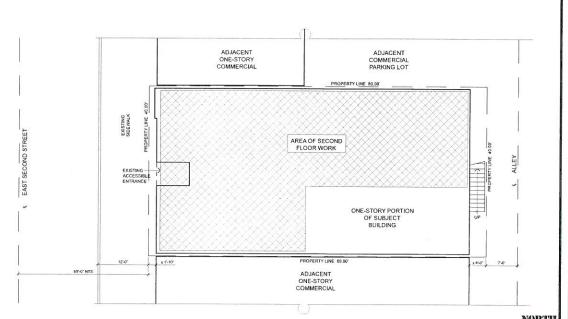

SITE PLAN

NORTH

SCALE: 1/8" = 1'-0"

TURPIN DESIGN GROUP, INC.
3745 LONG BEACH BOULEVARD
SUITE 220
LONG BEACH, CA 90807
562. 427.3901

H HOWARDICDM



MICHARL'S ON NAPLES
ROOF DECK REMODEL
5620 EAST SECOND STREET
LONG BEACH, CA 90803

PLOT DATE 04 / 12 / 16

REVISION

PROJECT NUMBER 15.550

SHEET TITLE ARCHITECTURAL SITE PLAN

SHEET NUMBER

- 2. HINGE-SIDE OF DOOR OPENINGS IN PARTITIONS NOT DIMENSIONED ARE TO BE LOCATED WITHIN 4" OF ADJOINING PARTITIONS.
- 3. PROVIDE 5/8" THICK TYPE "X" GYPSUM BOARD THROUGHOUT, U.O.N.
- ALL GLASS USED IN PROJECT SHALL BE TEMPERED AND ANY EXPOSED EDGES SQUARE-POLISHED.
- VERIFY FIRE DEPARTMENT REQUIREMENTS FOR FIRE EXTINGUISHE GENERAL CONTRACTOR SHALL BE RESPONSIBLE FOR CONFIRMING AND LOCATION OF FIRE EXTINGUISHERS WITH THE FIRE MARSHAL.
- 8. PROVIDE BACKING FOR ALL MILLWORK, APPLIANCES AND FIXTURES.
- POSTA PERMANENT SIGN ABOVE THE FRONT EXIT DOOR STATING: "THIS DOOR SHALL REMAIN UNL OCKED WHENEVER THE SPACE IS OCCUPIED". SIGN SHALL BE IN MINIMAM IT HIGH LETTERS, OF A COLOR CONTRASTING TO THE BACKGROUND SIGN IS MOUNTED UPON.
- 10. A SIGN SHALL BE POSTED IN A CONSPICUOUS LOCATION NEAR THE MAIN EXIT STATING THE MAXIMMAN LLOWABLE NUMBER OF OCCUPANTS. SIGN SHALL COMPLY WITH CECTIONS AND SHALL BE OF AN APPROVED LEGIGLE AND PERSIAMENT DESIGN. SIGN SHALL BE MANTANED BY THE TENMIT. SIGN SHALL STATE: "TOTAL MAXIMAN OCCUPANT LOAD. SE PERSONS"
- 11, ALL CEILING AND WALL FINISHES THROUGHOUT SHALL HAVE A MINIMUM CLASS 'C' FLAME SPREAD CLASSIFICATION PER (CFC TABLE 803.3)

DOOR SCHEDULE

ROOM DESCRIPTION	SIZE	RM NO.	DR ID	FR.	HDWR SET	REMARKS
NOTUSED			-	-	20-0	
REAR EXIT	3'-6"x7'-0"	206	-		1.0	(E) DOOR & FRAME - SEE NOTE '1' BELOW
(E) RESTRM	3'-0"x7'-0"	204				(E) DOOR & HARDWARE
(E) RESTRM	3'-0'x7'-0"	205		-		(E) DOOR & HARDWARE
KITCHEN	3'-0"x7'-0"	207	A	.1	a	ELIASON P.L. FACES, SAFETY GL VIEW PNL
WAITING	3'-0"x8'-6"	203	8	2	b	NO CLOSER AT THIS DOOR
ACCESS GATE	3'-0"x5'-0"	203	С		c	
(E) STAIR	2'-10"x6'-8"	200	D	3	d	SEE NOTE 2 BELOW
				_	-	
	DESCRIPTION NOT USED REAR EXIT (E) RESTRM (E) RESTRM KITCHEN WAITING ACCESS GATE	DESCRIPTION SIZE NOT USED REAR EXIT (E) RESTRM 3-0"X7-0" (E) RESTRM 3-0"X7-0" KITCHEN 3-0"X7-0" ACCESS GATE 3-0"x5-0" 3-0"x5-0"	DESCRIPTION SIZE NO. NOT USED 206 (E) RESTRM 3-0'x7-0' 206 (E) RESTRM 3-0'x7-0' 205 KITCHEN 3-0'x7-0' 205 KITCHEN 3-0'x7-0' 207 ACCESS GATE 3-0'x5-0' 203	DESCRIPTION SIZE NO. 10 NOT USED REAR EXIT 3-6"x7-0" 206 - (E) RESTRAM 3-0"x7-0" 205 - (E) RESTRAM 3-0"x7-0" 207 A NITCHEN 3-0"x7-0" 207 A WAITING 3-0"x8-6" 203 C ACCESS GATE 3-0"x8-0" 203 C	DESCRIPTION SIZE NO. 10 10 NOT USED REAR EXIT 3-6"X"-0" 206	DESCRIPTION SIZE NO. 00 10 SET

B: SWING-TYPE STOREFRONT C: SWING-TYPE HARDI-TRIM GATE ON PAINTED STEEL FRAME.

FRAME IDENTIFICATION: 1: CLEAR ANODIZED BY ELIASON. 2 SITE-BUILT HARDI-TRIM.

COCKSET. ADA LEVER WI INTEGRAL
CYL LOCK
CLEAR ANODIZED
DOOR STOP.
OPERATOR:
CLEAR ANODIZED ADA
COMPLIANT AUTOMATIC DO
OPENER.
THRESHOLD:
ADA COMPLIANT CLEAR
ANODIZED
ANODIZED ADA
ANODIZED

NOTE MANUAU OFERATING FARCE FOR ALL DOORS SHALL BY EXCEPT 8, 881 MOTE MEASURE PERSONS DOORS SHALL BE REQUITE PROVIDE MANUAU FOR FORCE THE ADMICTS TO SHALL BE REQUITED THE MODIFICATION OF THE PROVIDE AND FINISHES SHALL BY THE DOORS ARE RECOGNIMALS AS DOORS. MEMORS OR SIMILAR REFLECTING METERALS SHALL BY SEE USED ON MANAS OF ECRESS DOORS. MEANS OF ECRESS DOORS SHALL NOTE BE CONCEALED BY CURTINAS, DOARS. DECORPORTIONS OR SHALL NOTE BE CONCEALED SHALL BY ADDRESS DOORS.

NOTE 11: IN ACCORDANCE WITH UL 305, MAXIMUM UNLATCHING FORCE SHALL NOT EXCEED 15.1 IS

WIN NO.	ROOM DESCRIPTION	SIZE	RM NO.	REMARKS
01	(E) DINING	6'-6"x4'-0"	201	2-SASH BI-PASS SLIDER
02	(E) DINING	10"-7"x4"-0"	201	4-SASH BI-PASS SLIDER
03	(E) DINING	10'-7"x4'-0"	201	4-SASH BI-PASS SLIDER
04	(E) DINING	16'-2"x4'-0"	201	6-SASH BI-PASS SLIDER
05	NOT USED			
06	(E) DINING	SEE ELEV	201	FIXED CLERESTORY
07	(E) DINING	SEE ELEV	201	FIXED CLERESTORY


WINDOWS '01'-'04', '06' & '07' SHALL BE DUAL GLAZED, TEMPERED GLASS, S4S RED CEDAR WITH NO BUG SCREENS

(E) T.O. ROOF +8'-8" (E) SOFFIT +7'-3 1/4" ←19 (E) T.O. ROOF +10'-8" (E) SOFFIT +7'-3 1/4" (E) ROOF SLOPE 26 A5 (-19





NORTH

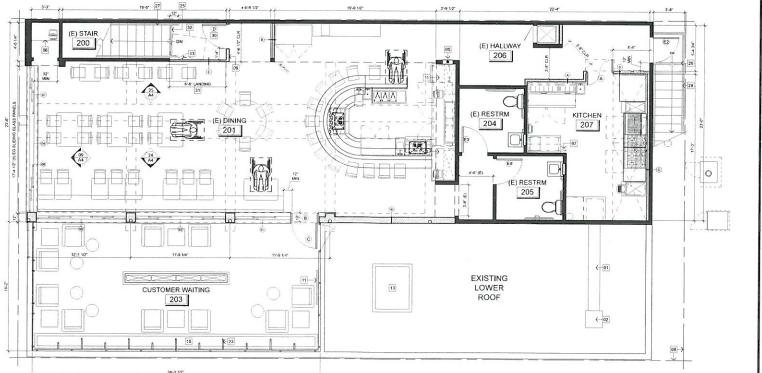

ROOF DECK PLAN

SCALE: 1/4" = 1'-0

KEYNOTES

- EXISTING EXPOSED ROOF TOP HOOD EXHAUST DUCT PROTECT IN PLACE
- 22 EXISTING ROOF TOP HOOD EXHAUST FAN PROTECT IN PLACE
- 33 STONE BAR TOP AT +42" A.F.F. WITH 2" WATERFALL EDGE.
- 5 2A-10BC FIRE EXTINGUISHER IN SURFACE MOUNTED WALL CABINET VERIFY LOCATION WITH FIRE MARSHAL
- 07 TYPE K: FIRE EXTINGUISHER SEE KITCHEN EQUIPMENT DRAWINGS.

- WALL-MOUNTED TELEVISION SEE POWER & DATA PLAN.
- NEW ROOF EQUIPMENT SCREEN SEE DETAIL 24/A5.
- NEW HVAC UNIT SEE MECHANICAL DRAWINGS.
- NEW HOOD EXHAUST VENT FANS SEE HOOD & MECHANICAL DRAWINGS
- OUTLINE OF NEW HOOD BELOW ROOF SEE HOOD, MECHANICAL & STRUCTURAL

- 23 L.E.D. SCONCE LIGHTS SEE ELECTRICAL DRAWINGS.
- NEW ELECTRICAL SUB-PANEL SEE ELECTRICAL DRAWINGS.
- PIEW CARPET WITH 2" CONTRASTING STRIPE AT TOP & BOTTOM OF EACH STAIR RUN. FULL WIDTH OF STAIR, MAXIMUM 1" FROM STAIR TREAD NOSING.

- 34" HIGH x 60" WIDE ACCESSIBLE BAR DROP PER DETAIL 15/A6.
- EXTERIOR PLASTER OVER FLAT 2x4 #1 WOOD STUDS AT 12" O.C. WITH 5/8" TYPE X'
 GYPSUM WALL BOARD INTERIOR. MATCH FINISHES TO EXISTING.
 (HEIGHT OF NON-BEARING WALL 7"-3")
- 30"X48" CLEAR AREA.
- 33 PUSH BUTTON FOR AUTOMATIC DOOR OPENER AT +44" A.F.F.

NOTE: SEE EQUIPMENT PLAN SHEET A3: FOR EQUIPMENT INF

PATH OF TRAVEL

AS THE ARCHITECT OF RECORD, I HAVE SELECTED APPROPRIATE BMP'S TO EFFECTIVE MINIMAKE THE NECATIVE IMPACTS OF THIS PROJECTS CONSTRUCTION ACTIVITIES ON STORM MATER GUALITY. THE PROJECT OWNER AMO CONTRACTOR ARE AWARE THAT THE SELECTED BMP'S MUST BE INSTALLED, MONTROFED AND MAINTAINED TO ENSURE THEIR EFFECTIVENESS. THE BMP'S NOT SELECTED TO MINIME MELEMENTATION RECOUNDANT ON DEEMED NOT APPLICABLE TO THE PROPOSED CONSTRUCTION ACTIVITIES.

SIGNATURE

EXITING REQUIREMENTS

SEE SHEET SP-1

SECOND FLOOR PLUMBING FIXTURE JUSTIFICATION

& LOUNGE	NTS, PUBS S	PER 2013 CPC TABLE 422.1 and TABLE A: OCCUPANT LOAD FACTOR (OLF
GROUP A-2: GROUP B:	983 SF / 30 = 32	
TOTAL:	351 SF / 200 = 1.76 32.76 + 1.76 = 34,52 / 2 = 17 MEN / 17 WOMEN	
WATER CLOSE	TS (MALE):	(1) REQ'D.
WATER CLOSE	TS (FEMALE):	(1) REO'D.
LAVATORIES (M	MALE).	(1) REO'D.
LAVATORIES (F	EMALE):	(1) REO'D.
URINALS:		NOT REQ'D.

NORTH FIXTURES PROVIDED

MATER CLOS 1 RINALS



V DESIGN GROUP, INC. 5 LONG BEACH BOULEVARD SUITE 220 LONG BEACH, CA 90807 562 . 427 . 3901 CA 427 TURPIN 37451

HOWARDICDM




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ODEL
STREET
90803 MICHAEL'S ON PROPERTY SECOND STREET SECOND S

> PLOT DATE 04/22/16

PROJECT NUMBER 15.550

SHEET TITLE ROOF DECK PLAN UPPER ROOF PLAN

SHEET NUMBER

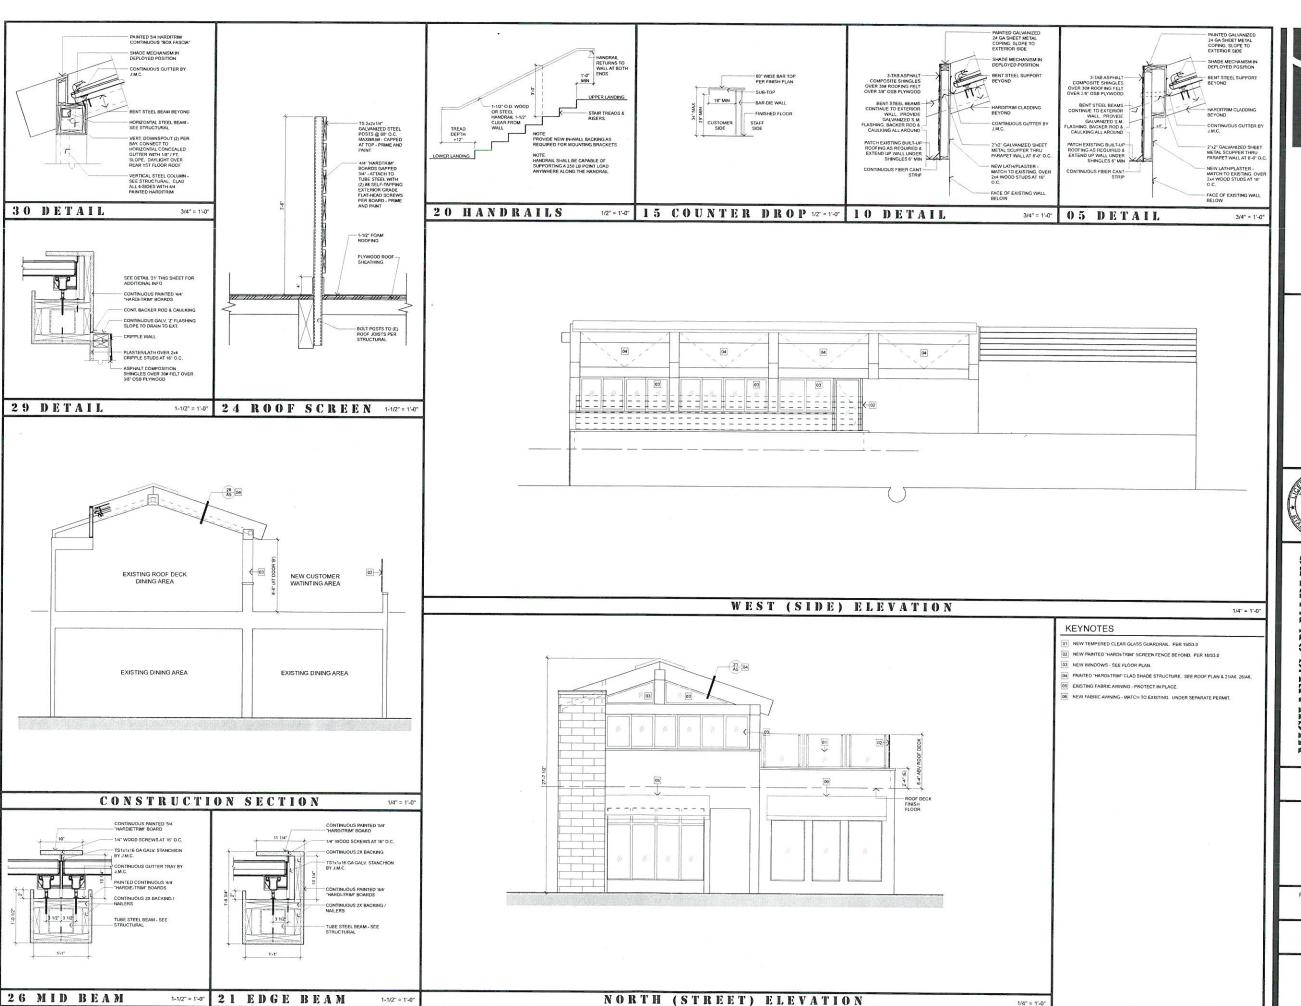



TURPIN DESIGN GROUP, IN 3745 LONG BEACH BOULEVA SUITE LONG BEACH, CA 90 562 - 427 - 3

H HOWARDICDM



MICHARL'S ON NAPLES
ROOF DECK REMODEL
5620 EAST SECOND STREET
LONG BEACH, CA 90803

PLOT DATE 04 / 12 / 16

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ELEVATIONS &


SHEET NUMBER

Michael's on Naples

CONDITIONAL USE PERMIT AMENDMENT APPLICATION PHOTOS

5620 EAST SECOND STREET, LONG BEACH, CA 90803

Existing front view

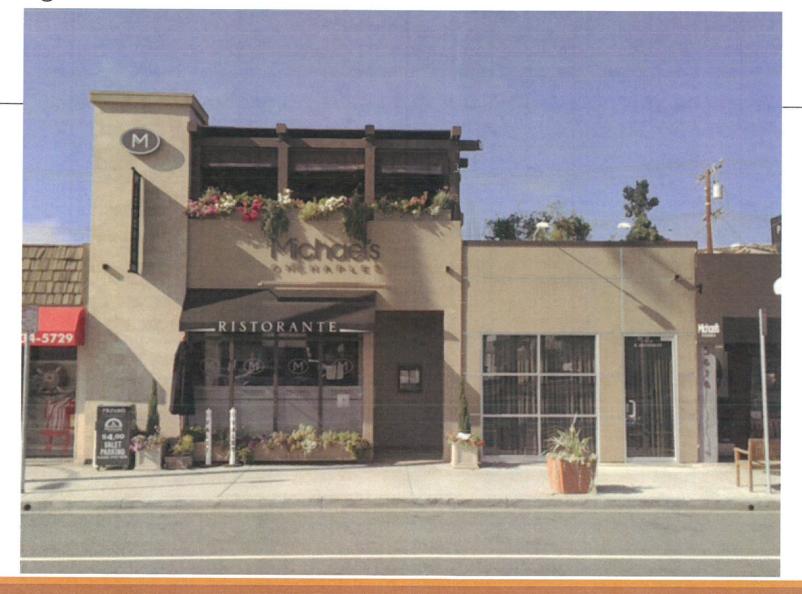

Existing Roof Deck Looking Toward Second Street




Existing Roof Deck Looking Toward Lounge Area




Existing Roof Deck Looking Toward Old Bar



Existing Roof Deck Looking Toward Old Bar

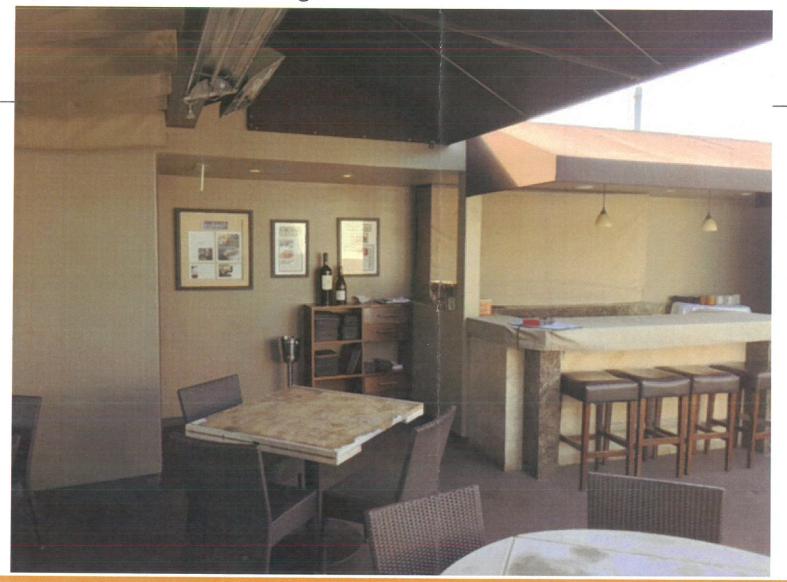

Existing Roof Deck Looking Toward Old Bar

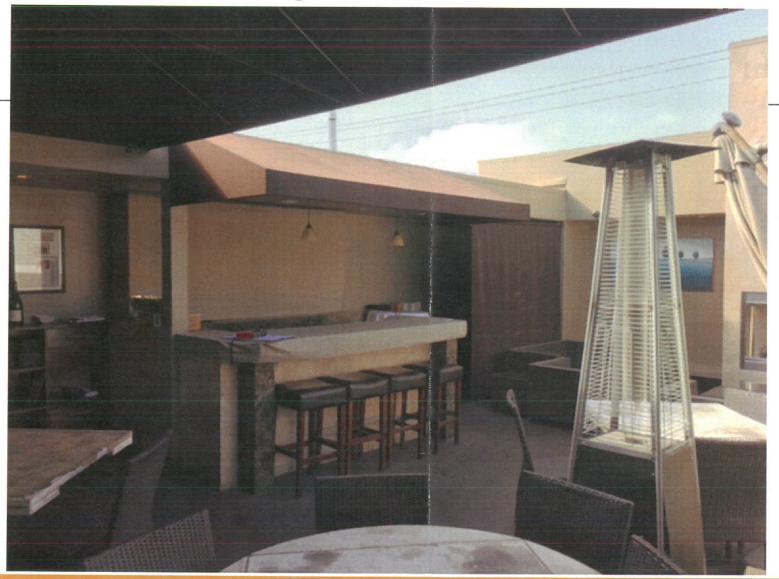

Existing Roof Deck Looking Toward Lounge Area

